

# BOUNTIFUL CITY PLANNING COMMISSION

## Tuesday, December 6, 2022 6:30 p.m.

**NOTICE IS HEREBY GIVEN** that the Bountiful City Planning Commission will hold a meeting in the Council Chambers, Bountiful City Hall, 795 South Main, Bountiful, Utah, 84010, at the time and on the date given above. The public is invited. Persons who are disabled as defined by the American with Disabilities Act may request an accommodation by contacting the Bountiful Planning Office at 298-6190. Notification at least 24 hours prior to the meeting would be appreciated.

- 1. Welcome
- 2. Approval of the minutes for November 1, 2022.
- 3. 1532 East Vineyard Drive- Lot Line Adjustment for lots 9 and 10 of Granada Hills No. 2 and Lot 6 of Moss Hill Drive Subdivision, Cody Page and Ralph Wolfe, Applicant *Engineering Director Lloyd Cheney* 
  - a. Review
  - b. Action: Consider forwarding a recommendation to the City Council
- 4. 32 West 400 South Conditional Use Permit for eight residential units, Bob Murri, applicant Senior Planner Amber Corbridge
  - a. Review
  - b. Public Hearing
  - c. Action: Consider Final Action
- 5. 32 West 400 South Preliminary/Final Architectural and Site Plan Review, Bob Murri, applicant *Senior Planner Amber Corbridge* 
  - a. Review
  - b. Action: Consider forwarding a recommendation to the City Council
- 6. 406 South Main Variance to reduce the landscape buffer, Brian Knowlton, applicant *Planning Director Francisco Astorga* 
  - a. Review
  - b. Public Hearing
  - c. Action: Consider Final Action
- 7. Election of Chairman and Vice Chairman of the Planning Commission for 2023

- 8. Approval of the 2023 Planning Commission Meeting Calendar
- 9. Planning Director's report, review of pending applications and miscellaneous business
- 10. Adjourn

#### 1 Draft Minutes of the 2 BOUNTIFUL CITY PLANNING COMMISSION 3 **November 1, 2022** 4 5 Present: **Commission Members** Alan Bott (Vice-Chair), Krissy Gilmore, Sean Monson, and Cecille Price-Huish. 6 7 8 City Attorney Clinton Drake City Engineer 9 Lloyd Cheney Planning Director Francisco Astorga 10 11 Recording Secretary Darlene Baetz 12 13 Excused: **Commission Members** Lynn Jacobs (Chair), Jim Clark, and Sharon Spratley 14 15 16 1. Welcome. 17 Vice-Chair Bott opened the meeting at 6:35 pm and welcomed all those present. 18 19 20 2. Approval of the minutes for September 20, 2022. 21 22 MOTION: Commissioner Gilmore made a motion to approve the minutes for September 20, 2022 23 as written. 24 Councilmember Price-Huish seconded the motion. 25 26 27 VOTE: 4-0 in approval. 28 29 3. Approval of the minutes for October 4, 2022. 30 MOTION: Commissioner Gilmore made a motion to approve the minutes for October 04, 2022 as 31 32 written. 33 34 Councilmember Price-Huish seconded the motion. 35 VOTE: 4-0 in approval. 36 37 38 4. Lot Line Adjustment for 4317 S Monarch Dr, Brett Murdock, Applicant – Engineering Director 39 Lloyd Cheney 40 41 Brett Murdock was not present. Engineering Director Cheney presented the staff report. 42 43 44

The applicant requested approval to combine the two lots to accommodate his plans for a future detached garage, pool and pool house on Lot 208. Lot 208 does not have a primary structure and would not be possible to issue a permit for any of the planned accessory structures until the lots are combined. There would be no new building lots created by this proposed action.

MOTION: Commissioner Gilmore made a motion to forward a positive recommendation to the City Council for the approval of the Lot Line Adjustment for 4317 S Monarch Dr.

Commissioner Monson seconded the motion.

45

46 47 48

49 50 51

VOTE: 4-0 in approval.

## 5. Lot Line Adjustment for 153 South 300 East, Larry Dupaix, Applicant - Engineering Director Lloyd Cheney

Larry Dupaix was present. Engineering Director Cheney presented the staff report.

The applicant requested approval of a lot line adjustment to combine both Lot 2 and the landlocked parcel that adjoins the rear boundary. He intends to construct a new single-family home and detached accessory structure on the proposed combined lot. Mr. Dupaix is working with the Power Department on relocation and easement issues of the power lines with both properties.

MOTION: Councilmember Price-Huish made a motion to forward a positive recommendation to the City Council for the approval of the Lot Line Adjustment for 153 South 300 East.

Commissioner Monson seconded the motion.

VOTE: 4-0 in approval.

## 6. Lot Line Adjustment for 4396 S Hidden Hollow Dr, Davis Crockett, Applicant – Engineering Director Lloyd Cheney

Davis Crocket was present. Engineering Director Cheney presented the staff report.

The applicant requested approval of a lot line adjustment of the common boundary between lots 702 and 704. The proposed adjustment does not affect the frontage of either lot and will resize both lots to similar sizes.

MOTION: Commissioner Monson made a motion to forward a positive recommendation to the City Council for the approval of the Lot Line Adjustment of 4396 S Hidden Hollow Dr.

Commissioner Gilmore seconded the motion.

VOTE: 4-0 in approval.

7. Training – Postponed to a future meeting.

8. Planning Director's report, review of pending applications and miscellaneous business.

Vice-Chair Bott adjourned the meeting at 6:47 p.m.

## **Commission Staff Report**

**Subject:** Lot Line Adjustment for Lots 9 and 10 of Granada Hills

No. 2 and Lot 6 of the Moss Hill Drive Subdivision

Address: 1532 E Vineyard Dr

**Author:** City Engineer

**Department:** Engineering, Planning **Date:** December 6, 2022



#### **Background**

Cody Page and Ralph Wolfe, applicants, are requesting approval of a lot line adjustment of the common boundary between Lot 10 of the Granada Hills No. 2 Subdivision (GH2, Page) and Lot 6 of the Moss Hill Drive Subdivision (MH, Wolfe). This lot line adjustment also includes property owned by Bountiful City (GH2, Lot 9) which is currently used as a storm water detention basin (and the former unofficial skate park) located on the southeast corner of the intersection of Vineyard Drive and Moss Hill Drive.

The City has previously processed lot line adjustments through the Administrative Committee, but a change in the State Code now necessitates that these requests be processed as amended subdivision plats where the properties involved are part of an existing platted subdivision and involve a parcel with an existing residential structure.

#### **Analysis**

The lots involved in this proposed adjustment are located in the R-3 zone (11,000 sq ft min. lot size, 80 ft frontage requirement). The applicants are requesting the lot line adjustment between Lot 10 (GH 2) and Lot 6 (MH) to follow the existing fence and landscaping along the common property line. After the adjustment, all properties will remain in compliance with the current zoning requirements.

Since the original GH2 plat was recorded, there have been several adjustments to the property lines on Lots 9 and 10. It appears that Lot 9 was split into 2 pieces (whether this was done intentionally or not has been difficult to determine) which resulted in the City owning the northern portion of the detention basin and later acquiring the southern section of Lot 9 through a tax sale. The common boundary of Lots 9 and 10 was also re-aligned from the configuration shown on the original GH2 subdivision plat. By including Lot 9 in this process, the City will benefit by having a clear boundary for the detention basin property.

<u>Utilities:</u> No additional utilities are required.

Proposed Right of Way Improvements and Access: No improvements are required.

#### **Department Review**

This memo has been reviewed by the City Attorney, and Planning Director.



Figure 1 Location of Proposed Lot Line Adjustment

#### Recommendation

Staff would support the Planning Commission forwarding a recommendation approval of the Lot Line Adjustment at 1532 E Vineyard Drive to the City Council with the following conditions:


- 1. Complete any outstanding corrections to the Plat.
- 2. Provide a current Title Report.

#### **Significant Impacts**

None

#### **Attachments**

1. A copy of the preliminary amended plat.

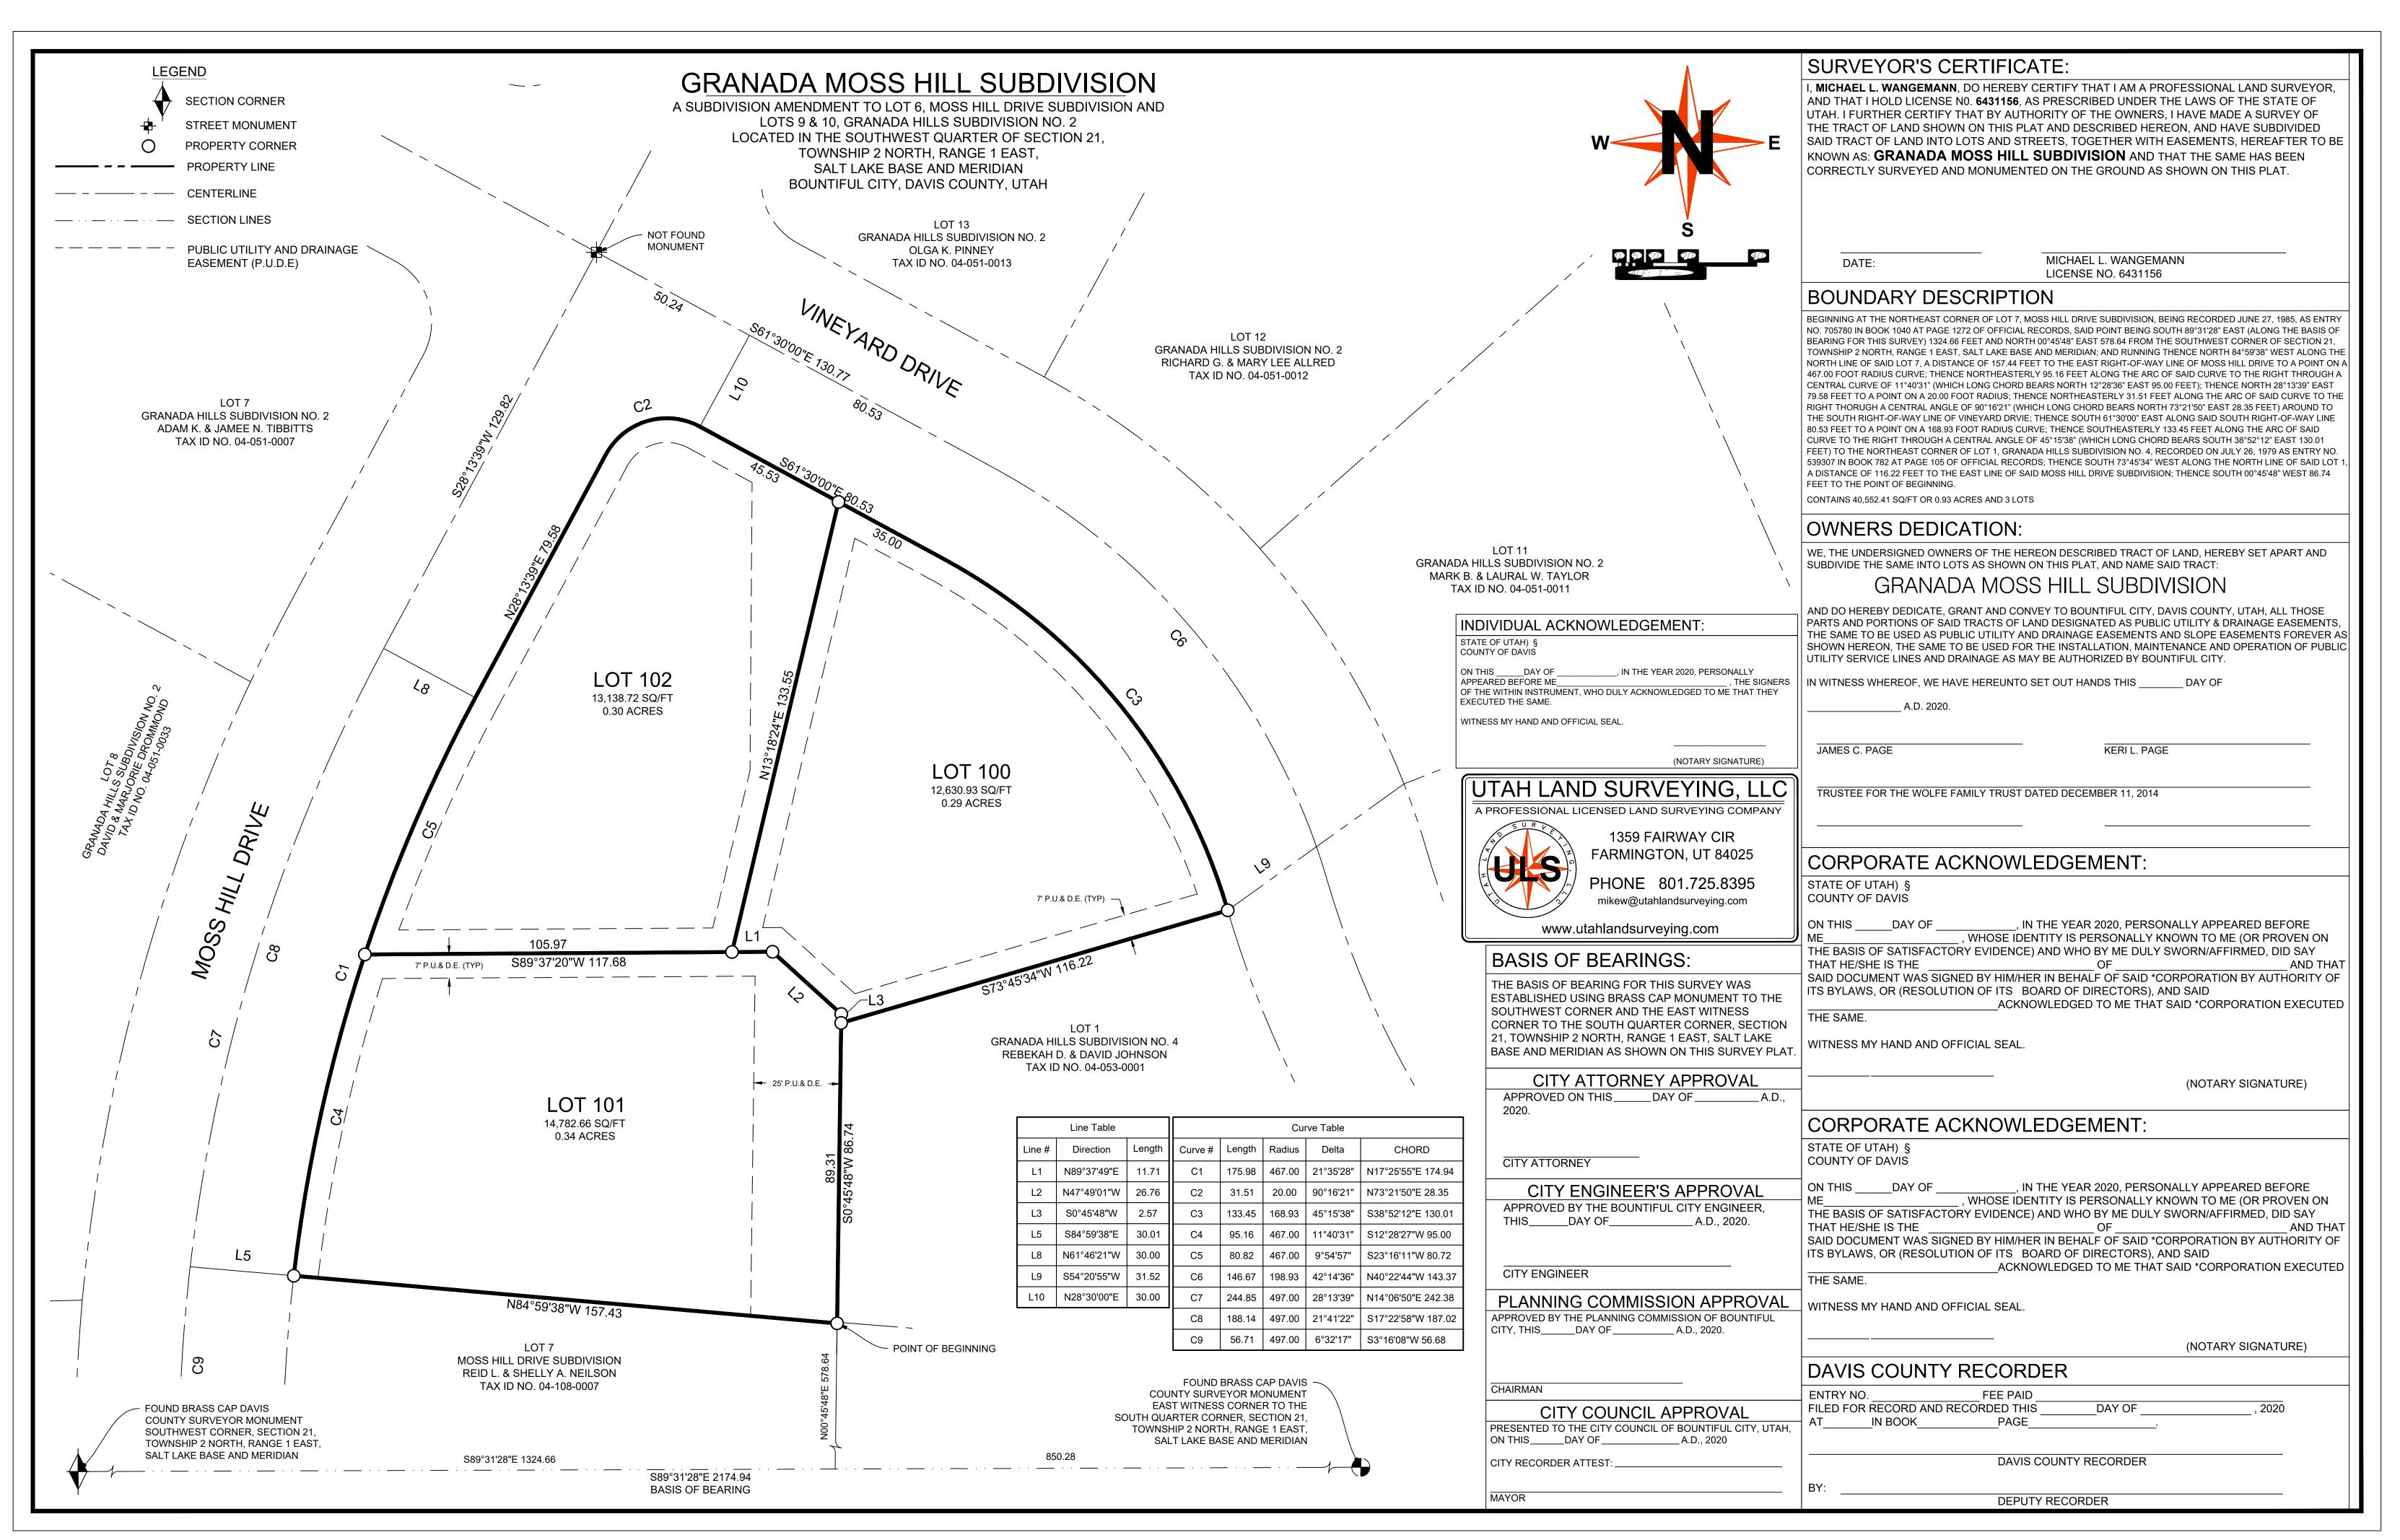

Page Bountiful City Planning Commission

## **Commission Staff Report**

Subject: Conditional Use Permit and Site Plan Review

**For Eight Townhouses** 

**Property Address:** 32 W 400 S

Author: Amber Corbridge, Senior Planner

**Department:** Planning **Date:** December 6, 2022



#### **Background**

Bob Murri, with City Creek Construction, is requesting both 1) Conditional Use Permit (CUP) and 2) Site Plan Approval to develop eight (8) multi-family townhouse units in the Downtown Zone. This project would be a separate parcel adjacent to the newly remodeled commercial building, known as the old Deseret First Credit Union. The project consists of two separate buildings. One building will include two (2) townhome units and the other six (6) townhomes units. The two-unit building is proposed to face 400 S and will accommodate a future commercial use. The materials and colors used for the new project will complement the style of the new adjacent office building (see rendering below), using brick, metal panel siding, synthetic wood paneling, and stucco.

The proposed townhomes consist of three (3) stories. The main level for each unit will accommodate two (2) tandem parked cars in an attached garage. The second and third level will include a living room, dining room, kitchen, two and a half ( $2\frac{1}{2}$ ) bathrooms, two (2) bedrooms, and more. The total building height will be thirty-four feet six inches (34'-6"), where the maximum building height allowed is fifty-five feet (55').

The total lot area is 12,945.422 square feet, at 77.90 ft. wide and 166.18 ft. long. The total proposed landscaped area is 3,911 sf. or thirty (30) percent of the property, where a minimum of ten (10) percent is allowed. Three (3) parking spaces are provided for each unit. The attached letter states the owners of the property have entered into a parking agreement between the three (3) parcels at the corner of Main Street and 400 S.



#### **Analysis**

#### Conditional Use Standards

A multi-family residential use not facing Main Street is a conditional use in the downtown zone. The Planning Commission must consider how the proposed use 1) relates to the surrounding uses, 2) impacts the existing surrounding developments, and 3) appropriate buffering of uses and buildings, proper parking and traffic circulation, and the use of building materials and landscaping, which are in harmony with the area (see Code 14-2-506.C).


This multi-family townhouse project will support the surrounding uses and act as a buffer between the single-family properties to the west and the commercial businesses to the east. The proposed two car garages for each unit will minimize parking impacts to the neighborhood, when utilized. Staff recommends a condition to restrict the garage use to only vehicles, as there are concerns with using the garages for living/storage space. Exterior lighting plans are being reviewed for mitigation compliance, which includes fully shielded light fixture design, and placement. Staff recommends this item be a condition of approval, as the exterior lighting plans are still in review. The proposed exterior building materials are similar to and complement the adjacent building, as shown below. Staff finds with the conditions of approval the proposed use meets the Conditional Use Permit requirements.

#### Adjacent Existing Building:





## Proposed Building Materials:

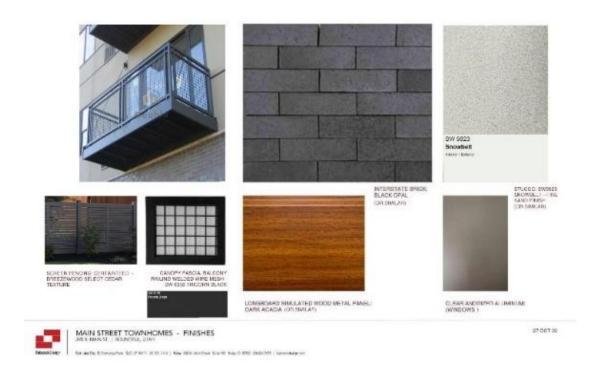

#### Code Compliance

The Site Plan is currently in review by development review staff, where setbacks, height, landscaping, parking, and other development standards are reviewed for compliance. The plans largely meet the site development standards. The following items include notable planning review comments and/or conditions:

#### Parking and Access

Regarding access and parking, the applicant submitted a shared parking agreement between the three (3) separate parcels (see attached). To ensure the parcels legally share parking and access the Applicant will need to record the shared parking agreement, including cross access, at the County and provide a copy of the recorded agreement to the City.

#### Landscaping and Fencing

The outdoor lighting plans will need to meet the code (14-16-111.H) for properly shielded light fixtures.

#### Engineering, Building, Power, and Fire Comments

All staff redlines and review comments are noted in the attached plans and will need to be satisfied as a condition of approval. The applicant shall enter into a development agreement.

#### **Design Standards**

Design standards and regulations apply to multi-family development where architecture, site design, and parking are further reviewed. The proposal meets the design standards regarding landscaping, architectural elements, building materials, pedestrian circulation, and screening. The lighting plans are still in review and will need to comply with the design standards, as mentioned previously.

#### **Department Review**

This staff report was written by the Senior Planner and reviewed by the Planning Director, City Engineer, and the City Attorney.

#### **Significant Impacts**

The development would be in an area with existing urban infrastructure levels. Impacts from the development of this property have been anticipated in the design of the existing storm water, sewer, and water transportation systems. The conditions of approval are designed to mitigate other impacts anticipated by the development.

#### **Recommendations**

- 1. Staff recommends approval of the Conditional Use Permit (CUP) for the Townhouses at approximately 32 W 400 S, subject to the following conditions:
  - a. Submit a city-approved recorded copy of the shared cross access, parking, and dumpster agreement between the three (3) adjacent parcels (030320057, 030320055, and 030320056).
  - b. The garages shall be used for parking, and not living/storage space.
  - c. Satisfy and meet all department review comments.
  - d. Sign a Development Agreement.
- 2. Staff recommends that the Planning Commission forward a recommendation of approval to the City Council for the site plan subject to meeting the above conditions of approval for a CUP.

Note: Final approval and building permits will be granted when all conditions are met and satisfied.

#### **Attachments**

- 1. Aerial photo
- 2. Parking Agreement
- 3. Latest Plan Set (Site, Civil, Elevations, Electrical, and Landscape)

## **Aerial Photo**



#### **Parking Agreement**

P.O. BOX 1785 BOUNTIFUL, UT



August 24, 2022

Francisco Astorga Director, Planning + Economic Development Bountiful City 795 South Main Street Bountiful City, Utah 84010

RE: Shared Parking Agreement at 390 S. Main Street

Francisco:

As owners of the property located at 390 S. Main Street, Bountiful, Utah 84010 representing 390 Main, LLC and B & P Properties, LLC, we send this letter to Bountiful City regarding a shared parking agreement. There are three parcels on this site. We agree and this letter certifies of our commitment to a shared parking agreement on this property. If you have any questions, please contact Steve Beyer at 801-205-7464.

Sincerely

Robert L. Murri, Managing Member


B & P Properties, LLC

Stephen R Beyer, Managing Member

390 Main, LLC

RECEIVED

AUG 2 4 2022 BOUNTIFUL CITY PLANNING DEPT.

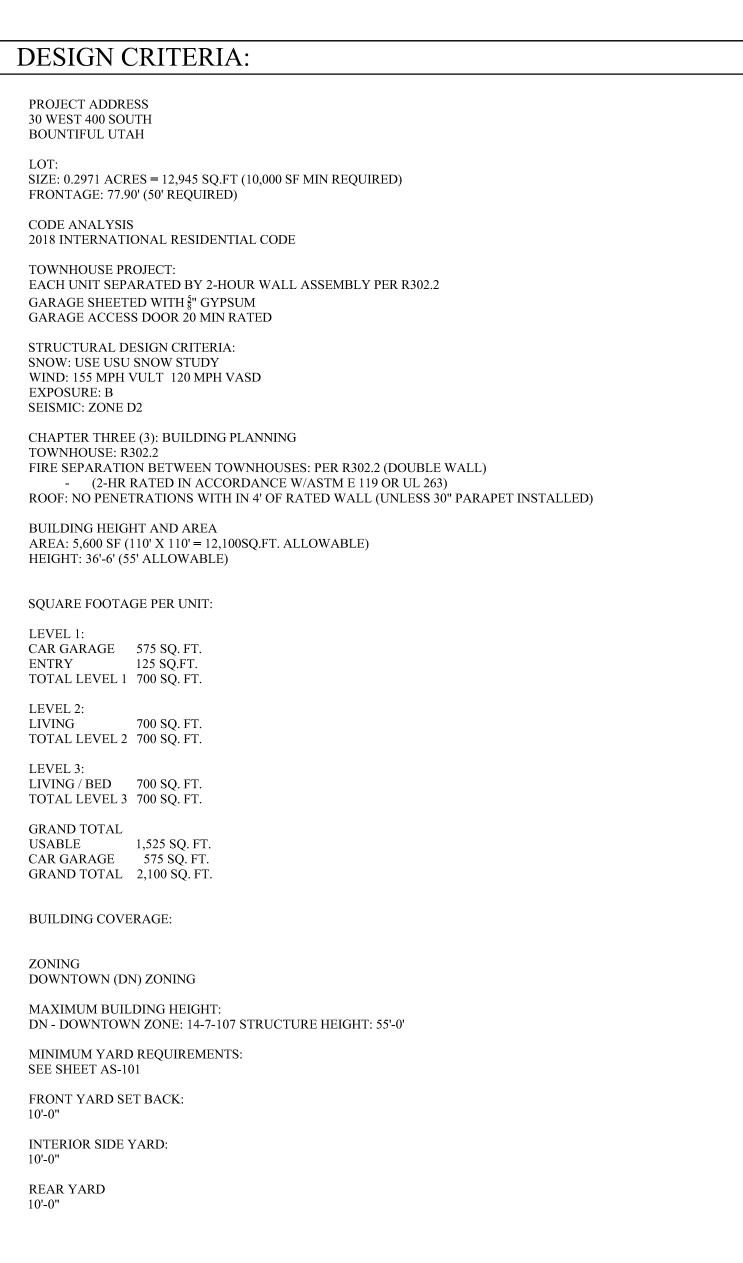

DRAWING INDEX:	SQUARE FOOTAGE:			
GENERAL:  G100 SITE PLAN / DRAWING INDEX  SURVEY SHEET 1 OF 1	UNIT "A-H":			
CIVIL:	125 SF			
LANDSCAPE: L101 LANDSCAPE PLAN L201 DETAILS  ARCHITECTURAL:	BUILDINGS UNDER CONSTRUCTION  •Buildings undergoing construction must comply with IFC.			

ARCHITECTURAL SITE PLAN

LEVEL 1 & 2 FLOOR PLANS

LEVEL 3 & ROOF PLANS

UNIT "A" ENLARGED PLAN UNIT "B-H" ENLARGED PLAN

EXTERIOR ELEVATIONS

BUILDING SECTIONS

A202 ..... EXTERIOR ELEVATIONS

S105 ..... STRUCTURAL DETAILS

STRUCTURAL (FUTURE PACKAGE):

ELECTRICAL (FUTURE PACKAGE):

ARCHITECTURAL DUMPSTER DETAILS

SECTIONS & DETAILS (FUTURE PKG)

FOOTING AND FOUNDATION PLAN

MAIN LEVEL FRAMING PLAN

ROOF FRAMING PLAN

E101 ..... LOWER LEVEL POWER / LIGHTING PLAN E102 ..... MAIN LEVEL POWER / LIGHTING PLAN

E103 ..... UPPER LEVEL POWER / LIGHTING PLAN


UPPER LEVEL FRAMING PLAN

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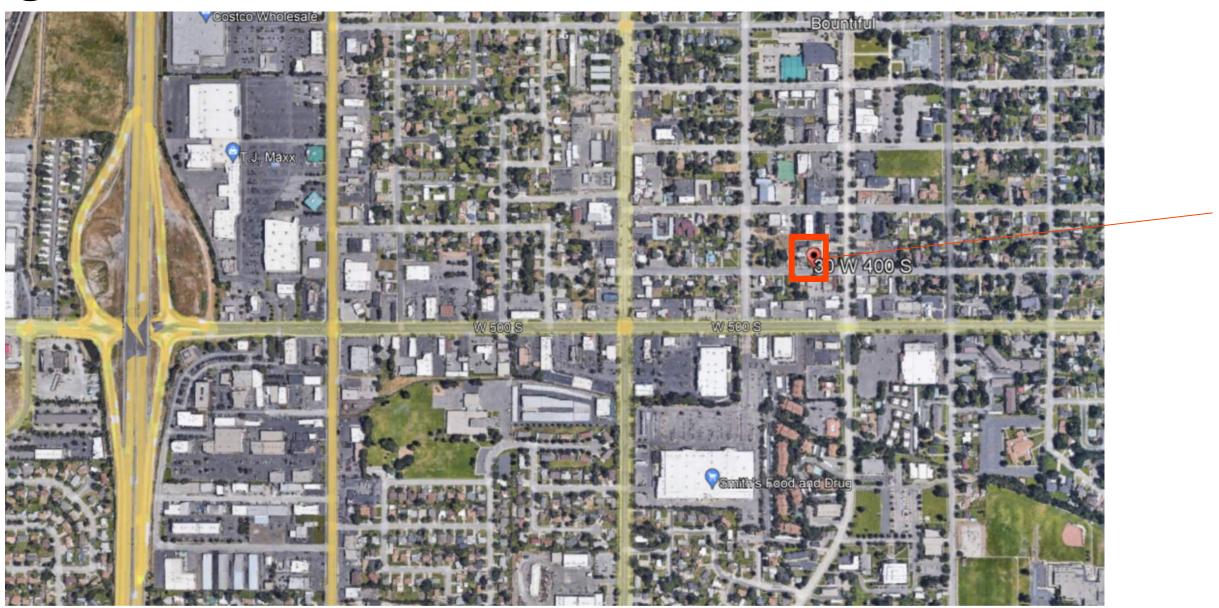
•Fire Department Access Roads: An all-weather fire department access road is required to be maintained at all times during construction. If the all-weather access is not maintained, SDMF reserves the right to stop work until the required roads are placed back in service.

•Water Supplies for Fire Protection: Water supplies required for fire protection are required to be maintained at all times during construction. If the fire protection water supply is not maintained, SDMF reserves the right to stop work until the required water supply for fire protection is placed back in service.

•Water supplies for fire protection must be clearly identified in a manner to prevent obstruction by parking and/or other obstructions.

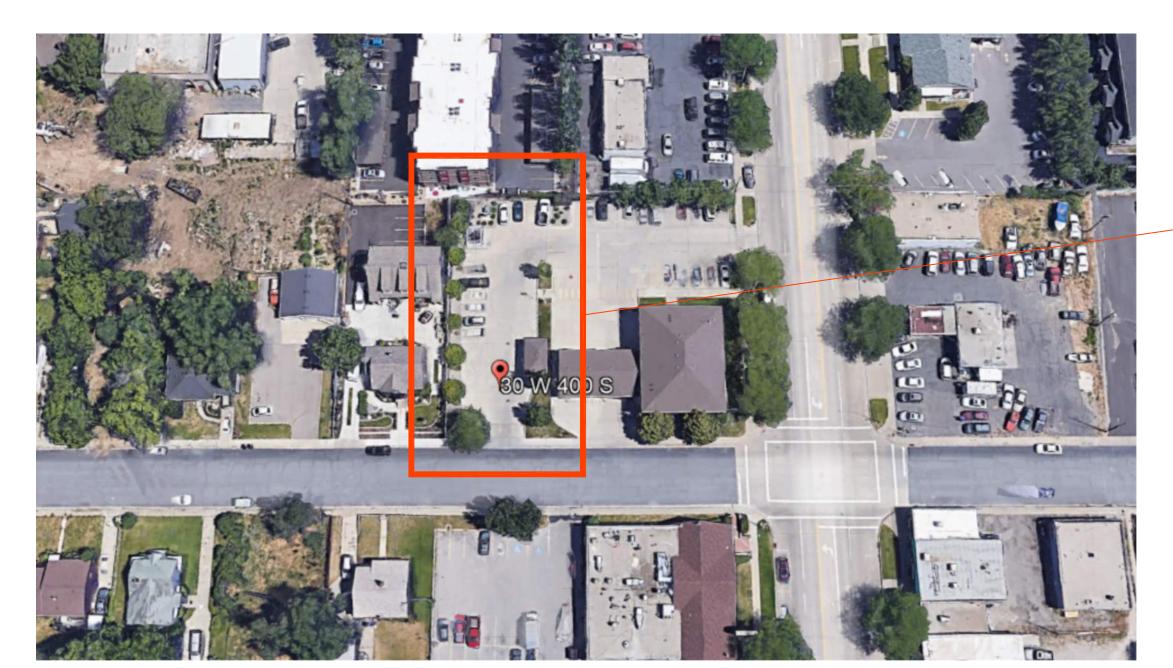


ENLARGED VICINITY MAP



VICINITY MAP



PERSPECTIVE

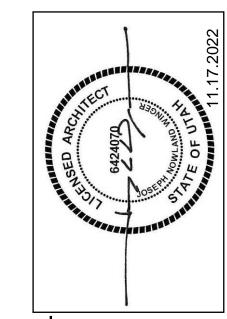


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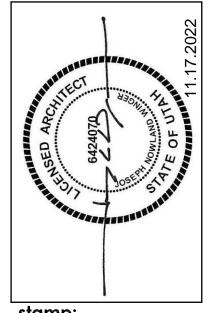
G100

COVER date:

11.17.2022

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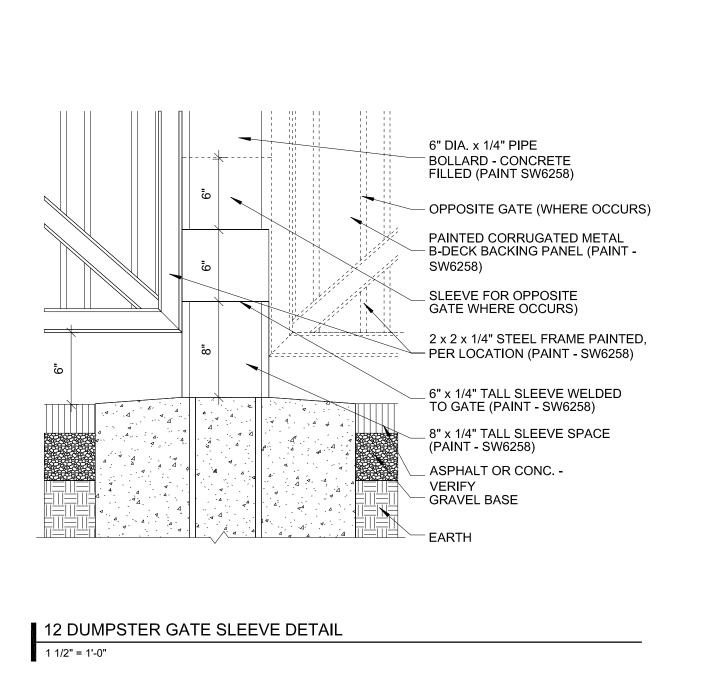
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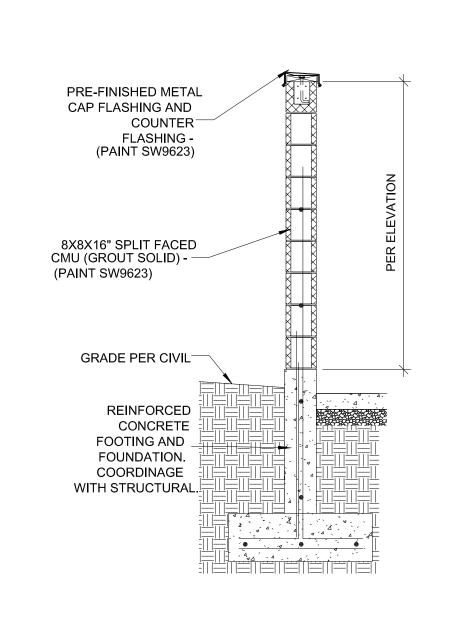
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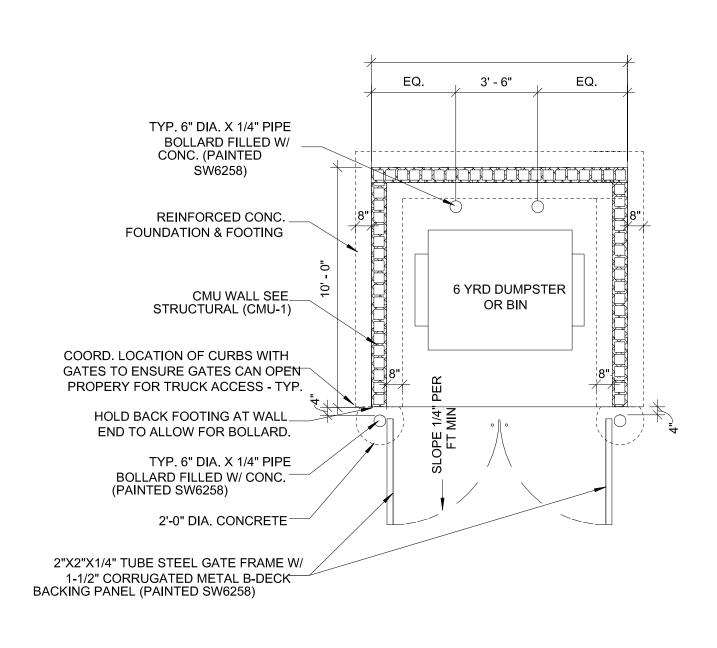
AS100
SITE PLAN
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11.17.2022



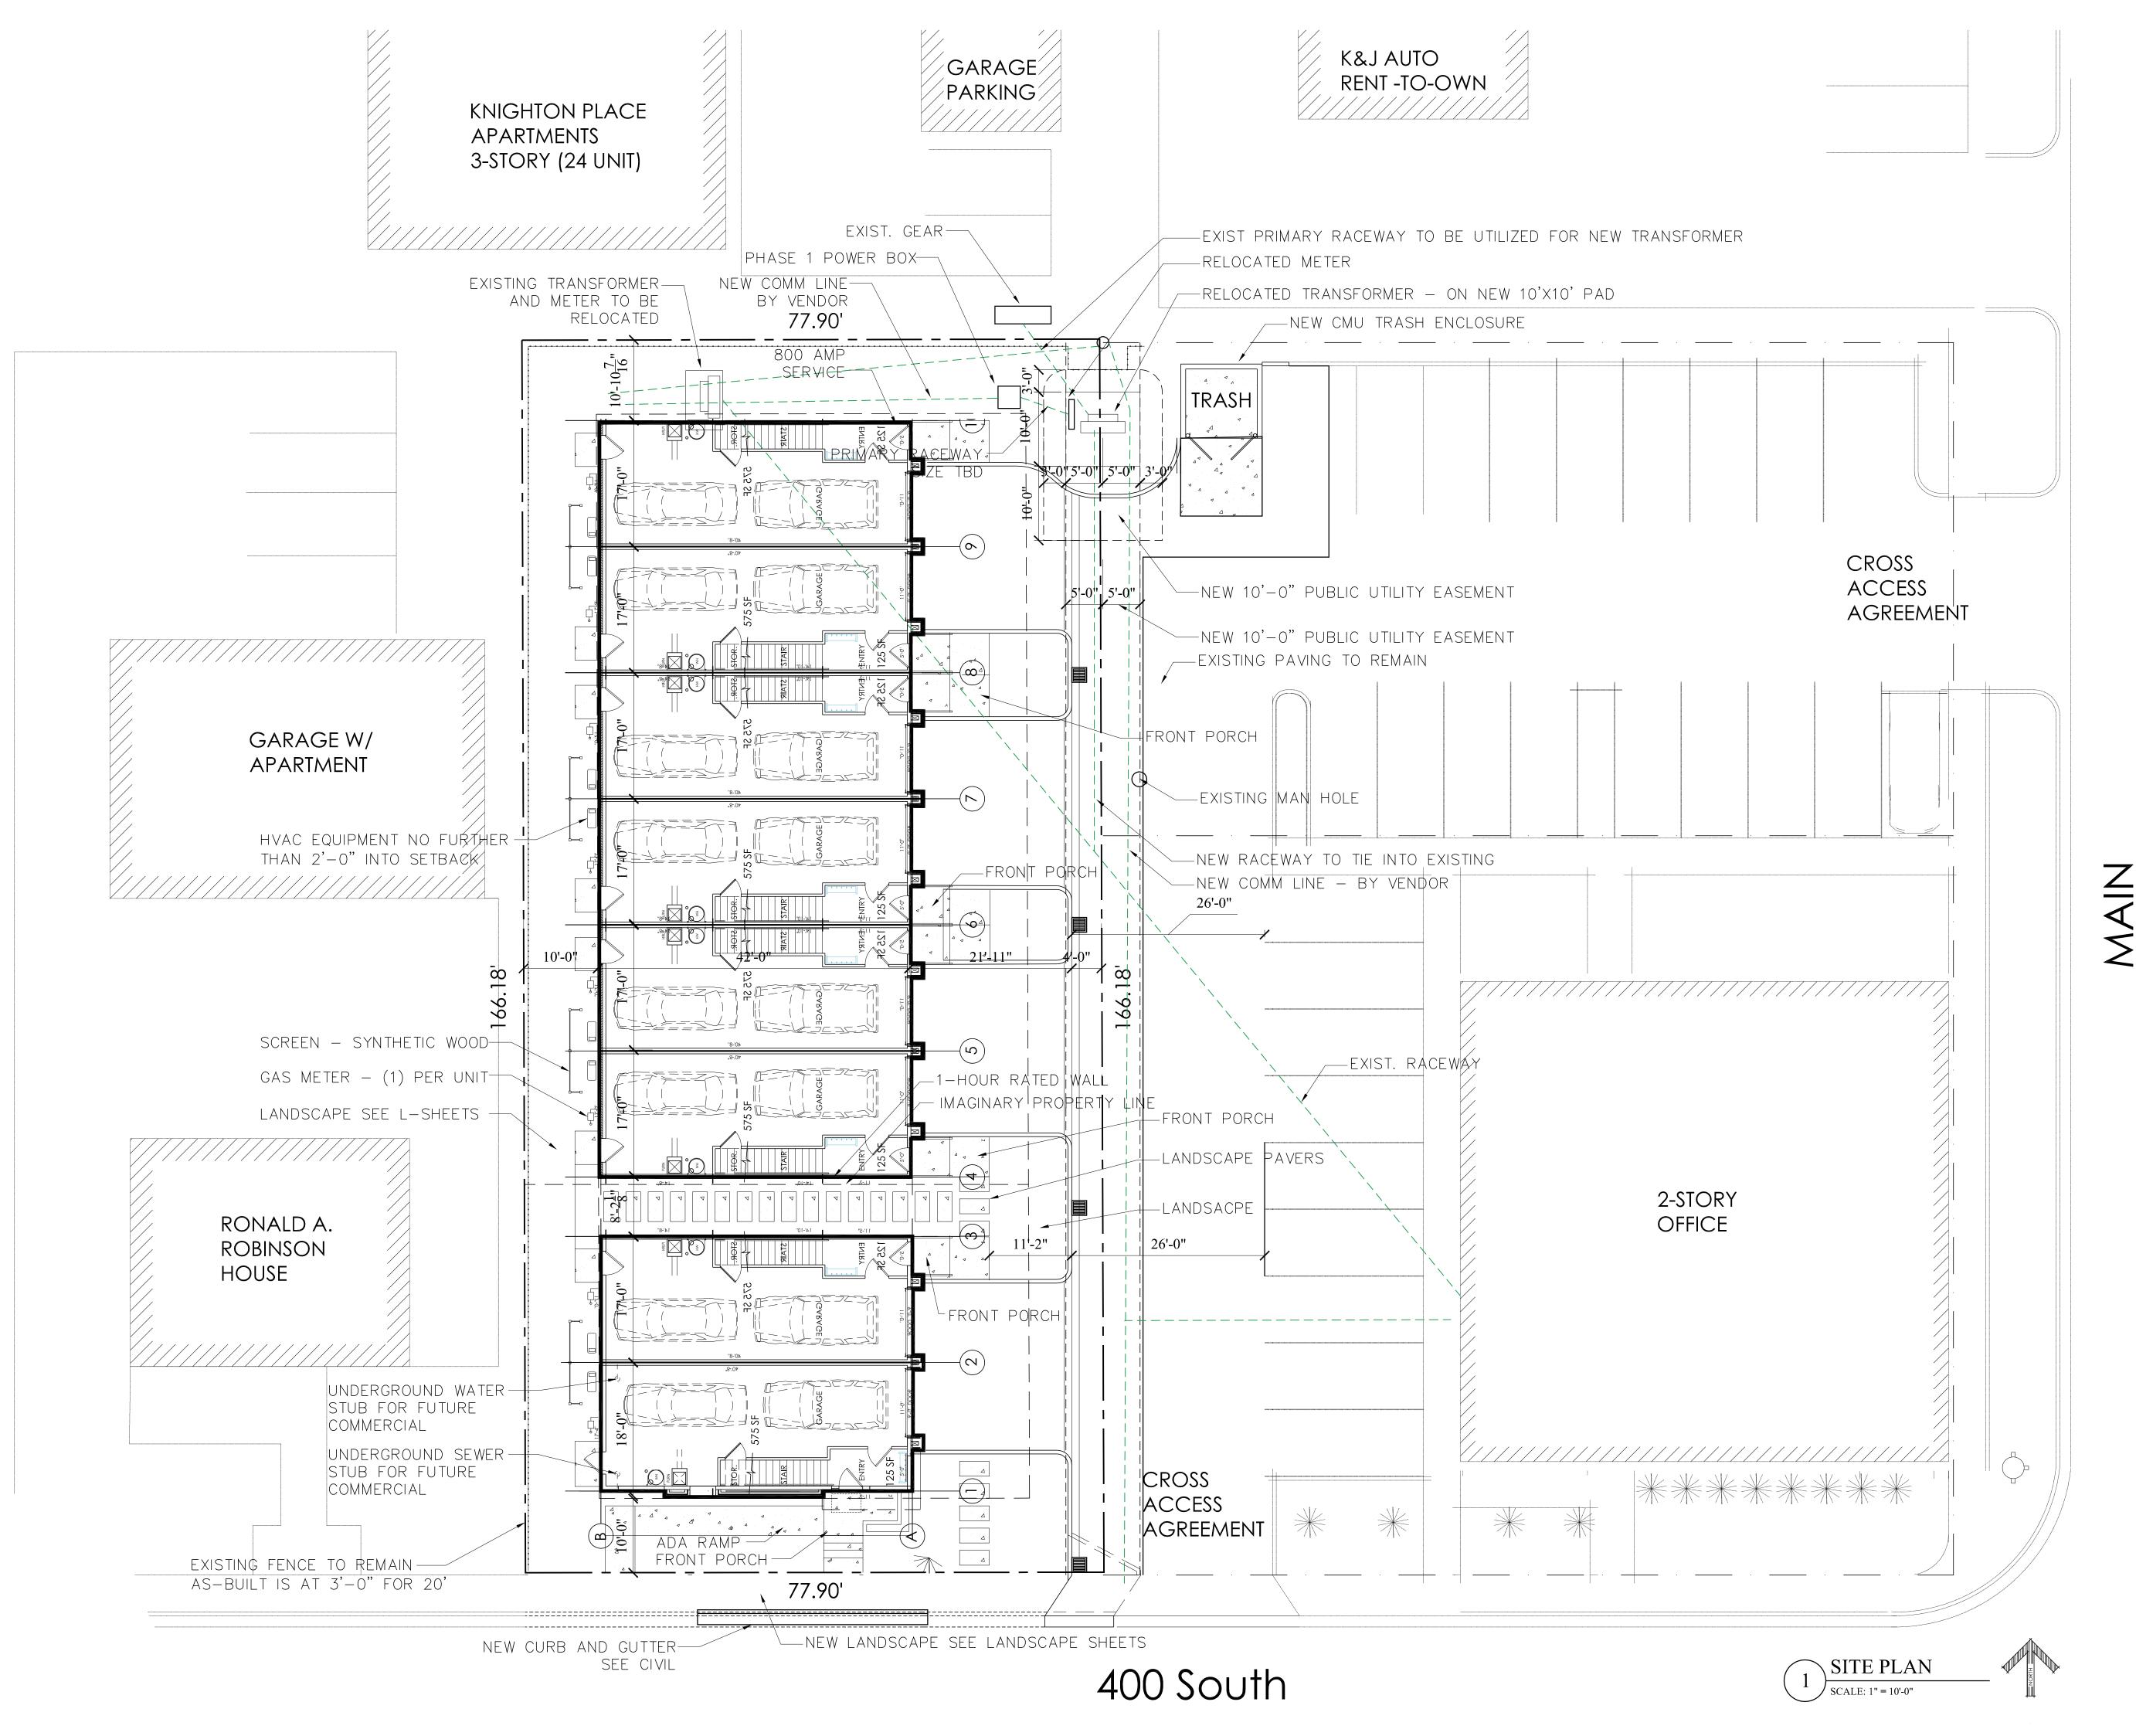


9 TRASH ENCLOSURE WALL SECTION

1/2" = 1'-0"



**5 TRASH ENCLOSURE** 

1/4" = 1'-0"

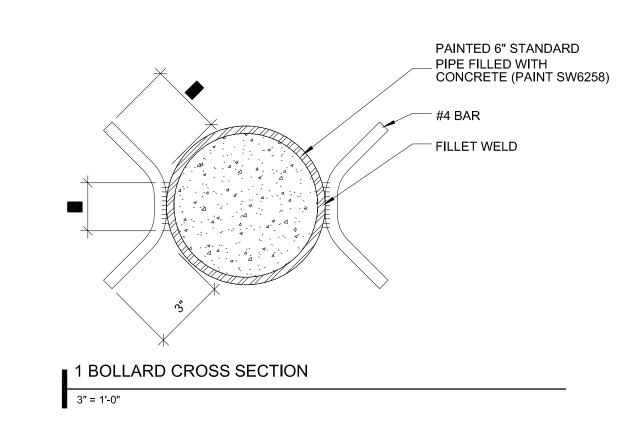

CONCRETE CAP-

6" STANDARD PIPE X

7'0" LONG SET IN\_ CONCRETE, PAINTED

FILL WITH CONCRETE

GRADE LINE

2 BOLLARD SECTION

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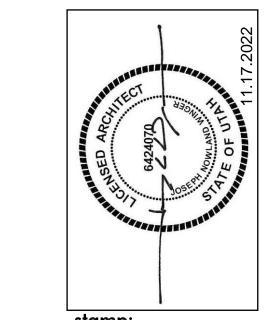
3 NOT USED

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1 1/2" = 1'-0"

(PAINT SW6258)

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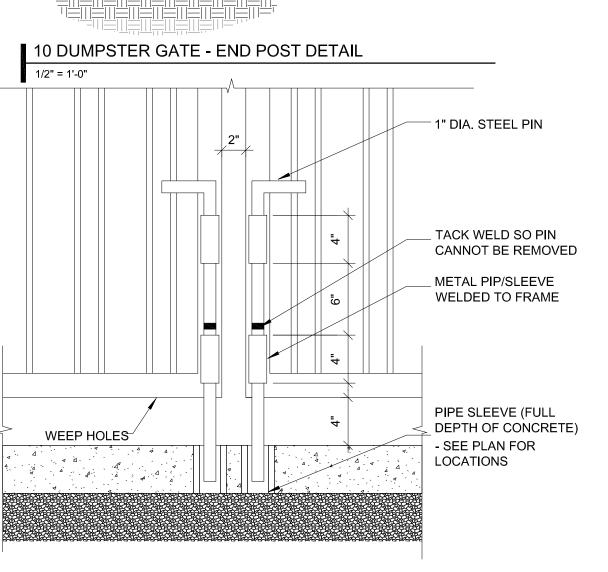


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South 84010


**DUMPSTER DETAILS** date: 11.17.2022


PRE-FINISHED METAL CAP FLASHING AND COUNTER FLASHING (WHITE) SPLIT FACED CMU WALL (PAINT SW9623) 6" X 1/4" TALL SLEEVE — WELDED TO GATE (PAINT SW6258) PAINTED CORRUGATED METAL B-DECK BACKING PANEL (PAINT SW6258) 6" DIA. x 1/4" PIPE BOLLARD - CONCRETE FILLED (PAINT SW6258) \_ 6" X 1/4" TALL SLEEVE WELDED TO GATE (PAINT SW6258) \_ 8" x 1/4" TALL SLEEVE SPACER (PAINT SW6258) ASPHALT OR CONCRETE PER CIVIL GRAVEL BASE - CONCRETE ₄ ₃2' -₃0". EARTH √ DIĄ. 10 DUMPSTER GATE - END POST DETAIL





11 DUMPSTER GATE PIN

1 1/2" = 1'-0"

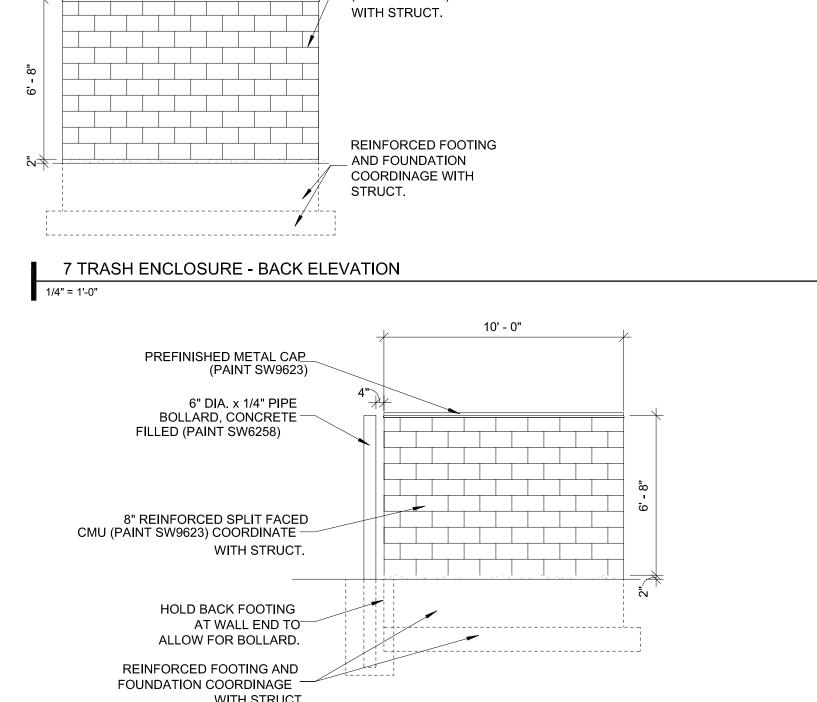

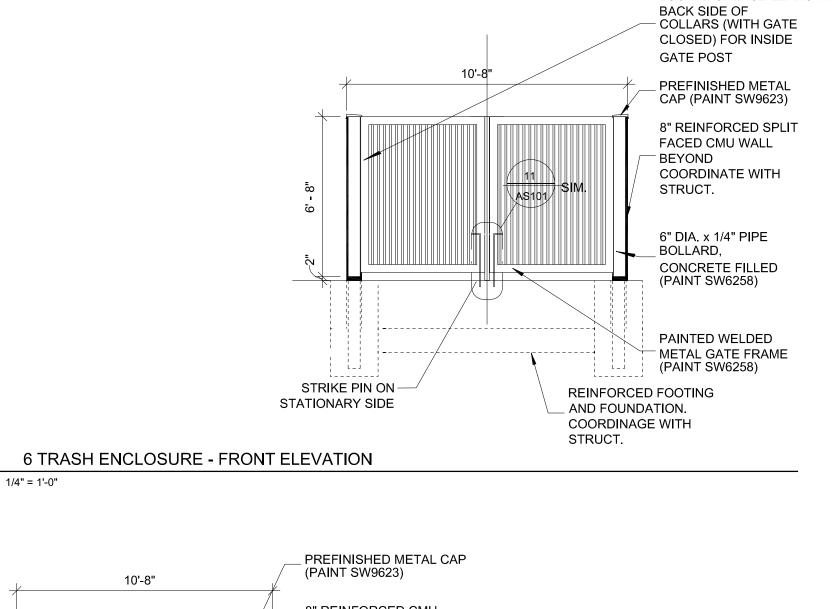

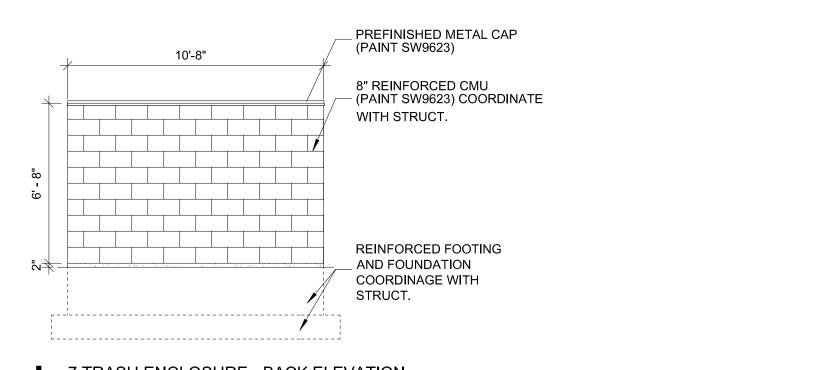

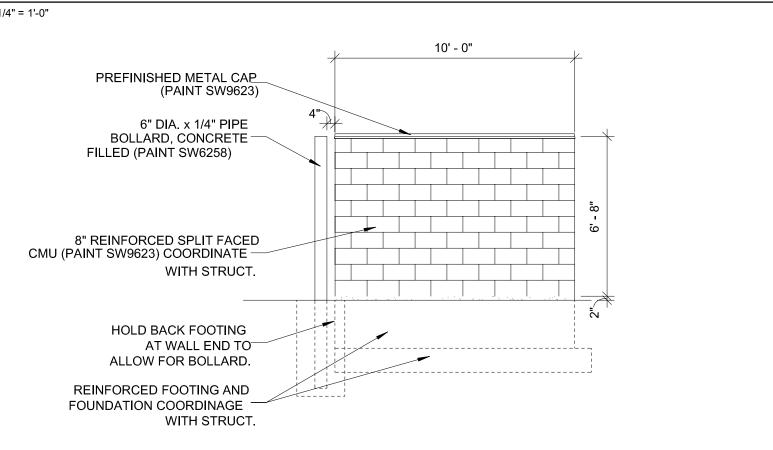

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8 TRASH E	_

**ENCLOSURE - SIDE ELEVATION** 1/4" = 1'-0"

TS4X2X3/16 DOOR STILES & RAILS (PAINT SW6258)

FLAT BAR GUIDE

1-1/2" B-DECK WELDED TO

TS GATE FRAME (PAINT SW6258)

14 GATE ESPAGOLETTE

ROD TYPE\_


**ESPAGNOLETTE** 


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1/2" = 1'-0"

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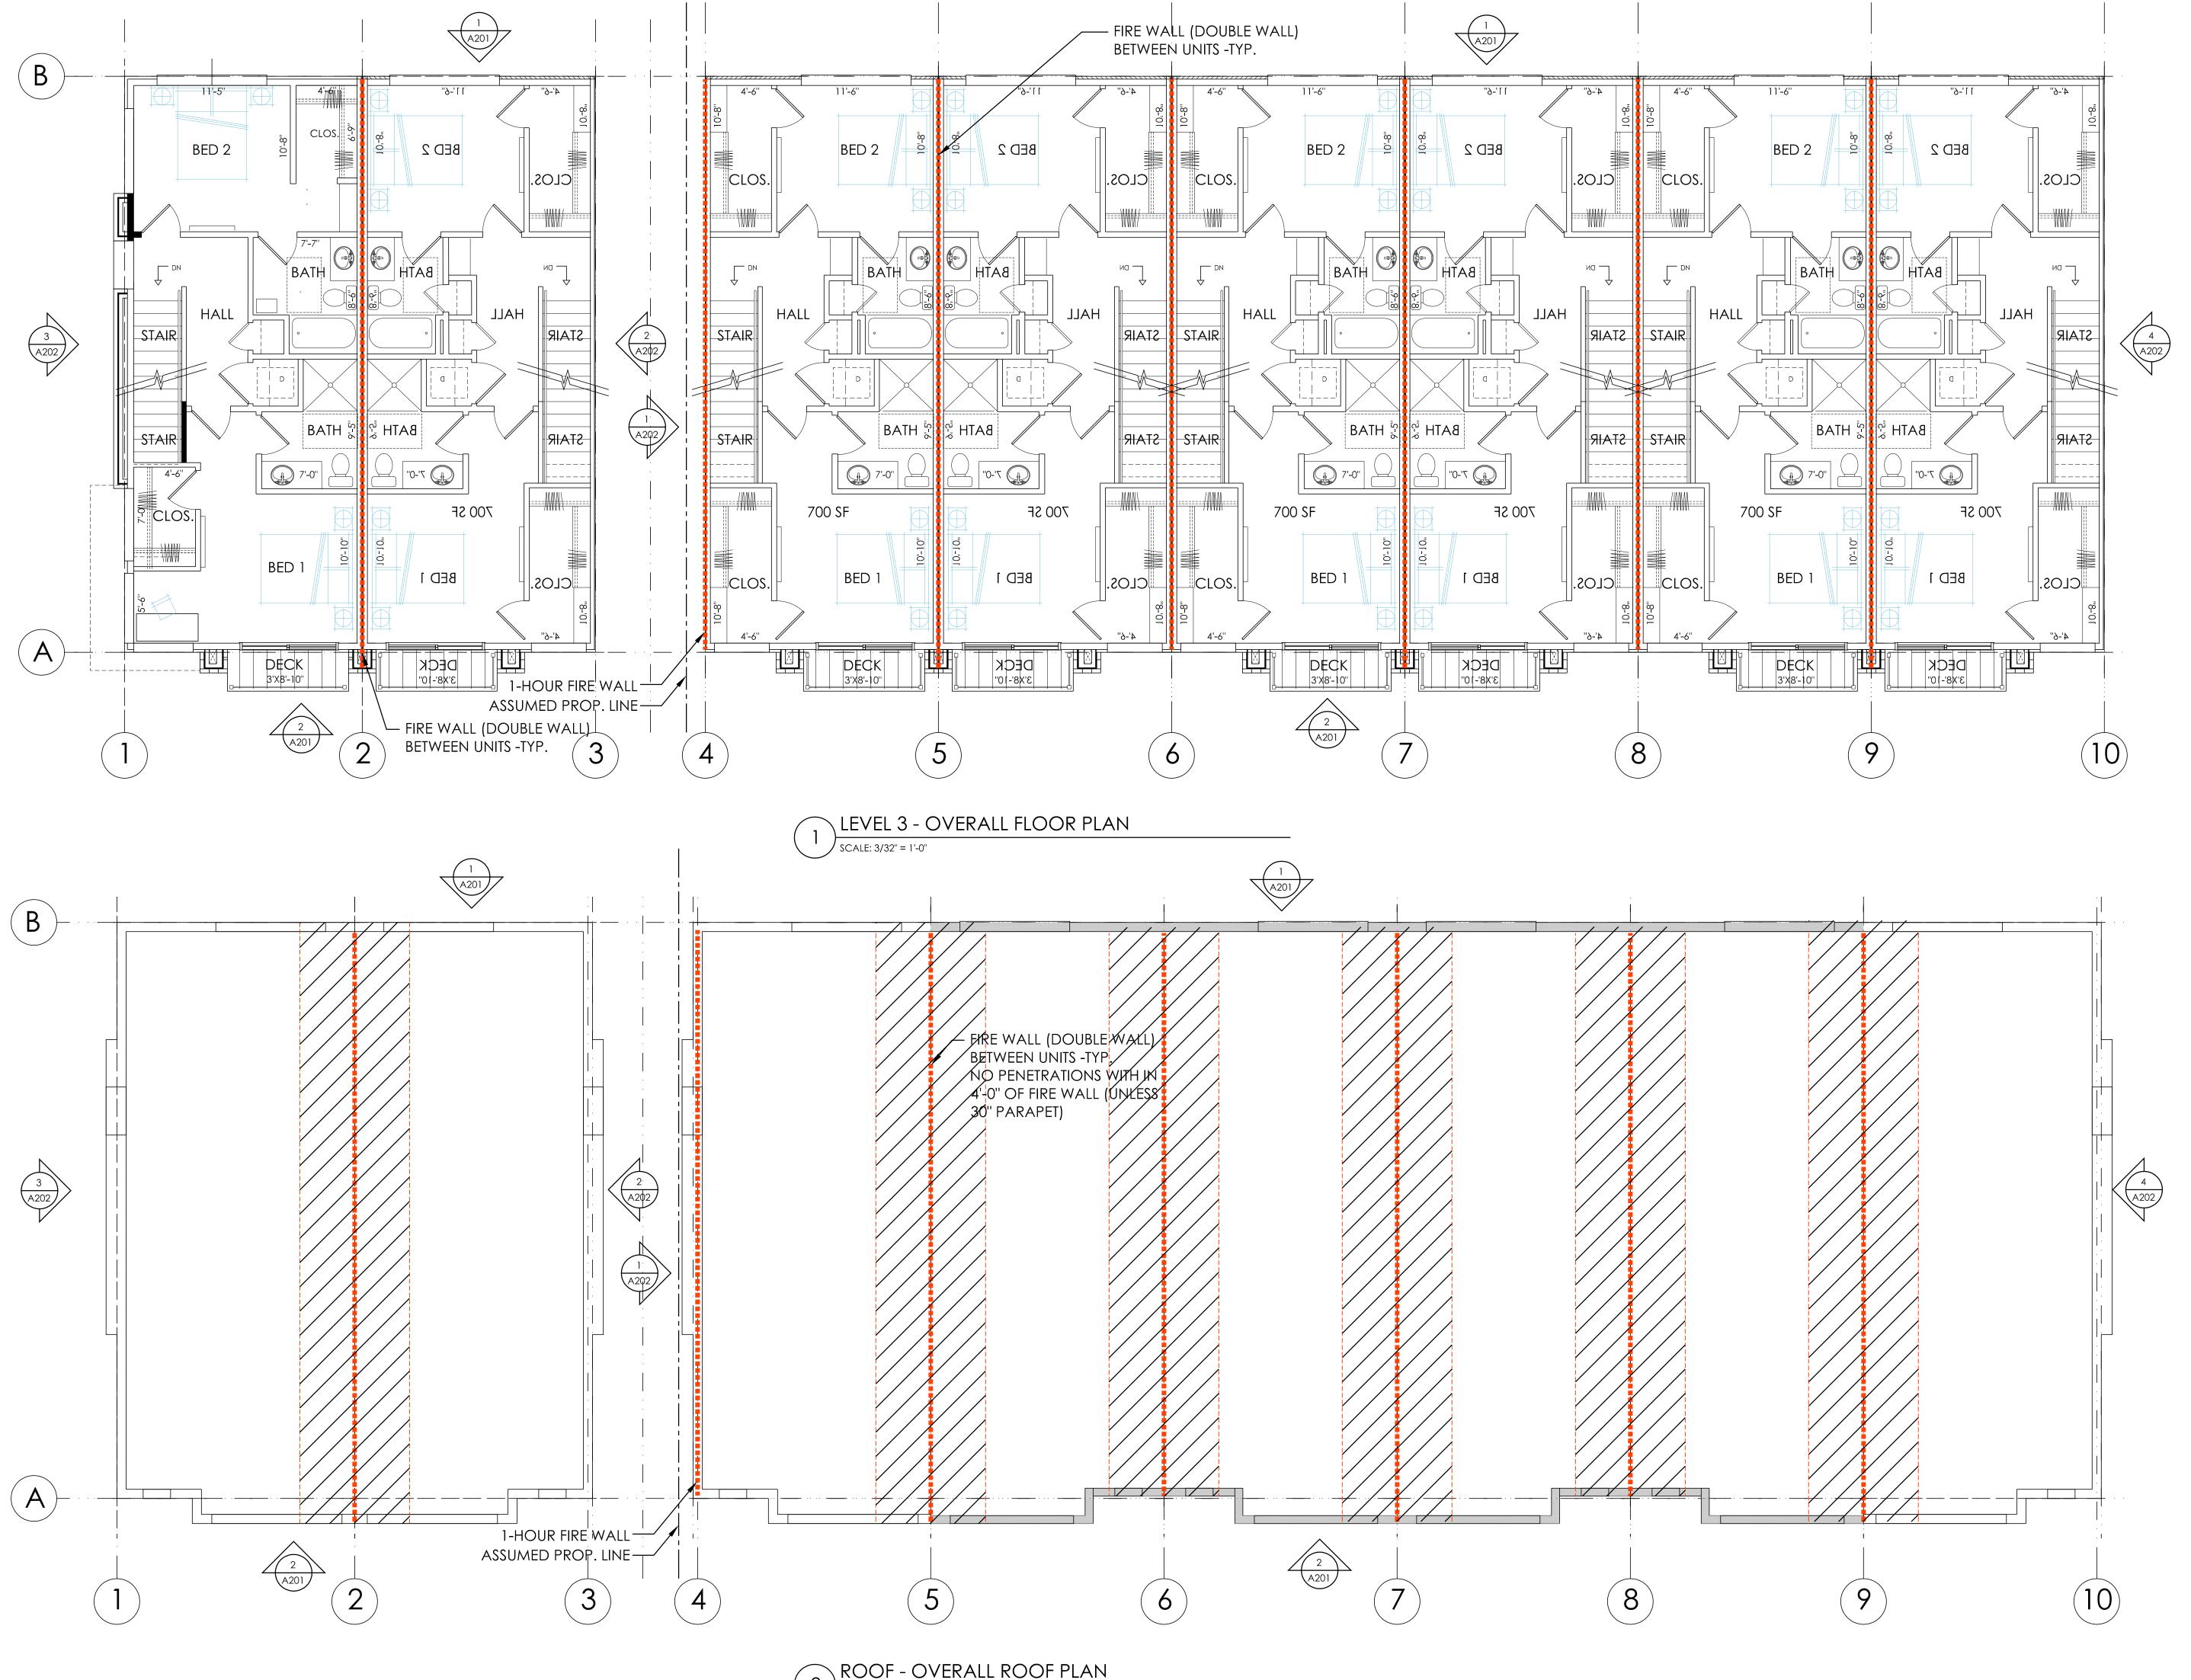




400 30 West 400 South Bountiful Utah 84010 at

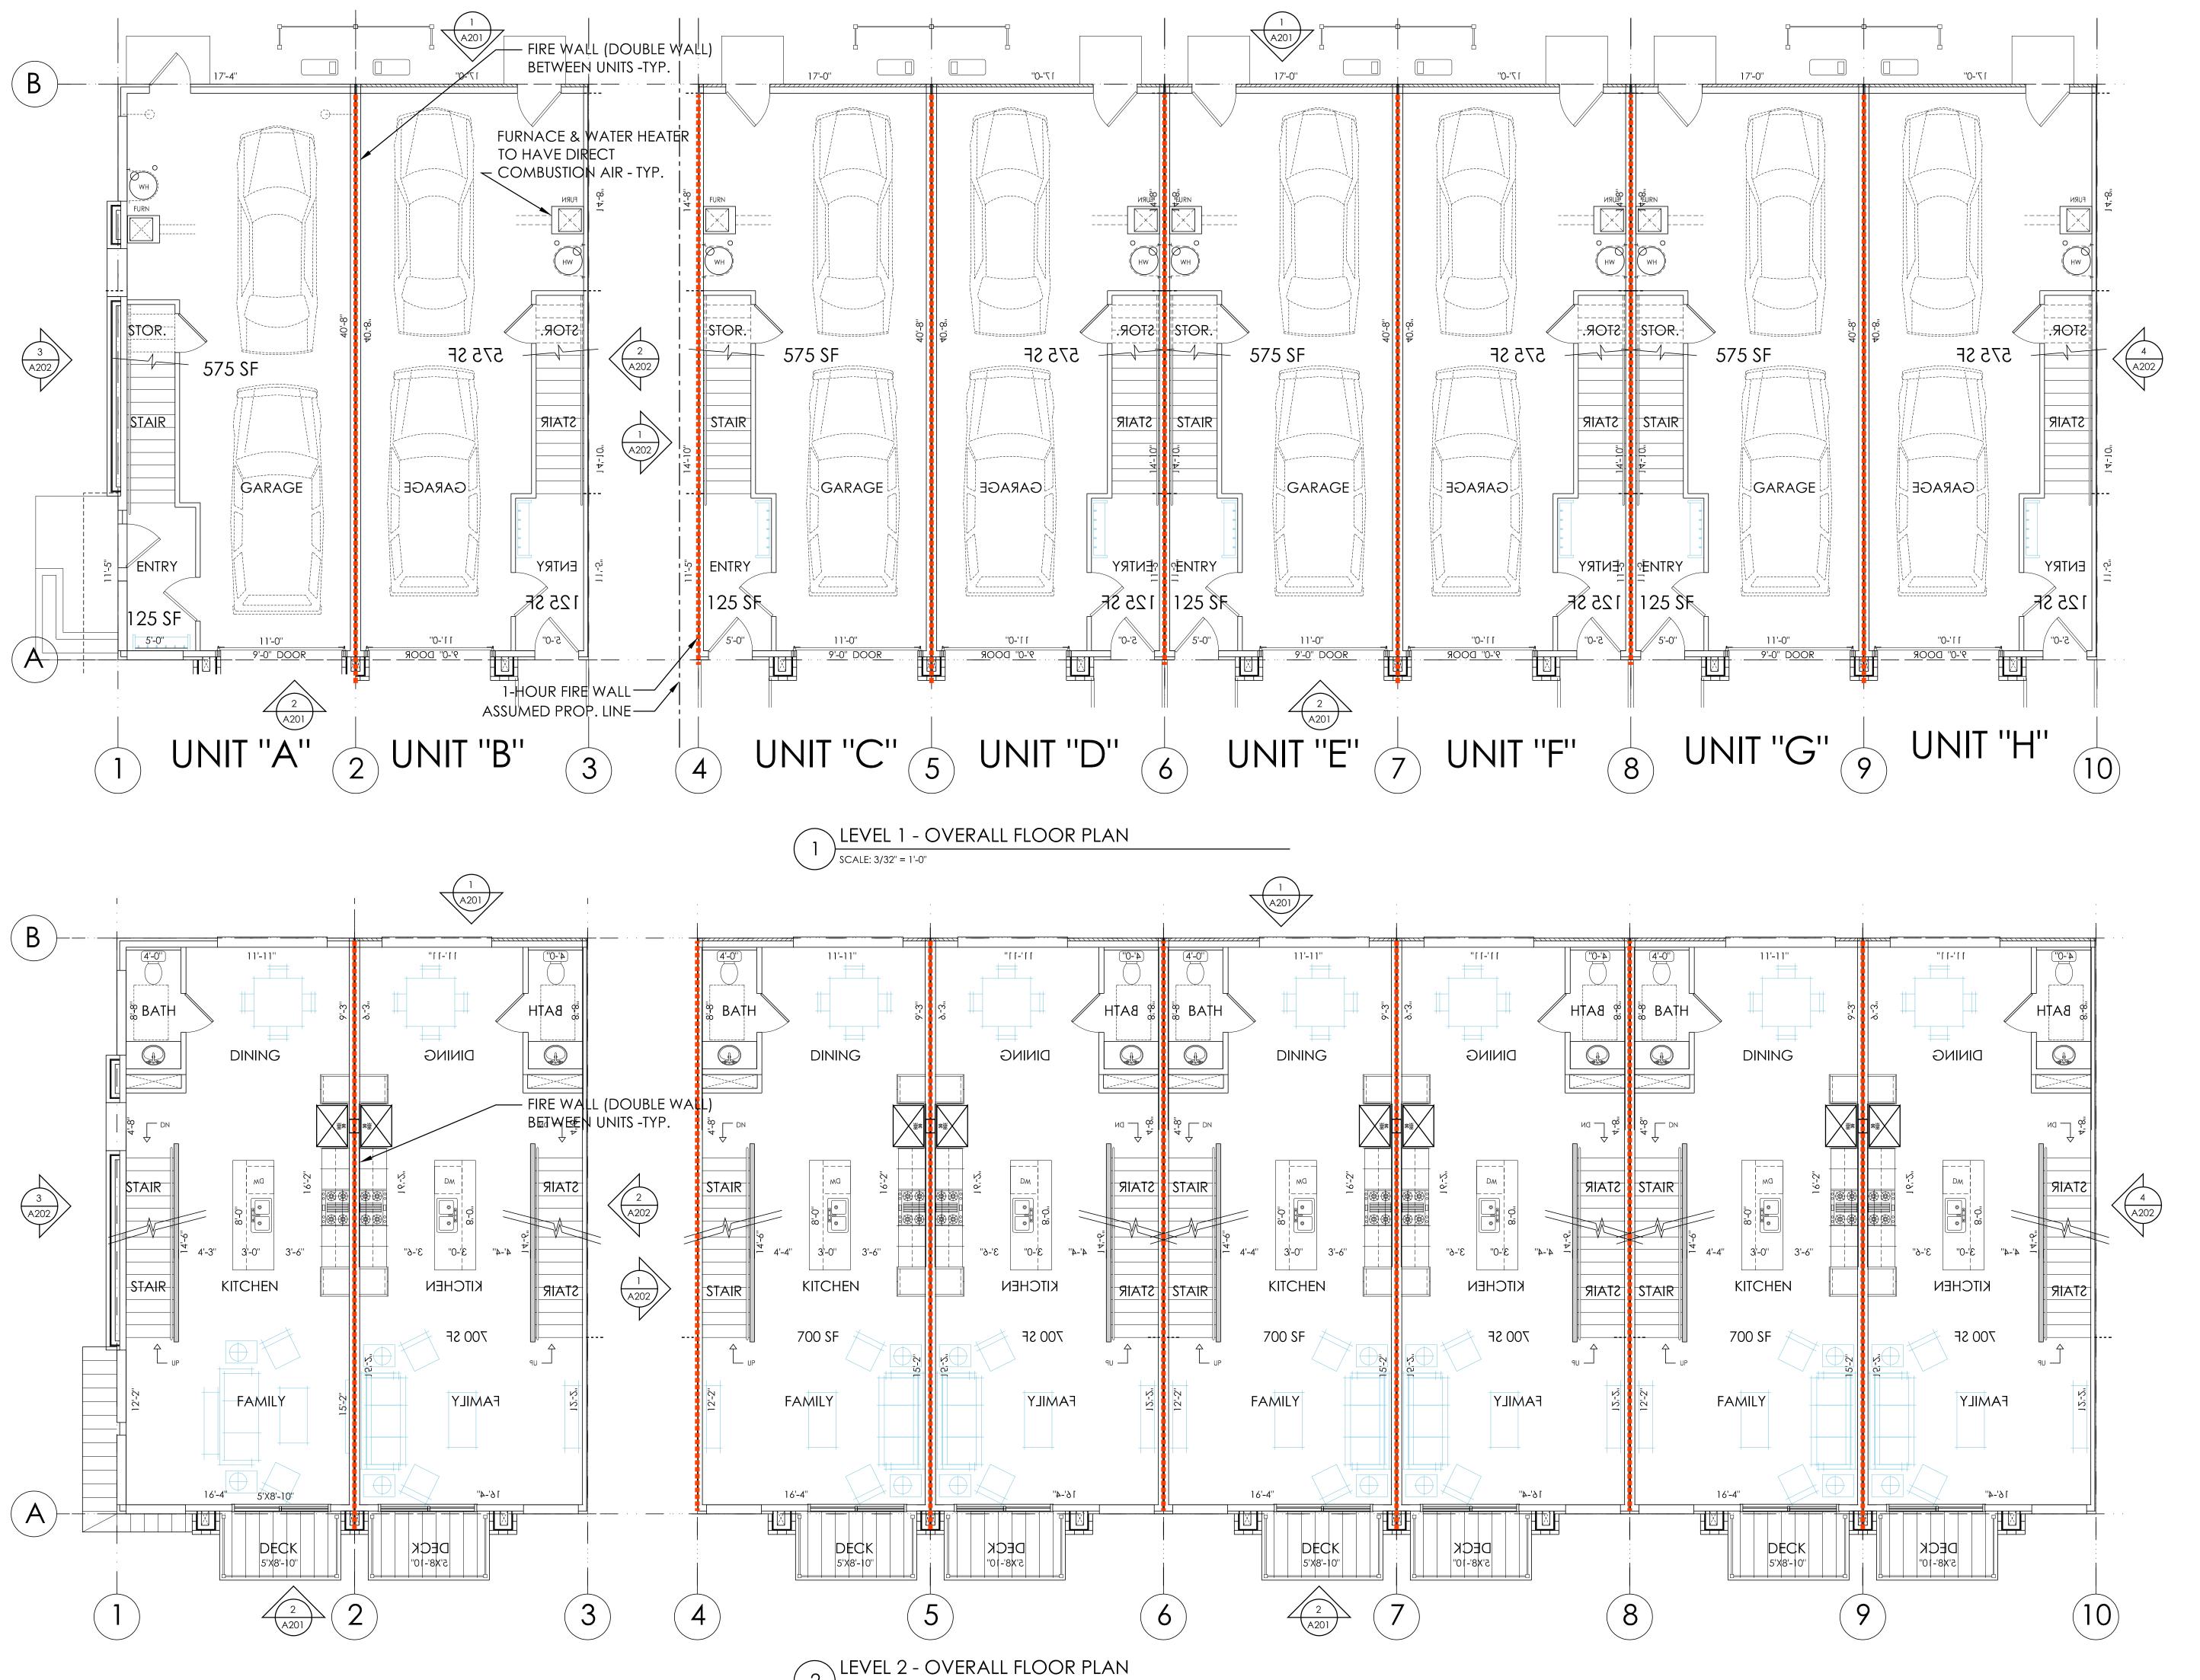LEVEL 1&2 date: 11.17.2022

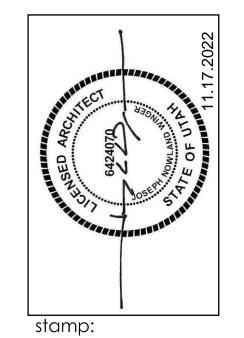SCALE: 3/32" = 1'-0"




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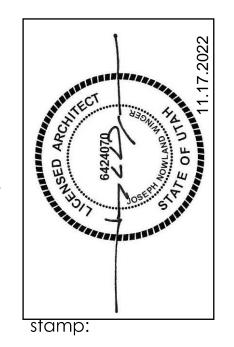
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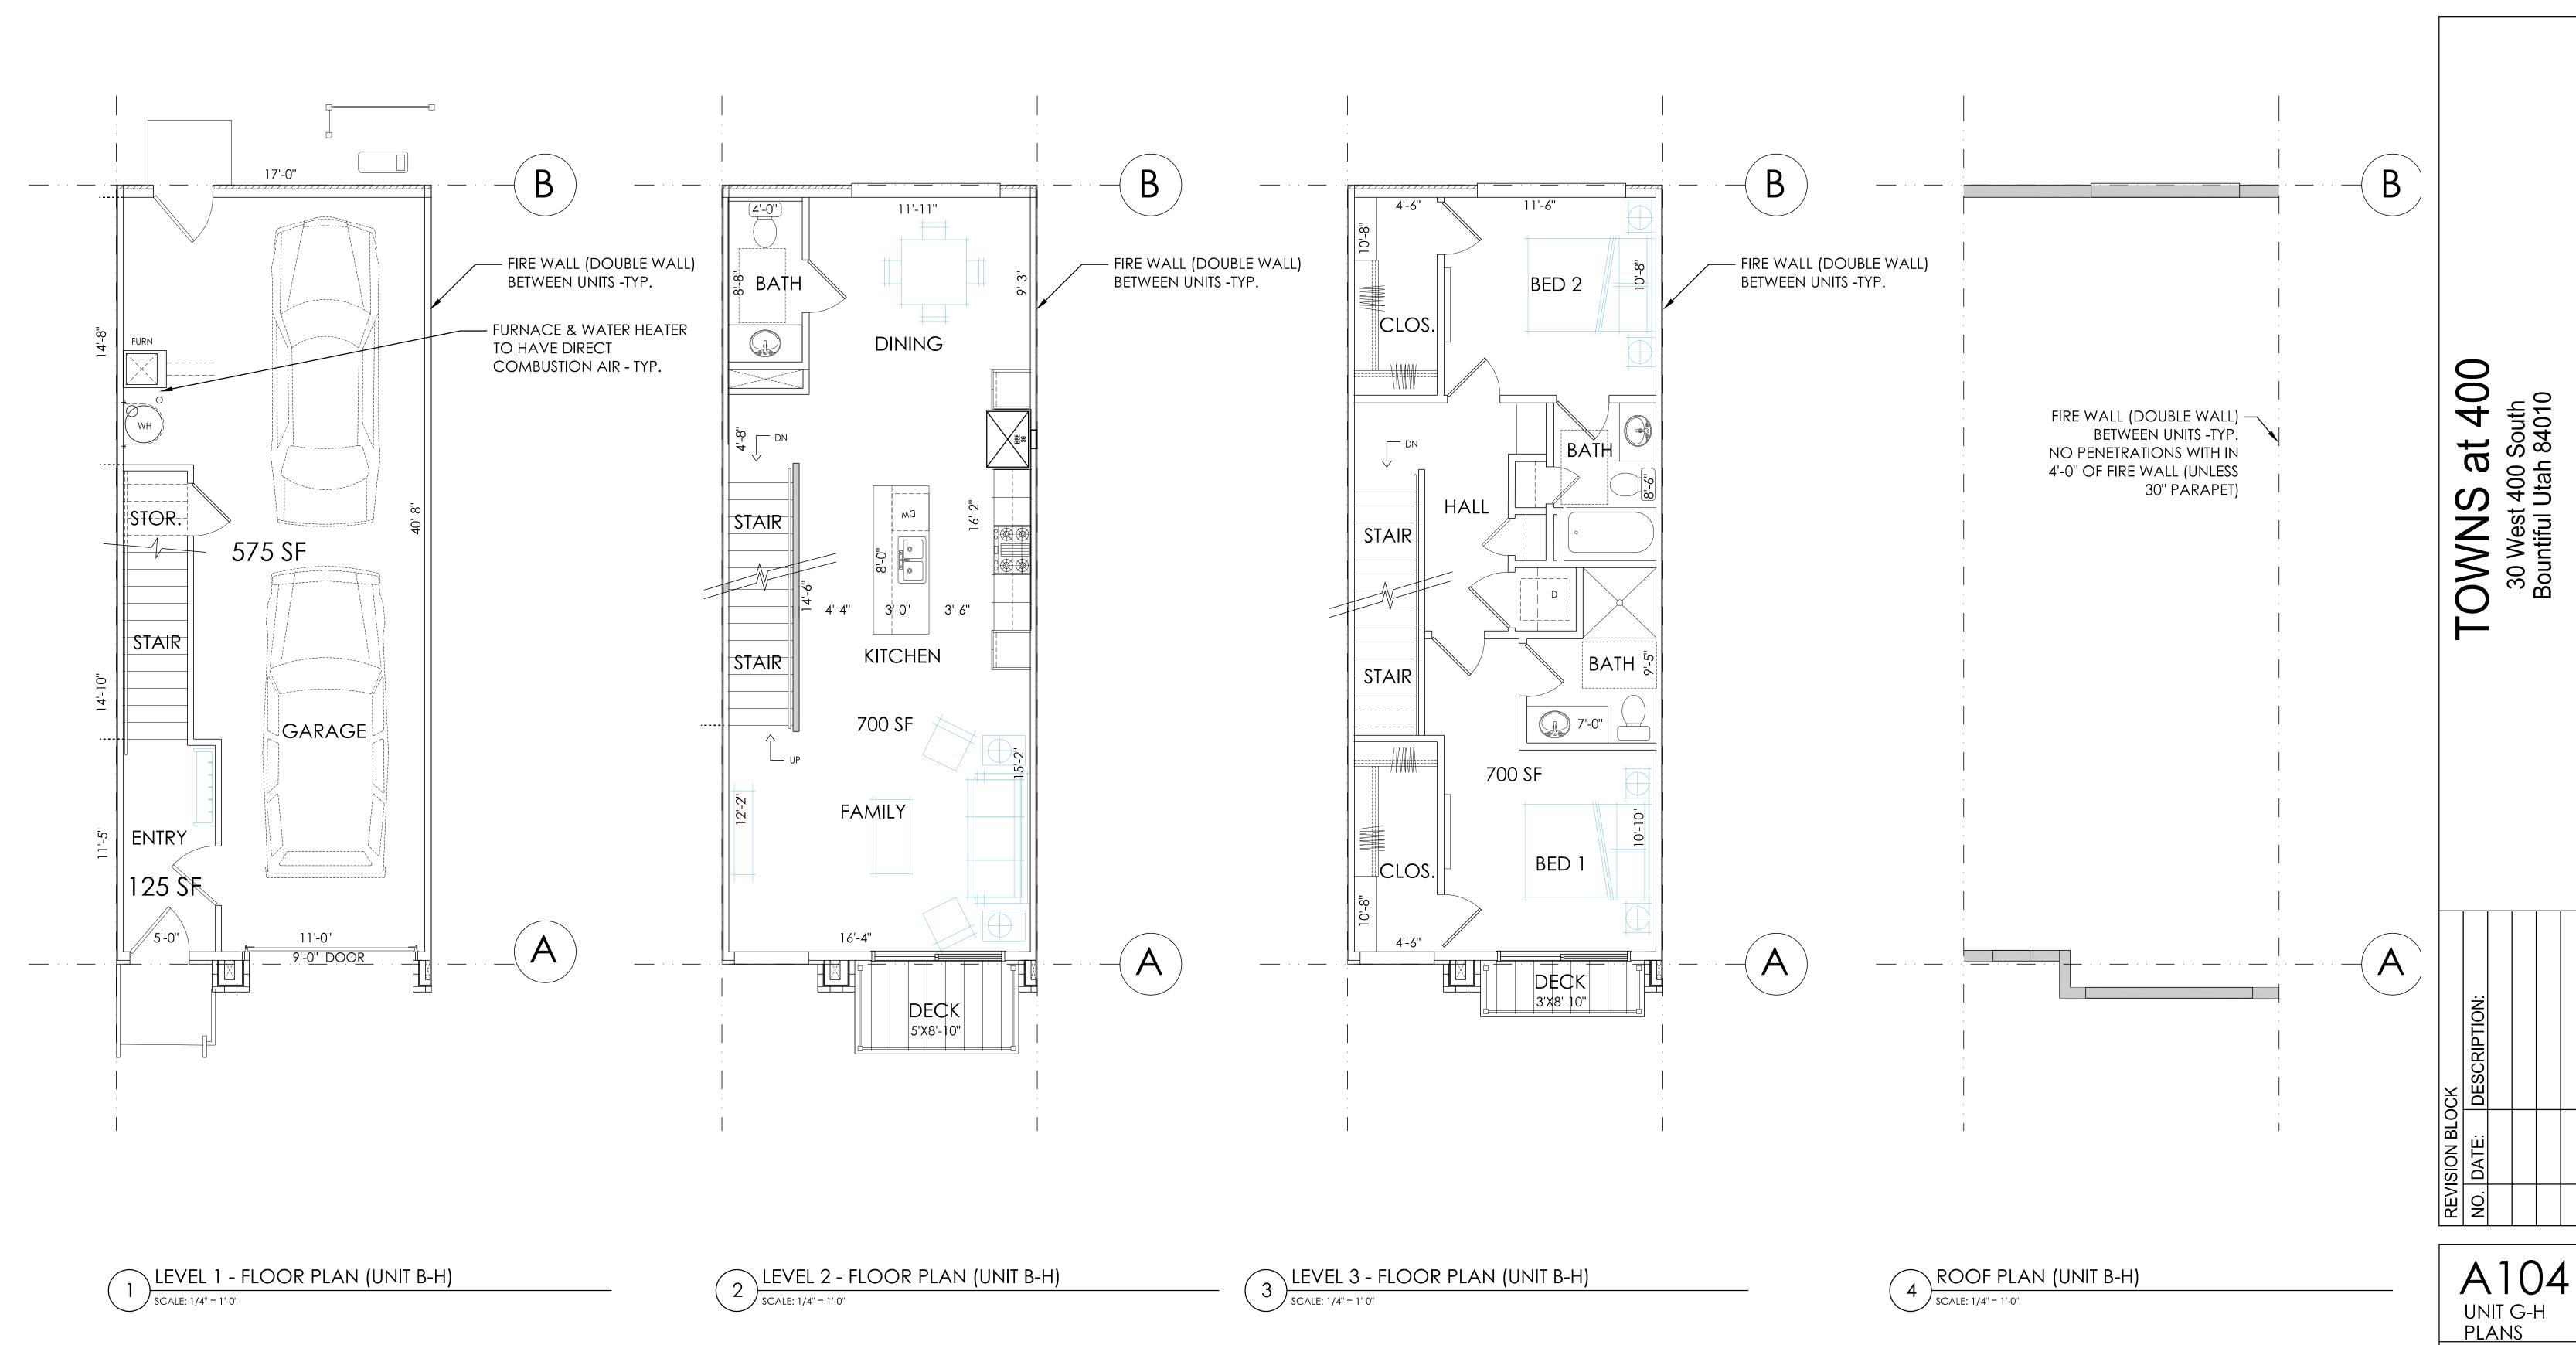
A102 LEVEL 3&ROOF

date: 11.17.2022



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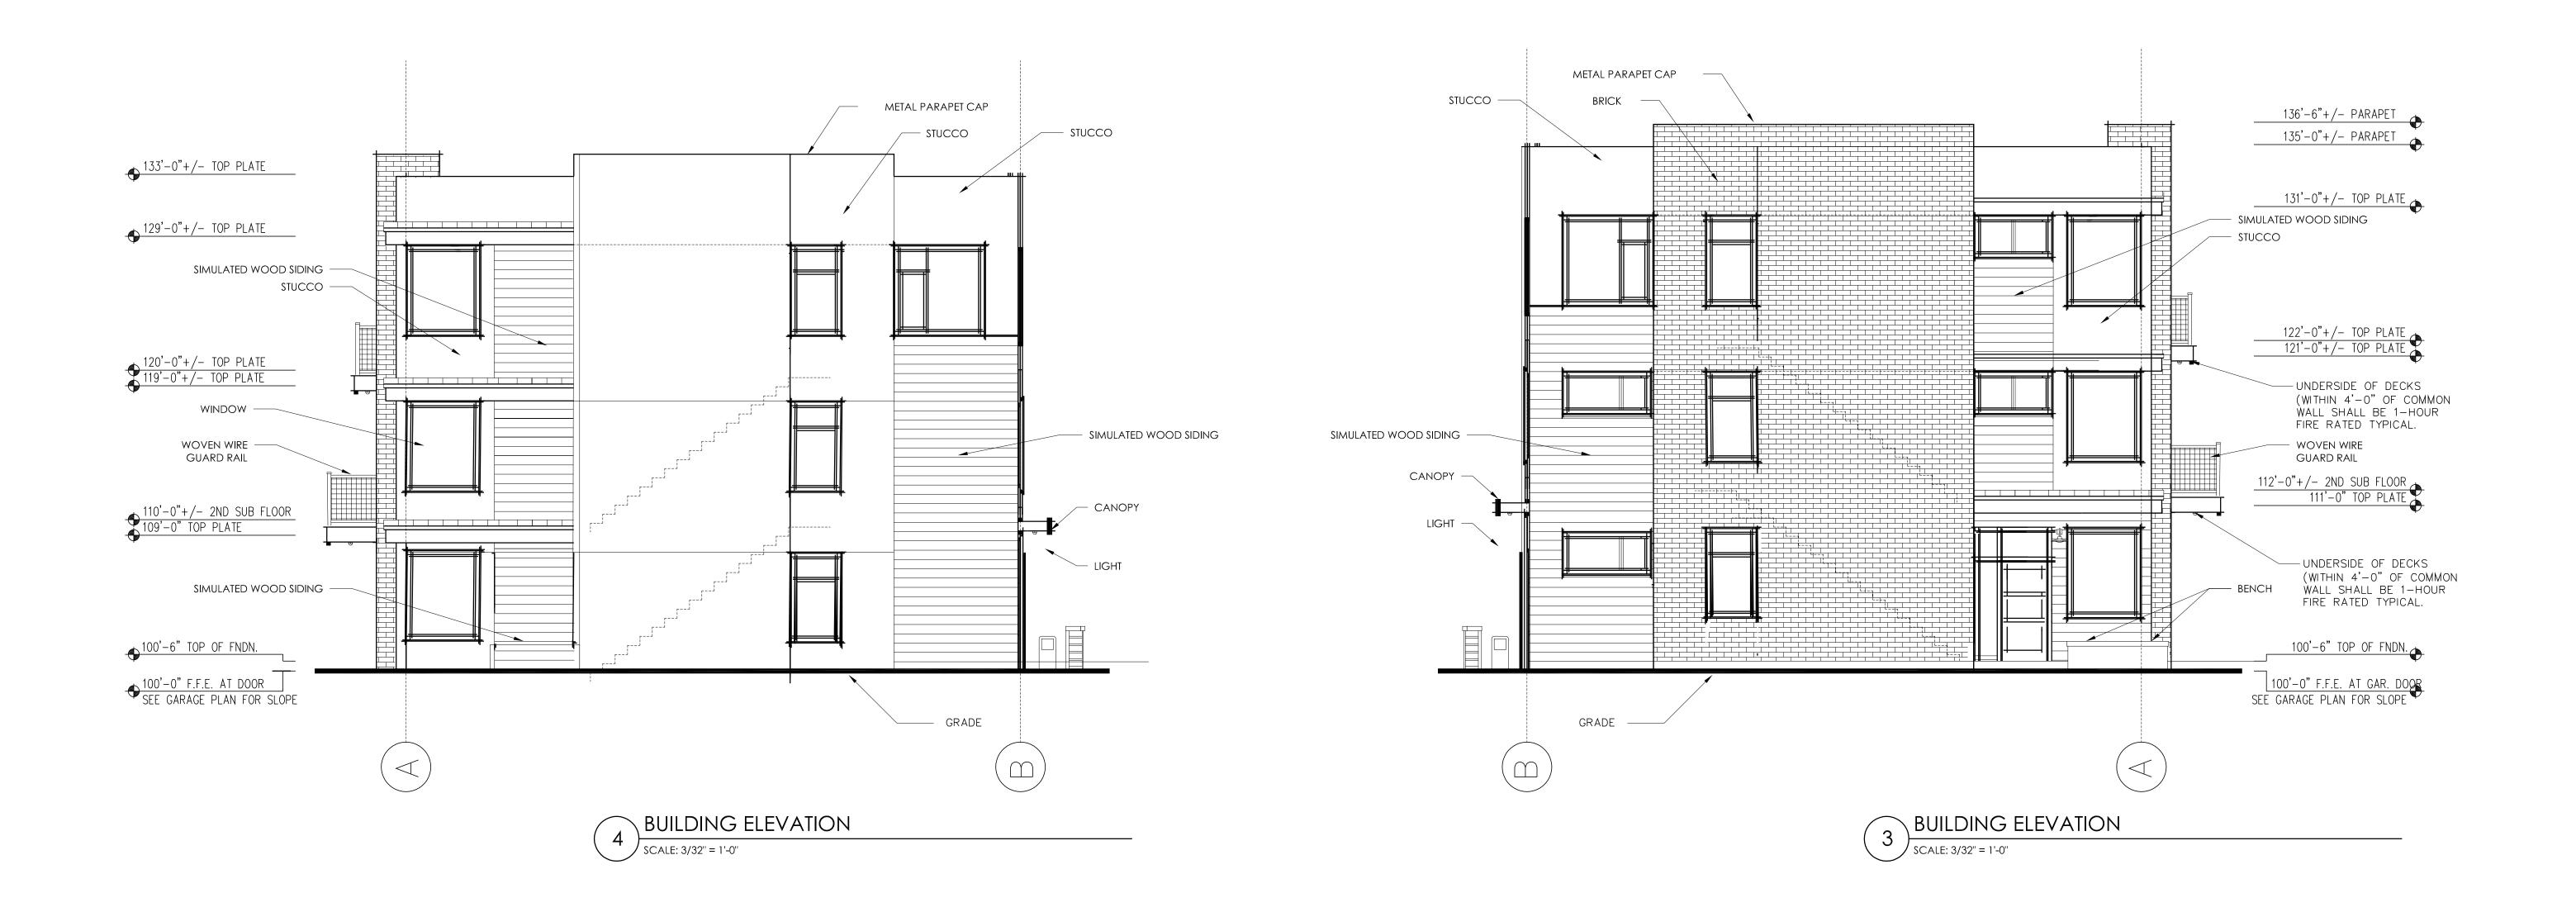


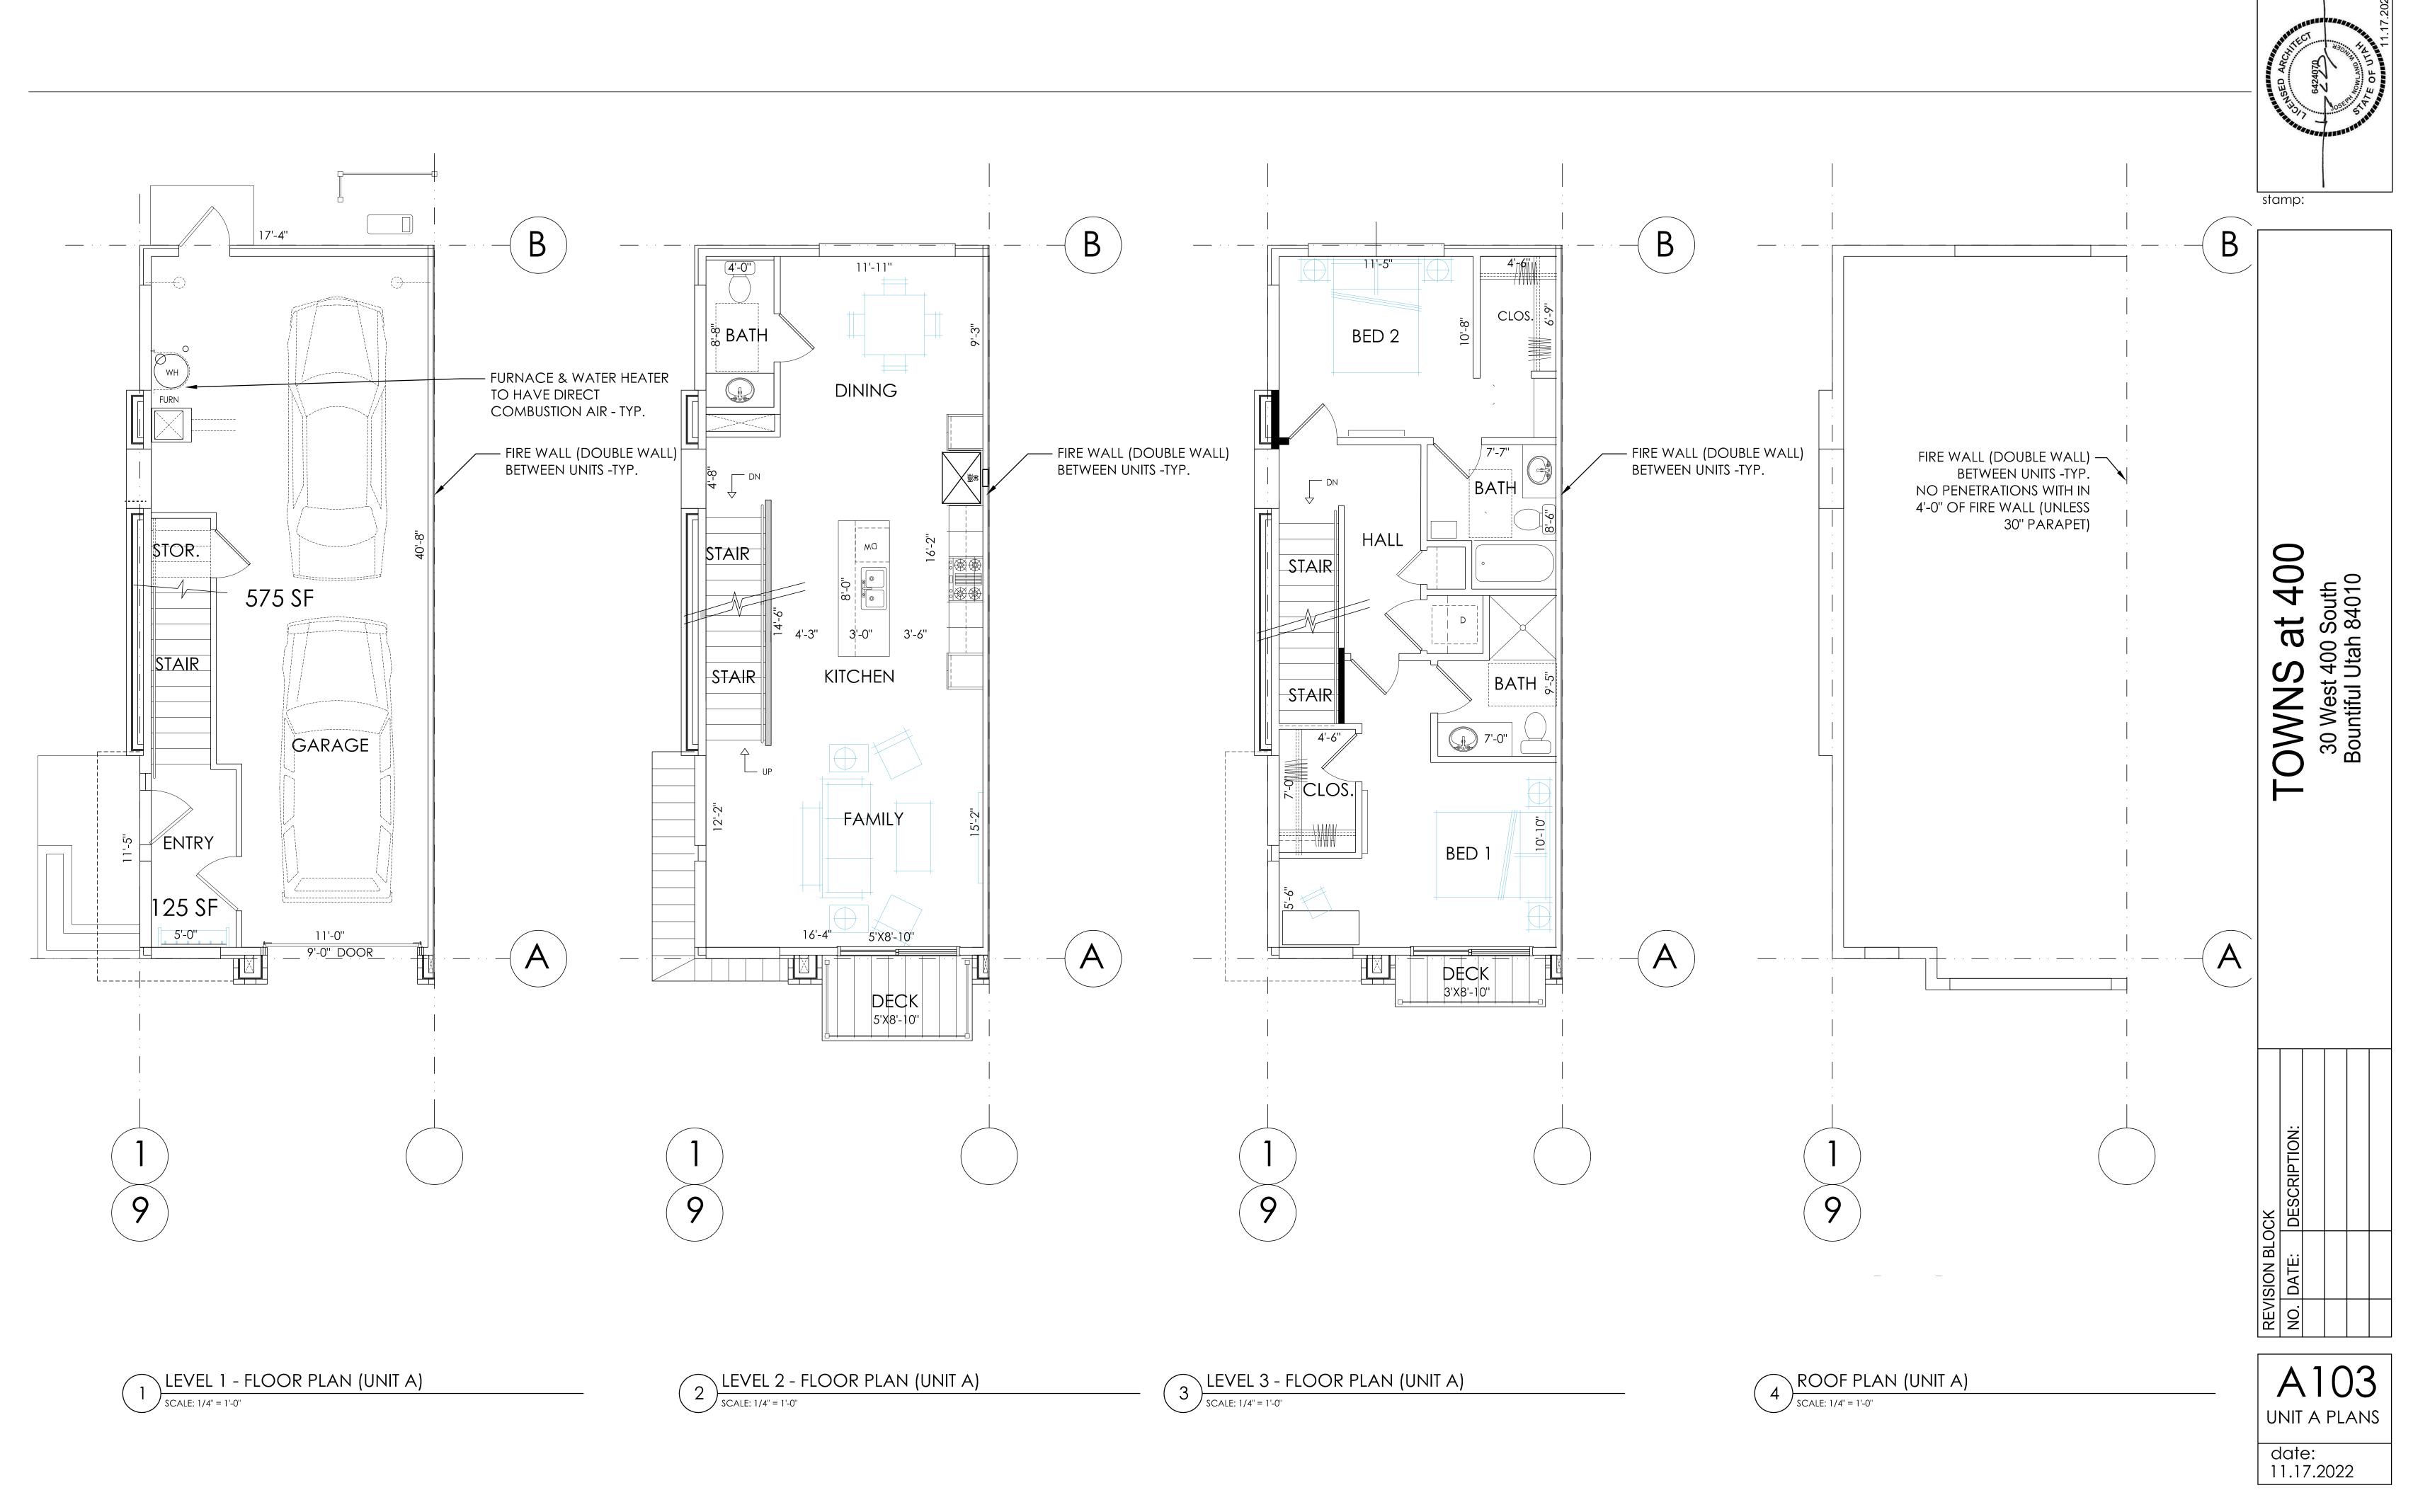
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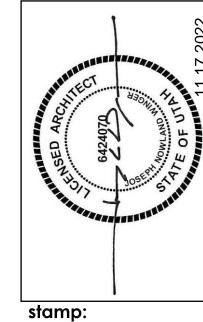
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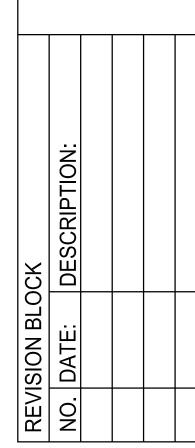






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A202
ELEV & SECT
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11.17.2022

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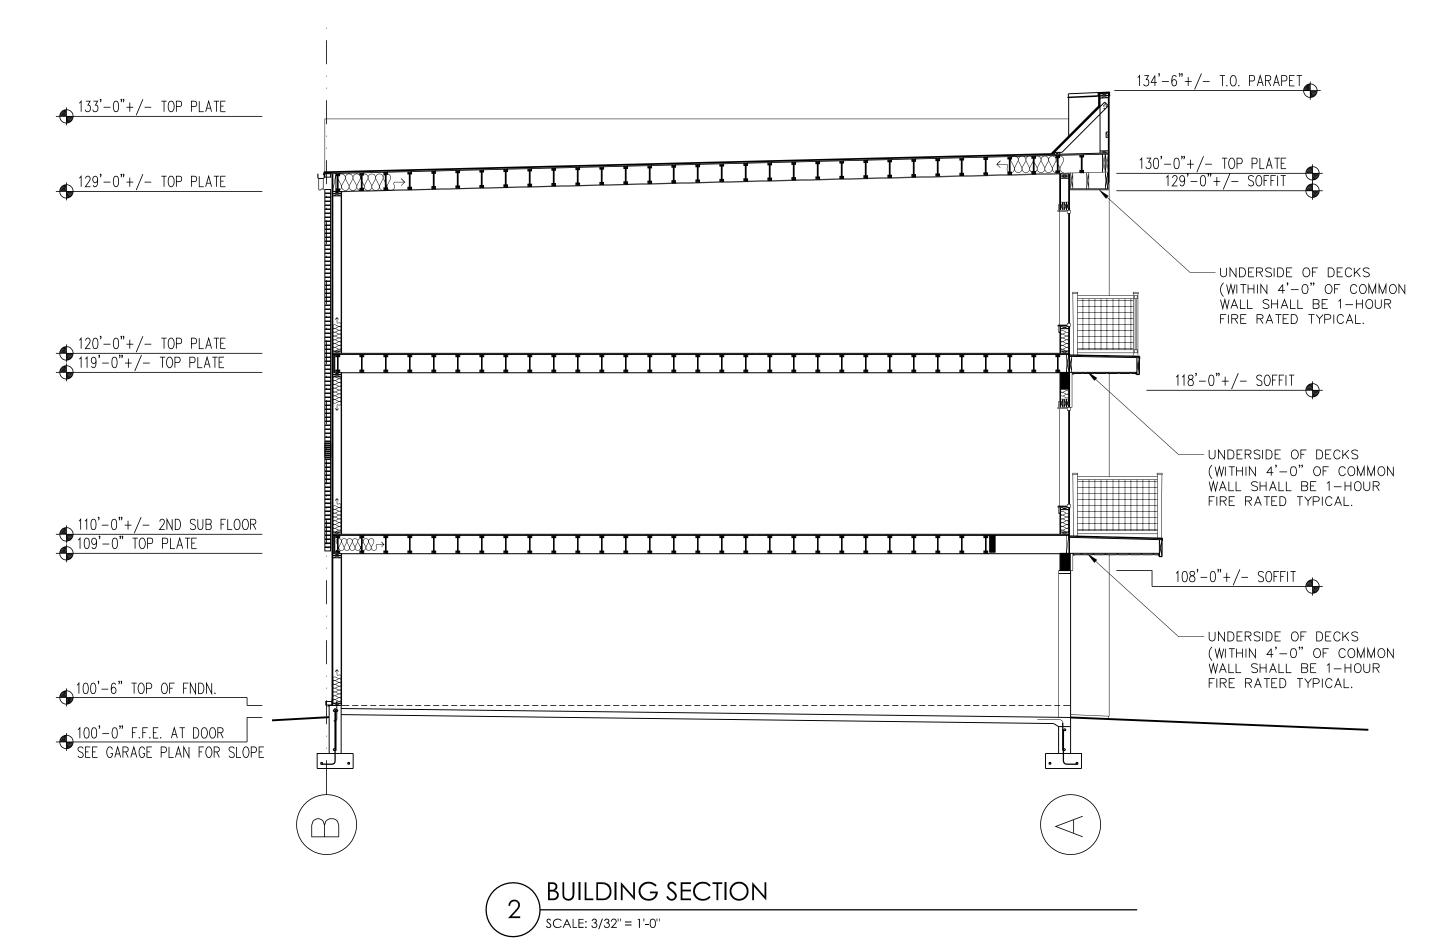
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SECT & DETAIL

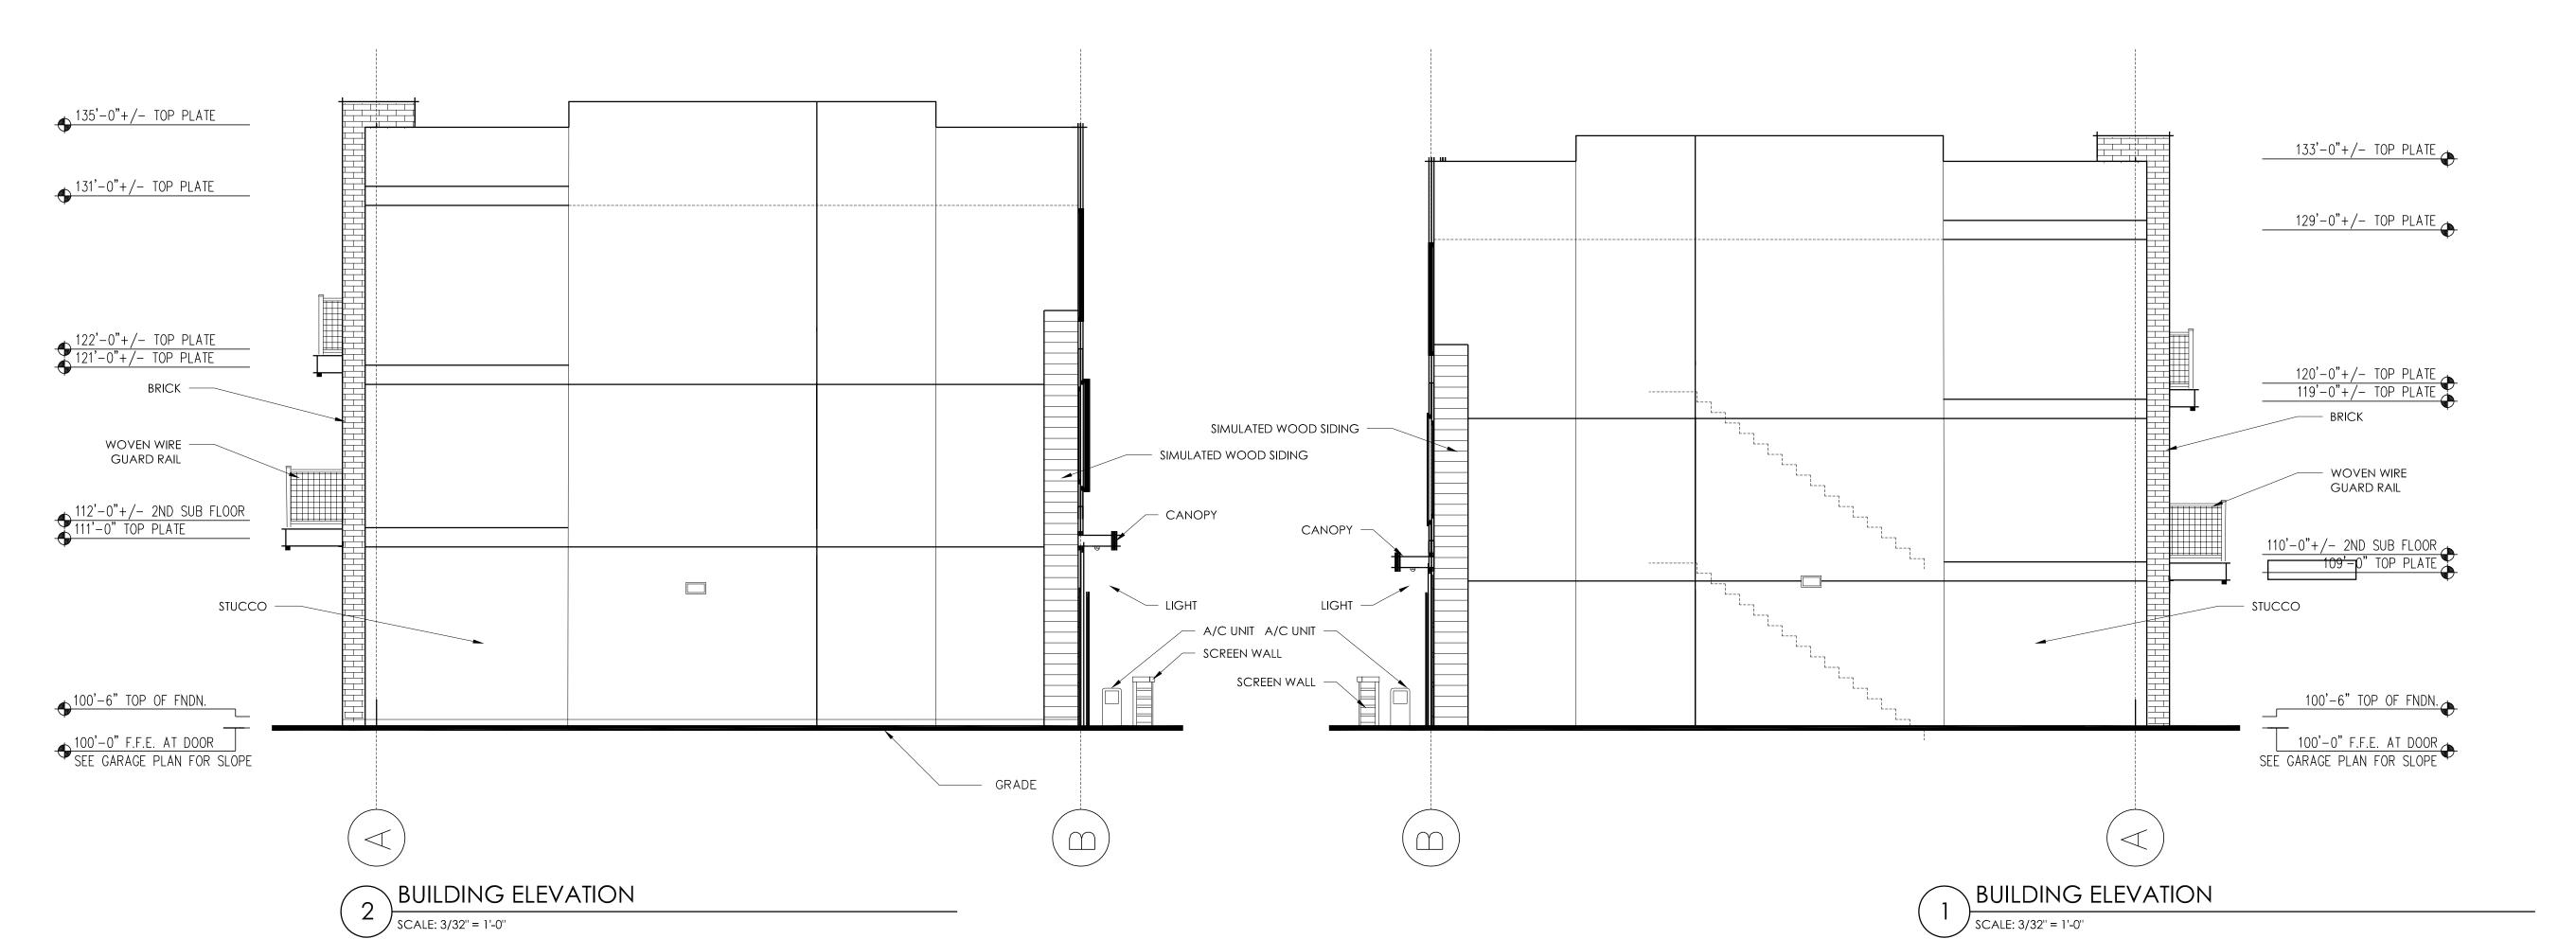
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11.17.2022

BUILDING SECTION

SCALE: 3/32" = 1'-0"



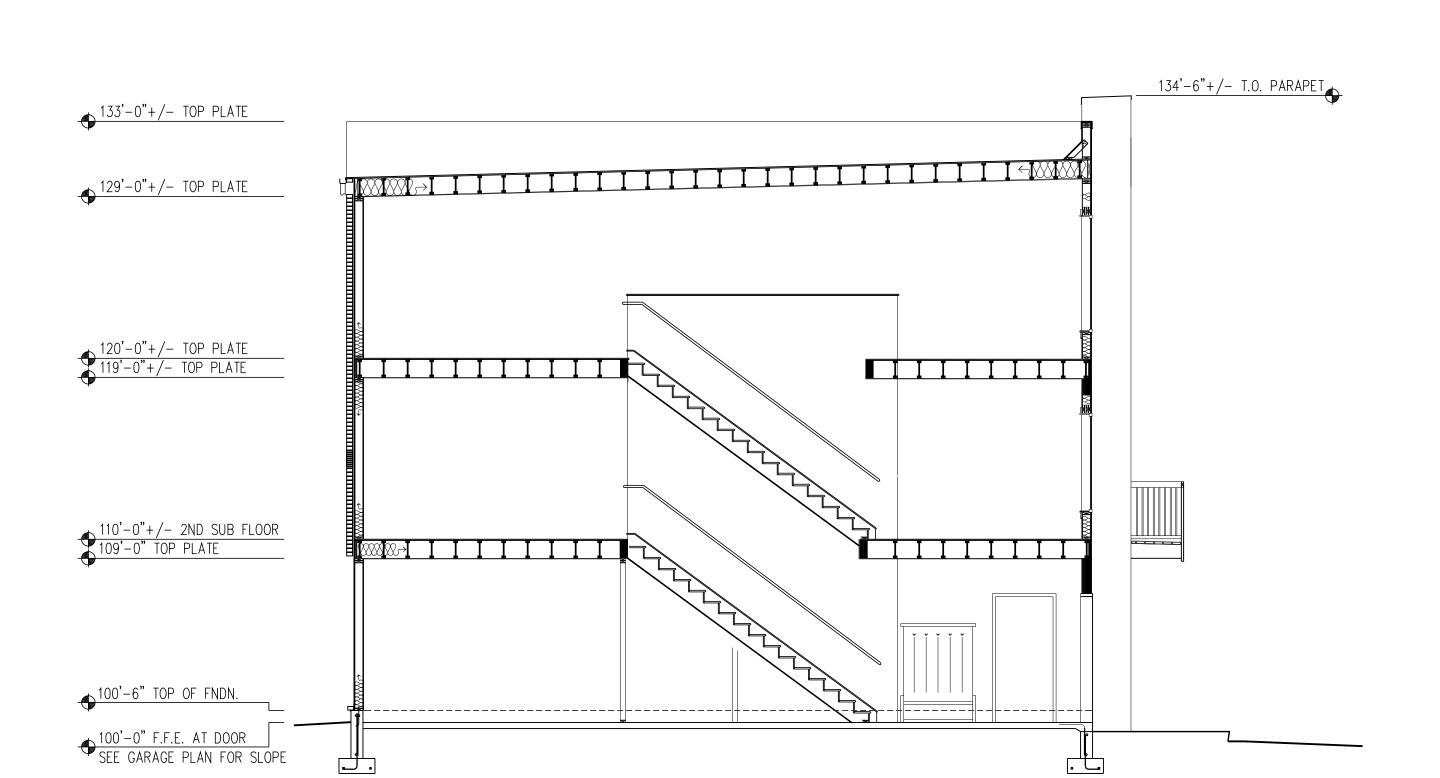

# BOUNTIFUL 390 APARTMENTS CONSTRUCTION DRAWINGS

11/17/2022

LEGEND EXISTING



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——————————————————————————————————————	——————————————————————————————————————
— W — CULINARY WATER LINE	— W — CULINARY WATER LINE (SIZE SHOWN ON PLAN)
——————————————————————————————————————	SANITARY SEWER LINE (SIZE SHOWN ON PLAN)
———— sd ————— STORM DRAIN LINE	——————————————————————————————————————
ir IRRIGATION LINE	
———— g ———— GAS LINE	GAS LINE
e UNDERGROUND POWER LINE	— E — UNDERGROUND POWER LINE
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#### CONTOUR MINOR	
— — — #### — — CONTOUR MAJOR	
× FENCE	——————————————————————————————————————
ASPHALT PAVEMENT	— — — — BUILDING SETBACK
CLOSED FACE CURB AND GUTTER	ASPHALT PAVEMENT
OPEN FACE CURB AND GUTTER	CLOSED FACE CURB & GUTTER
CONCRETE PAVEMENT	OPEN FACE CURB & GUTTER
EXISTING TO BE REMOVED	CURB & GUTTER TRANSITION
WATER VALVE	CONCRETE PAVEMENT
FIRE HYDRANT	WATER VALVE
WATER METER	FIRE HYDRANT
S SEWER MANHOLE	WATER METER
STORM DRAIN BOX	S SEWER MANHOLE
STORM WATER CATCH BASIN	STORM DRAIN BOX
——— ROAD SIGN	STORM WATER CATCH BASIN
POWER POLE	—■— ROAD SIGN
DECIDUOUS TREE	
CONIFEROUS TREE	

Sheet List Table					
Sheet Number	Sheet Title				
C001	COVER & LEGEND				
C101	DEMOLITION PLAN				
C102	SITE & DIMENSION PLAN				
C201	GRADING PLAN				
C301	STORM DRAIN & UTILITY PLAN				
C501	DETAILS				
C502	DETAILS				
C503	DETAILS				

- ALL MATERIALS, WORKMANSHIP, CONSTRUCTION AND PLACEMENT SHALL MEET OR EXCEED THE STANDARDS AND SPECIFICATIONS AS DEFINED IN THE MANUAL OF STANDARD SPECIFICATIONS AND MANUAL OF STANDARD PLANS, UTAH CHAPTER AMERICAN PUBLIC WORKS ASSOCIATION (APWA) AND APPLICABLE CITY, COUNTY, STATE AND FEDERAL REGULATIONS. WHERE THERE IS A CONFLICT BETWEEN THESE PLANS, SPECIFICATIONS OR ANY APPLICABLE STANDARD, THE MOST RESTRICTIVE STANDARD SHALL APPLY.
- 2. ALL REFERENCES TO ANY PUBLISHED STANDARDS SHALL REFER TO THE LATEST REVISION OF SAID STANDARD, UNLESS SPECIFICALLY STATED OTHERWISE. WORK SHALL BE ACCOMPLISHED IN ACCORDANCE WITH THE UTAH CHAPTER OF AMERICAN PUBLIC WORKS ASSOCIATION (APWA) STANDARD PLANS AND
- SPECIFICATIONS, 2017 EDITION. 4. THE CONTRACTOR WILL BE RESPONSIBLE FOR FIELD LOCATING AND VERIFYING ELEVATIONS OF ALL EXISTING SEWER MAINS, WATER MAINS, CURBS, GUTTERS AND OTHER UTILITIES AT THE POINTS OF CONNECTION SHOWN ON THE PLANS AND AT ANY UTILITY CROSSINGS PRIOR TO INSTALLING ANY OF THE SITE ELEMENTS INDICATED IN THESE PLANS. IF A CONFLICT EXISTS AND/OR A DESIGN MODIFICATION IS REQUIRED, THE CONTRACTOR SHALL COORDINATE WITH THE ENGINEER. DESIGN MODIFICATION(S) MUST BE APPROVED BY THE OWNER PRIOR TO BEING IMPLEMENTED.
- THE CONTRACTOR IS SPECIFICALLY CAUTIONED THAT THE LOCATION AND/OR ELEVATIONS OF EXISTING UTILITIES, AS INDICATED ON THESE PLANS, IS BASED ON RECORDS OF THE VARIOUS UTILITY COMPANIES AND, WHERE POSSIBLE, MEASUREMENTS TAKEN IN THE FIELD. THE INFORMATION IS NOT TO BE RELIED UPON AS BEING EXACT OR COMPLETE. THE CONTRACTOR SHALL CONTACT BLUE STAKES (BY DIALING 811) AT LEAST 2 WORKING DAYS PRIOR TO BEGINNING EXCAVATION. TRENCHING OR GRADING TO HAVE ALL REGISTERED UTILITY LOCATIONS MARKED. ALL OTHER UN-REGISTERED UTILITIES (I.E. DITCH, IRRIGATION COMPANY, OTHER SITE-SPECIFIC UTILITIES, ETC.) ARE TO BE LOCATED BY CONTACTING, IN ADVANCE. THE RESPECTIVE REPRESENTATIVE. UTILITY SERVICE LATERALS SHOULD ALSO BE LOCATED PRIOR TO BEGINNING EXCAVATION, TRENCHING OR GRADING ACTIVITIES.
- 6. THE CONTRACTOR SHALL COORDINATE AND COOPERATE WITH THE PROJECT OWNER, LOCAL JURISDICTION AND ALL UTILITY COMPANIES INVOLVED REGARDING RELOCATIONS, ADJUSTMENTS, EXTENSIONS AND REARRANGEMENTS OF EXISTING UTILITIES DURING CONSTRUCTION, AND TO ASSURE THAT THE WORK IS ACCOMPLISHED IN A TIMELY FASHION AND WITH MINIMAL DISRUPTION OF SERVICE. THE CONTRACTOR SHALL BE RESPONSIBLE FOR CONTACTING, IN ADVANCE, ALL PARTIES AFFECTED BY ANY DISRUPTION OF UTILITY SERVICE AS WELL AS THE UTILITY

- 7. THE CONTRACTOR SHALL BE RESPONSIBLE FOR PROTECTING ALL UTILITIES DURING CONSTRUCTION AND FOR COORDINATING WITH THE APPROPRIATE UTILITY COMPANY FOR ANY UTILITY CROSSINGS REQUIRED. THE CONTRACTOR SHALL BE RESPONSIBLE FOR THE COST OF ALL MEANS REQUIRED TO PROTECT EXISTING UTILITIES AND/OR TO WORK AROUND SUCH UTILITIES. THIS INCLUDES, BUT IS NOT LIMITED TO, SUPPORTING EXISTING UTILITIES, SHORING AROUND EXITING UTILITIES, PHASING OF WORK AND TRAFFIC CONTROL.
- 8. THE CONTRACTOR SHALL NOTIFY THE LOCAL JURISDICTION AND AFFECTED UTILITY COMPANY, AND ALL AFFECTED PARTIES A MINIMUM OF 24 HOURS PRIOR TO ANY WATER INTERRUPTION.
- 9. THE CONTRACTOR IS NOT TO OPERATE ANY VALVES, FIRE HYDRANTS AND OTHER APPURTENANCES. COORDINATE WITH THE UTILITY SUPPLIER. 10. THE CONTRACTOR SHALL BE RESPONSIBLE FOR ALL ASPECTS OF SAFETY. INCLUDING, BUT NOT LIMITED TO, EXCAVATION, TRENCHING, SHORING, TRAFFIC CONTROL, SECURITY AND OTHER SITE RELATED SAFETY PRACTICES. REFER TO OSHA
- PUBLICATION 2226, EXCAVATING AND TRENCHING. 11. IF DURING CONSTRUCTION CONDITIONS ARE ENCOUNTERED WHICH COULD INDICATE A SITUATION THAT IS NOT IDENTIFIED IN THE PLANS OR SPECIFICATIONS, THE CONTRACTOR SHALL CONTACT THE ENGINEER IMMEDIATELY.
- 12. THE CONTRACTOR SHALL SUBMIT A CONSTRUCTION TRAFFIC CONTROL PLAN TO THE REVIEWING AGENCY (LOCAL GOVERNMENT, UDOT OR OTHERS AS REQUIRED BY PERMIT) FOR REVIEW AND ACCEPTANCE, PRIOR TO ANY CONSTRUCTION ACTIVITIES WITHIN, OR AFFECTING THE RIGHT-OF-WAY. ALL TRAFFIC CONTROL PLANS SHALL BE IN ACCORDANCE WITH MUTCD OR UDOT STANDARDS. THE CONTRACTOR SHALL BE RESPONSIBLE FOR PROVIDING ALL TRAFFIC CONTROL DEVICES, PERSONNEL AND OTHER FACILITIES AS MAY BE REQUIRED BY THE CONSTRUCTION ACTIVITIES.
- 13. THE CONTRACTOR SHALL HAVE ONSITE AT ALL TIMES AN UP TO DATE STORM WATER POLLUTION PREVENTION PLAN (SWPPP), A BMP MAINTENANCE FOLDER, ONE (1) SIGNED COPY OF THE APPROVED PLANS, ONE (1) COPY OF THE APPROPRIATE STANDARDS AND SPECIFICATIONS, AND A COPY OF ANY PERMITS AND AGREEMENTS NEEDED FOR THE JOB.
- 14. THE CONTRACTOR SHALL COMPLY WITH ALL TERMS AND CONDITIONS OF THE UTAH PERMIT FOR STORM WATER DISCHARGE, THE SWPPP AND THE EROSION CONTROL 15. ALL BMPS SHALL BE INSTALLED AT THE LIMITS OF CONSTRUCTION AND AT AREAS WITH

DISTURBED SOIL (ON OR OFF SITE) PRIOR TO ANY OTHER GROUND DISTURBING

ACTIVITY. ALL BMPS SHALL BE MAINTAINED IN GOOD REPAIR BY THE CONTRACTOR,

- UNTIL THE ENTIRE DISTURBED AREA IS STABILIZED WITH HARD SURFACING OR
- LANDSCAPING. 16. MUD AND DEBRIS MUST BE REMOVED BY THE END OF EACH WORKING DAY BY AN APPROPRIATE MECHANICAL METHOD (I.E. MACHINE BROOM SWEEP, HAND SWEEPING,

LEGEND PROPOSED


- 17. THE CONTRACTOR SHALL BE RESPONSIBLE FOR RECORDING AS-CONSTRUCTED INFORMATION ON A SET OF RECORD DRAWINGS KEPT ON THE CONSTRUCTION SITE. THIS RECORD DRAWING SET SHALL BE AVAILABLE TO THE OWNERS/ENGINEERS DESIGNATED REPRESENTATIVE AT ALL TIMES.
- 18. WORK ACTIVITY AND SCHEDULES SHALL BE COORDINATED WITH THE OWNER AND THEIR ACTIVITIES ON-SITE.
- 19. UPON COMPLETION OF CONSTRUCTION, THE SITE SHALL BE CLEANED AND RESTORED TO A CONDITION EQUAL TO, OR BETTER THAN, THAT WHICH EXISTED BEFORE CONSTRUCTION, OR TO THE GRADES AND CONDITION AS REQUIRED BY THESE PLANS
- 20. IMPROVEMENTS DEPICTED IN THESE PLANS AND CONSTRUCTED BY THE CONTRACTOR SHALL BE GUARANTEED BY THE CONTRACTOR TO BE FREE FROM MATERIAL AND WORKMANSHIP DEFECTS FOR A PERIOD OF ONE YEAR FROM THE DATE OF
- 21. THE APPROVED, DESIGNATED PROJECT SUPERVISOR SHALL BE ON-SITE WHILE WORK IS BEING CONDUCTED.

22. SOIL COMPACTION EFFORT SHALL BE PER GEOTECHINCAL REPORT BY CIVIL SOLUTIONS GROUP.



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PROJECT MANAGER: W. SOUTHWICK

- DESIGNING OUR FUTURE

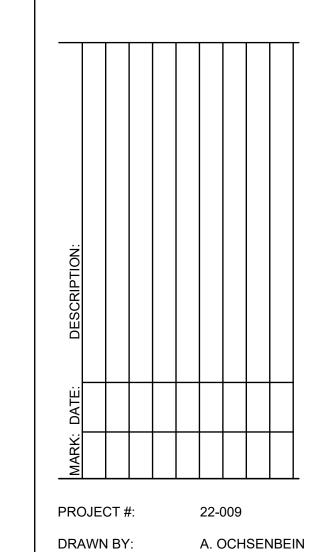December 6, 2022 Bountiful City Planning Commission

1 DEMOLITION PLAN SHEET KEY NOTES:
ALL ITEMS CALLED OUT TO BE REMOVED SHALL BE DISPOSED OF IN AN APPROPRIATE MANNER AND LOCATION:

- 1. SAWCUT CONCRETE PAVEMENT
- 2. SAWCUT ASPHALT PAVEMENT 3. REMOVE CONCRETE PAVEMENT
- 4. REMOVE ASPHALT PAVEMENT 5. REMOVE CURB & GUTTER 6. REMOVE STORM WATER LINE
- 7. REMOVE STORM WATER STRUCTURE (SUMP)
- 8. REMOVE LIGHT POLE 9. REMOVE TRASH ENCLOSURE
  10. REMOVE CONCRETE PAD AND RELOCATE ELECTRICAL EQUIPMENT. SEE

Know what's **below**.

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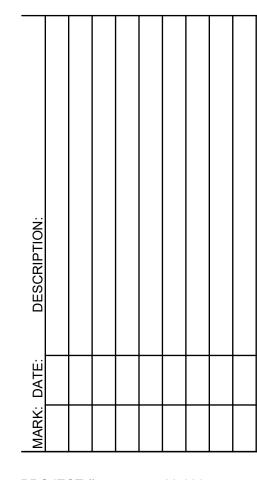
UTILITY PLAN FOR PROPOSED LOCATIONS.

11. REMOVE CONCRETE WATERWAY

#### **GENERAL NOTES:**

1. ALL ITEMS NOT CALLED OUT FOR REMOVAL ARE TO REMAIN

400 JTH



PROJECT #: 22-009 A. OCHSENBEIN DRAWN BY: PROJECT MANAGER: W. SOUTHWICK

ISSUED: 11/17/2022



DEMOLITION PLAN

C101

- DESIGNING OUR FUTURE —


December 6, 2022 Bountiful City Planning Commission

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1 SITE SHEET KEY NOTES:
PROVIDE, INSTALL, AND/OR CONSTRUCT THE FOLLOWING PER THE SPECIFICATIONS GIVEN OR REFERENCED, THE DETAILS NOTED, AND/OR AS SHOWN ON THE CONSTRUCTION DRAWINGS:

STANDARD DUTY CONCRETE PAVEMENT (1/C501)
HEAVY DUTY CONCRETE PAVEMENT (2/C501)
CONCRETE STAIRS. SEE ARCHITECTURAL PLANS FOR DETAILS.

CURB (10/C501)

DRIVEWAY APPROACH (5/C501)

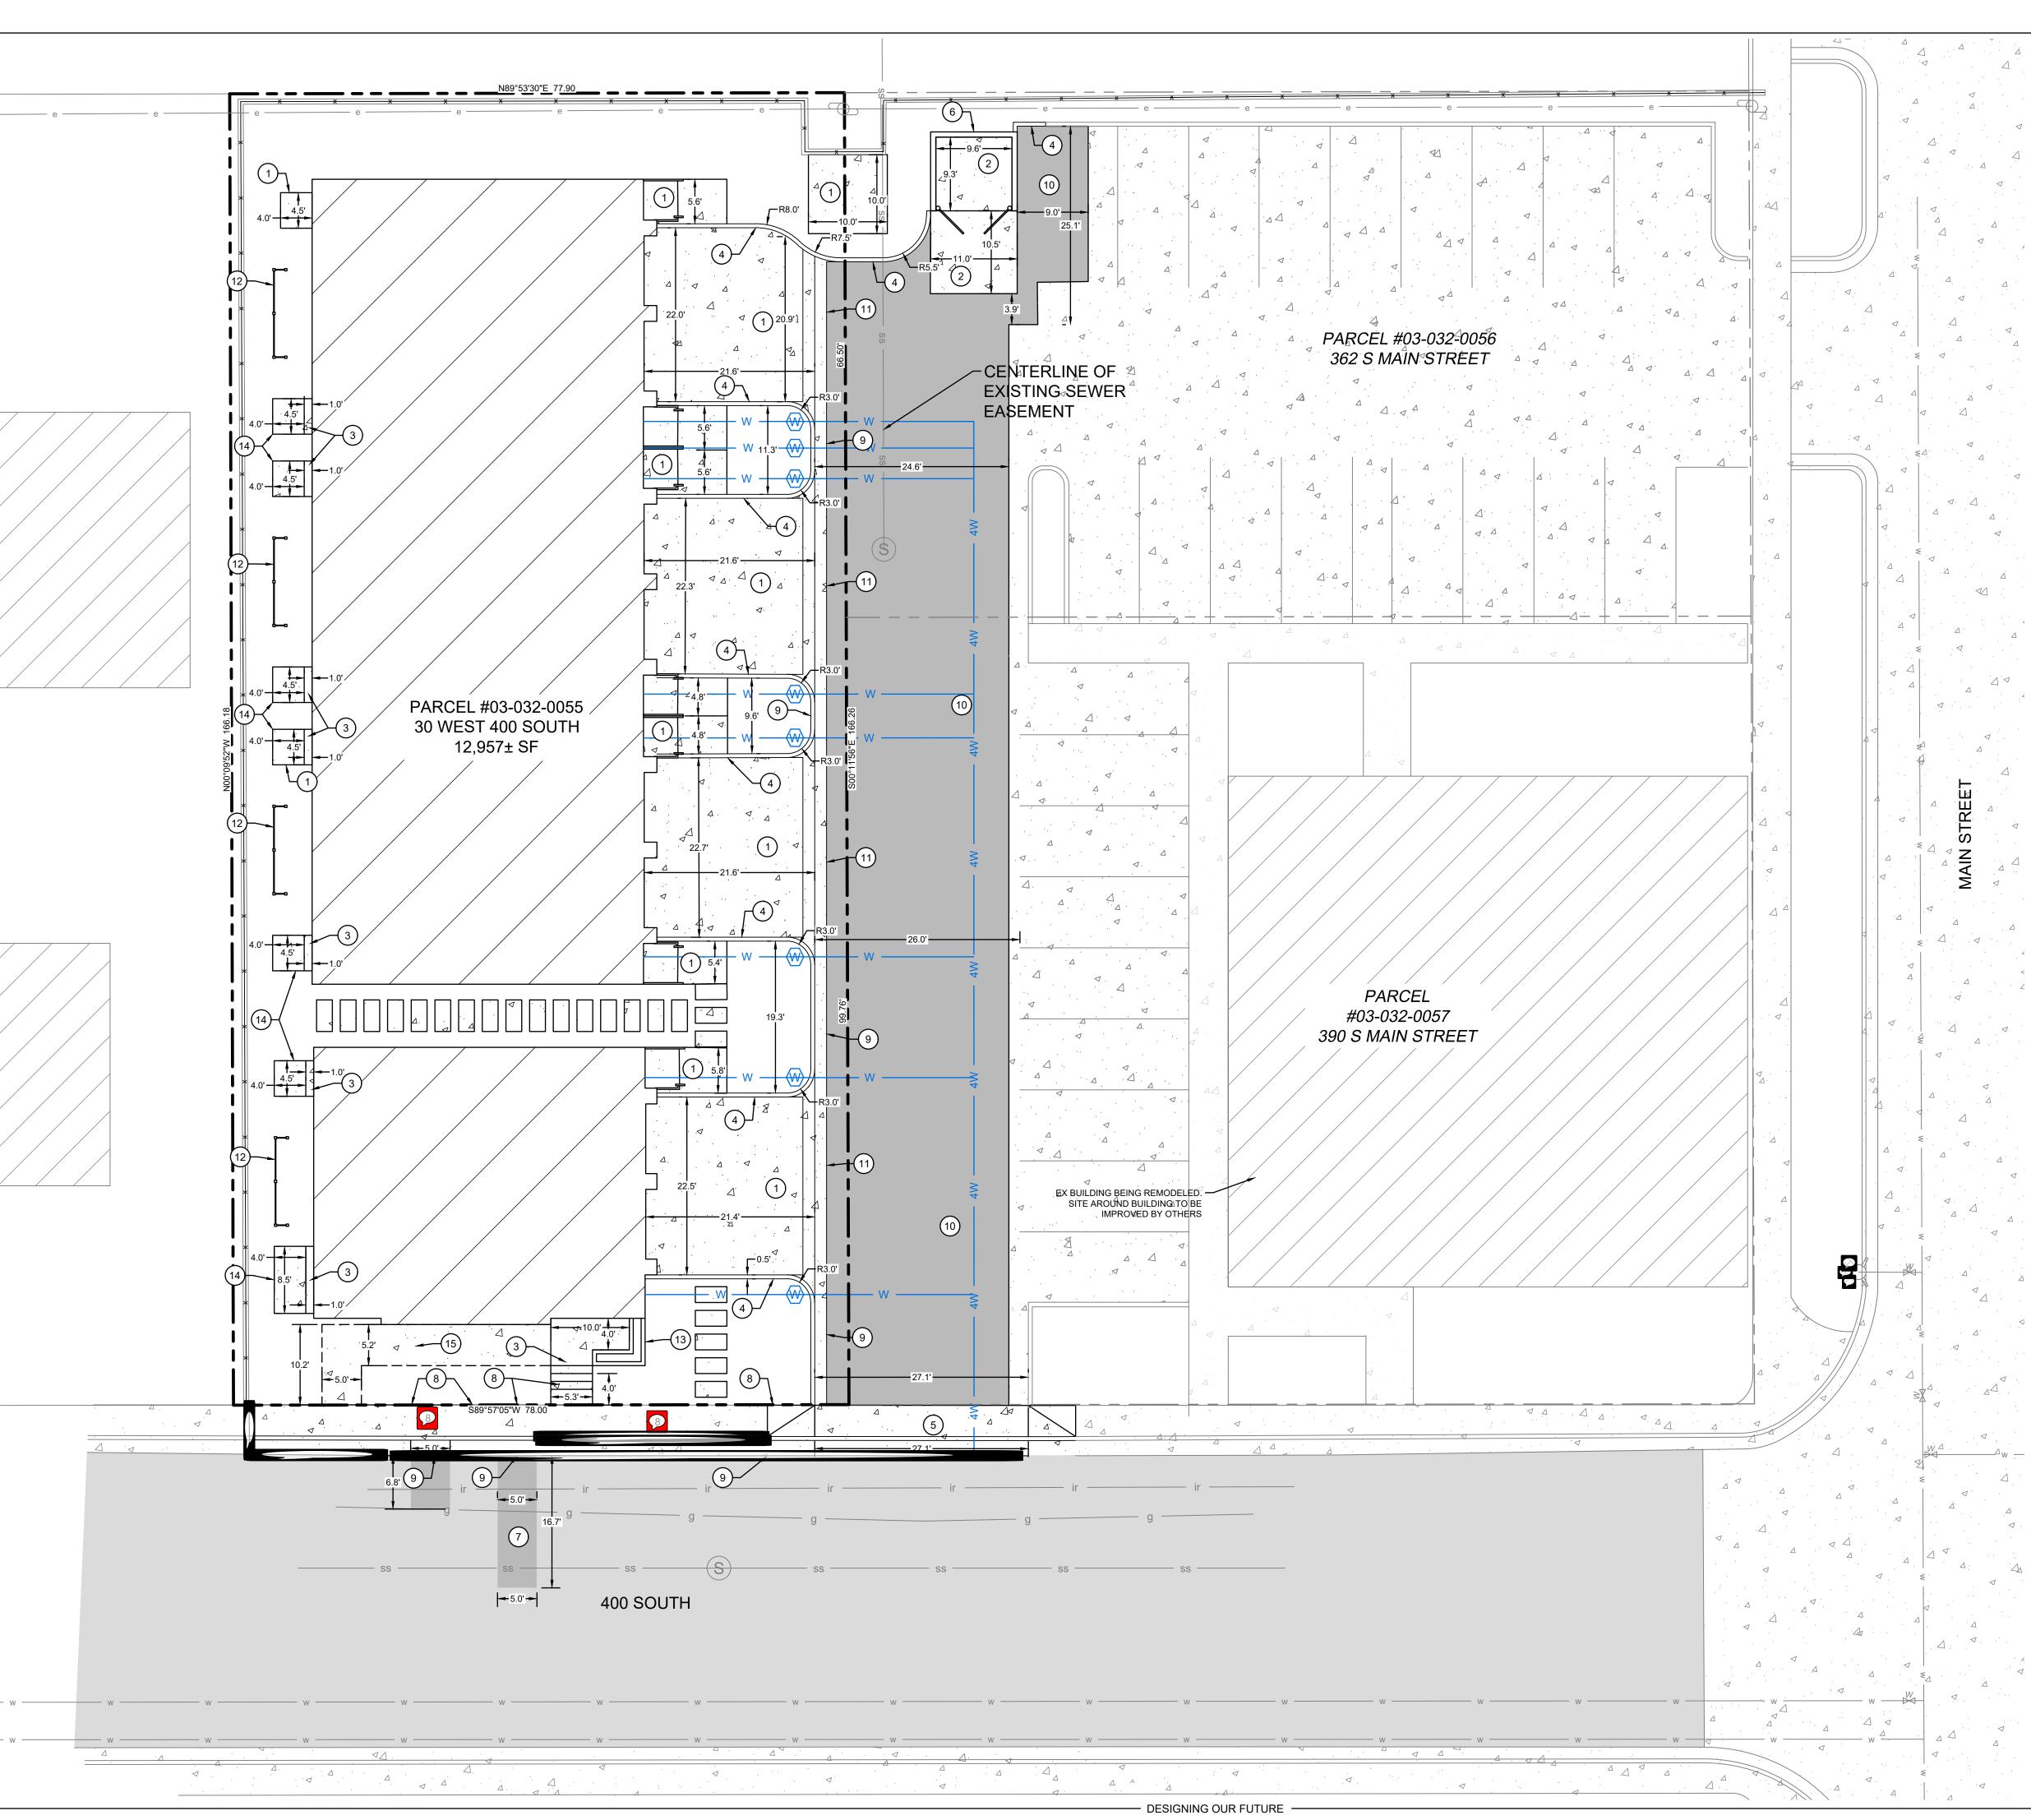DUMPSTER ENCLOSURE. SEE ARCHITECTURAL PLANS FOR DETAILS.

ASPHALT PAVEMENT PATCH(1/C502)

SIDEWALK (4/C501)

9. APWA TYPE E CURB AND GUTTER (6/C501)
10. ASPHALT PAVEMENT (3/C501)
11. 3' CONCRETE WATERWAY (8/C501)

12. FENCE. SEE ARCHITECTURAL PLANS FOR DETAILS. 13. RAISED PLANTER. SEE ARCHITECTURAL PLANS FOR DETAILS. 14. THICKENED EDGE CONCRETE (9/C501) 15. OPTIONAL ADA RAMP (1/C501)

## **GENERAL NOTES:**

1. ALL DRIVE AISLES ARE TWO-WAY

### PARKING TABULATION:


- PARKING REQUIREMENTS FOR TOWNHOMES:
   1.1. 2 STALLS PER 2 BEDROOM UNIT
   1.2. 0.25 STALLS PER UNIT FOR VISITOR SPACE
   1.3. TOTAL PARKING REQUIRED: 18 STALLS
- PARKING PROVIDED WITHIN TOWNHOME UNIT: 2 STALLS PER UNIT 1.4. FARRING PROVIDED WITHIN TOWNHOMES: 16 STALLS
  1.5. TOTAL PARKING WITHIN TOWNHOMES: 16 STALLS
  1.6. TOTAL PARKING PROVIDED: 18 STALLS\*
  2. \*\*PARKING REQUIREMENTS FOR THE ADJACENT OFFICE BUILDING ARE AS

- 2.1. BUILDING SQUARE FOOTAGE: 7,251 SF
  2.2. PARKING REQUIREMENTS FOR OFFICE BUILDING: 1 STALL PER 300 SF
  2.3. PARKING STALLS REQUIRED FOR OFFICE BUILDING: 25 STALLS
  2.4. TOTAL STALLS ON OFFICE BUILDING LOT: 27 STALLS

\*2 STALLS WILL BE UTILIZED FROM THE OFFICE BUILDING PARKING TO PROVIDE THE REQUIRED 2 GUEST PARKING STALLS \*\*OFFICE BUILDING CALCULATIONS ARE SHOWN FOR THE PURPOSE OF INDICATING THERE IS SUFFICIENT STALLS TO PROVIDE 2 GUEST PARKING STALLS FOR THE TOWNHOME UNITS

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400 JTH

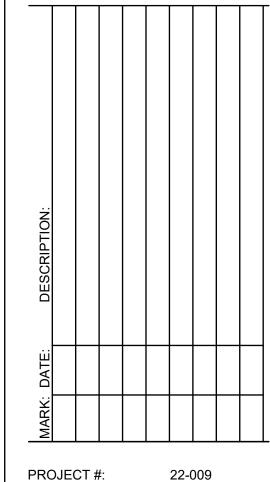

22-009 DRAWN BY: A. OCHSENBEIN

PROJECT MANAGER: W. SOUTHWICK ISSUED: 11/17/2022



SITE & DIMENSION PLAN

C102

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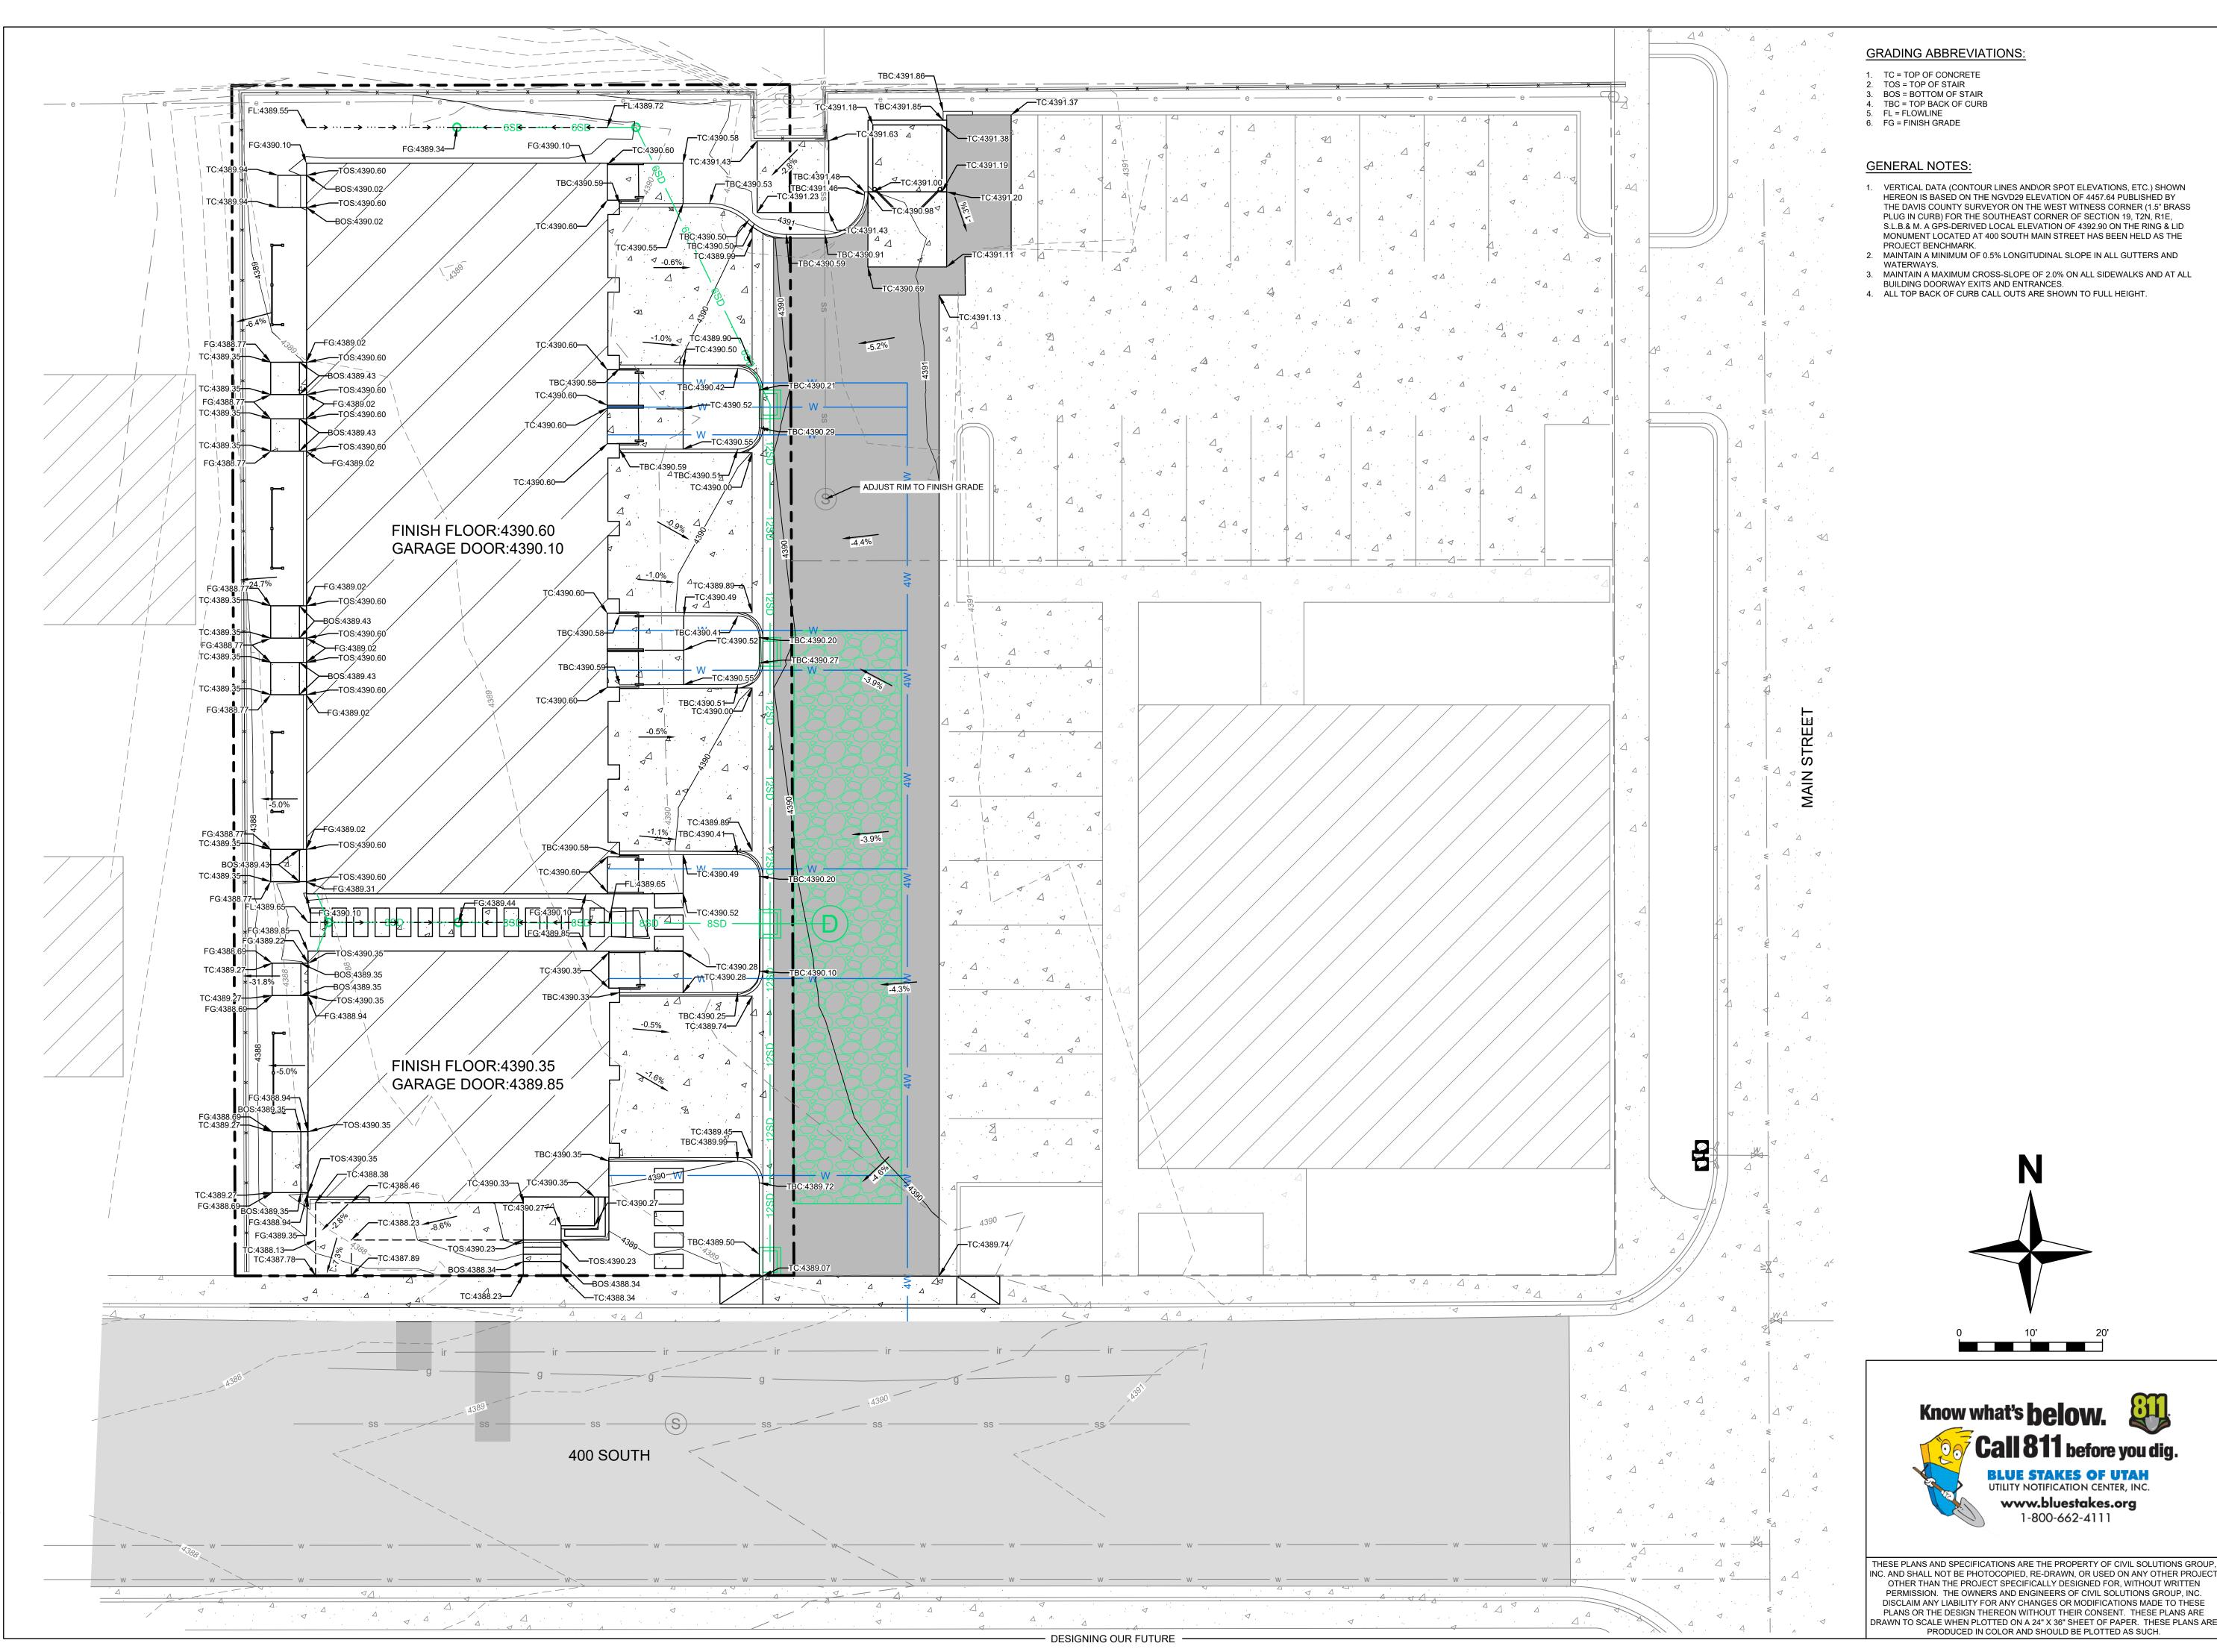
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Know what's **below.** 

December 6, 2022 Bountiful City Planning Commission




#### **GRADING ABBREVIATIONS:**

- TC = TOP OF CONCRETE
  TOS = TOP OF STAIR
  - BOS = BOTTOM OF STAIR
  - TBC = TOP BACK OF CURB 5. FL = FLOWLINE
  - 6. FG = FINISH GRADE

#### **GENERAL NOTES:**

- 1. VERTICAL DATA (CONTOUR LINES AND\OR SPOT ELEVATIONS, ETC.) SHOWN HEREON IS BASED ON THE NGVD29 ELEVATION OF 4457.64 PUBLISHED BY THE DAVIS COUNTY SURVEYOR ON THE WEST WITNESS CORNER (1.5" BRASS PLUG IN CURB) FOR THE SOUTHEAST CORNER OF SECTION 19, T2N, R1E, S.L.B.& M. A GPS-DERIVED LOCAL ELEVATION OF 4392.90 ON THE RING & LID MONUMENT LOCATED AT 400 SOUTH MAIN STREET HAS BEEN HELD AS THE
- PROJECT BENCHMARK. 2. MAINTAIN A MINIMUM OF 0.5% LONGITUDINAL SLOPE IN ALL GUTTERS AND
- WATERWAYS.
- 3. MAINTAIN A MAXIMUM CROSS-SLOPE OF 2.0% ON ALL SIDEWALKS AND AT ALL
- BUILDING DOORWAY EXITS AND ENTRANCES. 4. ALL TOP BACK OF CURB CALL OUTS ARE SHOWN TO FULL HEIGHT.

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PROJECT #: 22-009 A. OCHSENBEIN DRAWN BY: PROJECT MANAGER: W. SOUTHWICK

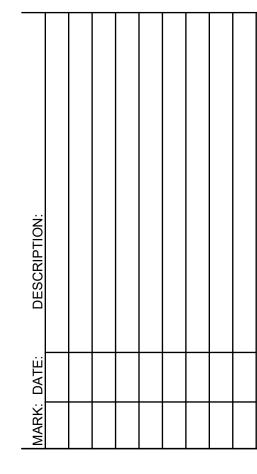ISSUED:



GRADING PLAN

C201

IC. AND SHALL NOT BE PHOTOCOPIED, RE-DRAWN, OR USED ON ANY OTHER PROJECT PLANS OR THE DESIGN THEREON WITHOUT THEIR CONSENT. THESE PLANS ARE DRAWN TO SCALE WHEN PLOTTED ON A 24" X 36" SHEET OF PAPER. THESE PLANS ARE PRODUCED IN COLOR AND SHOULD BE PLOTTED AS SUCH.


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1 UTILITY SHEET KEY NOTES

PROVIDE, INSTALL, AND/OR CONSTRUCT THE FOLLOWING PER THE SPECIFICATIONS GIVEN OR REFERENCED, THE DETAILS NOTED, AND/OR AS SHOWN ON THE CONSTRUCTION DRAWINGS:

1. 2' X 3' CATCH BASIN (1/C503) 2. 5'Ø STORM DRAIN MANHOLE (3/C503)

S. STORM DRAIN LINE (1/C502)

4. STORM DRAIN SUMP (4/C503) 5. 1"Ø WATER SERVICE WITH 1" WATER METER(4/C502)

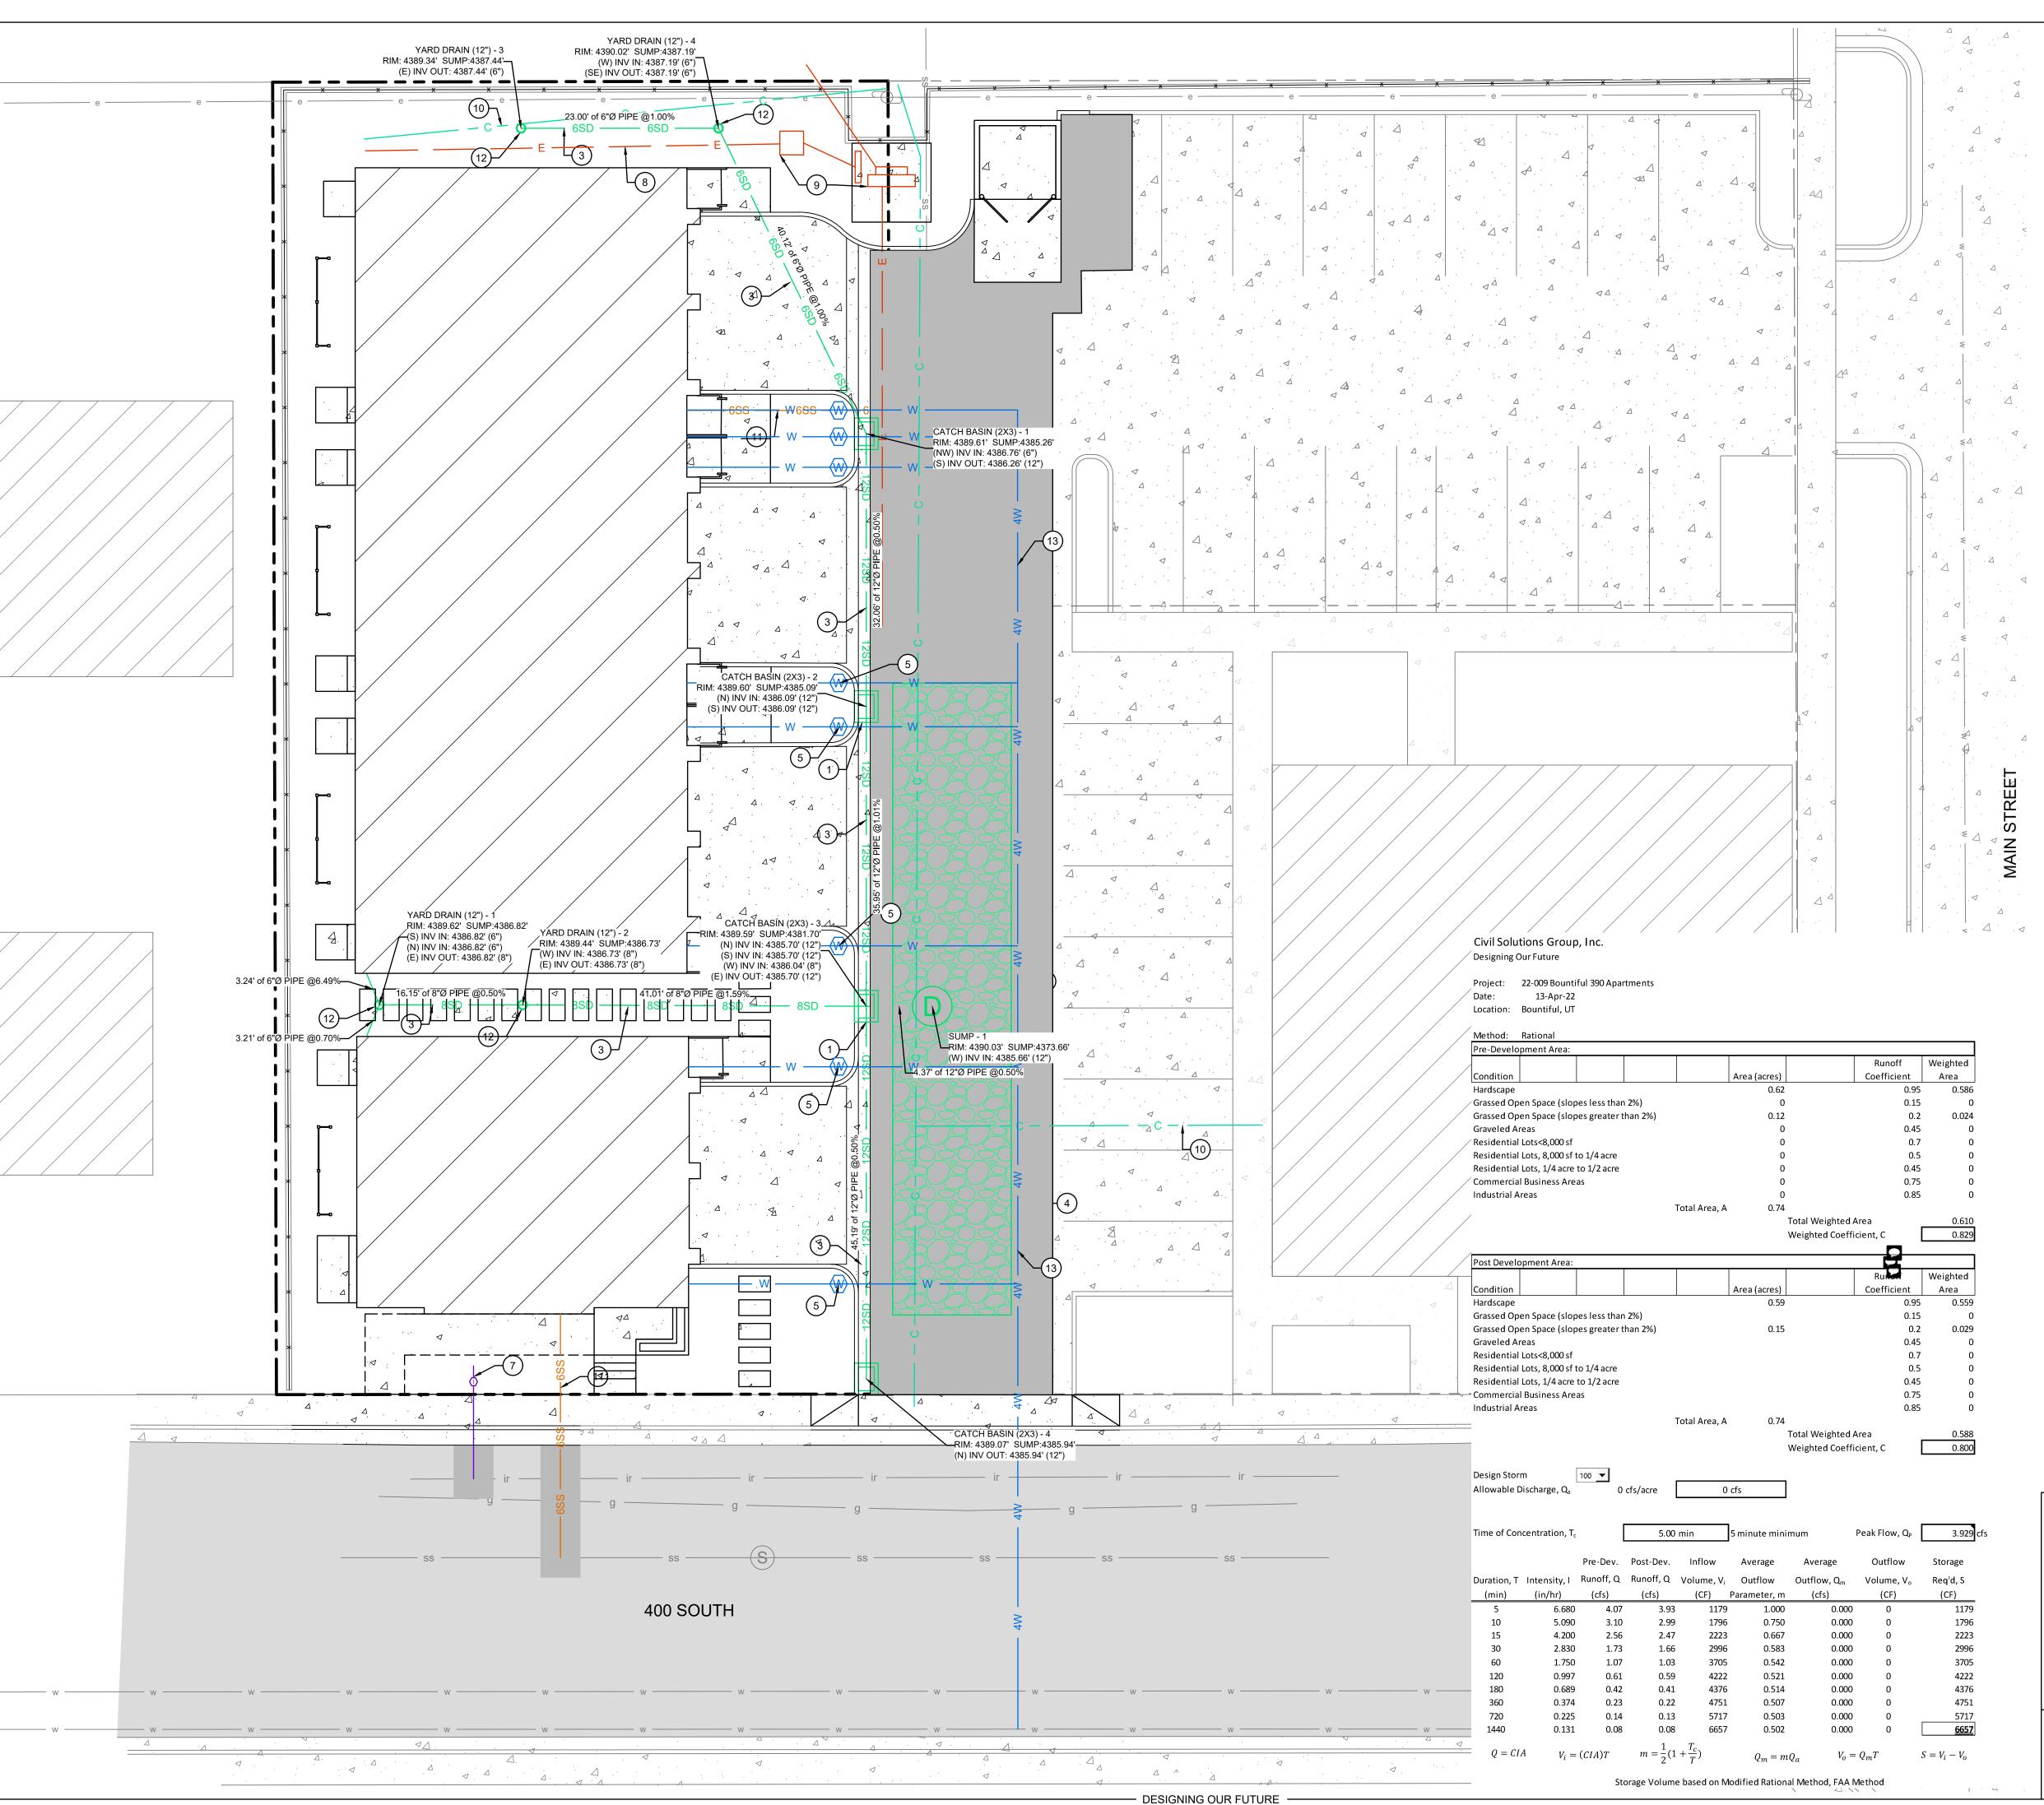. FIRE HYDRANT (2/C502) '. IRRIGATION SERVICE (3/C502) 8. UNDERGROUND POWER LINE. SEE ELECTRICAL PLANS FOR MORE

9. POWER EQUIPMENT. SEE ELECTRICAL PLANS FOR MORE INFORMATION. 10. COMMUNICATION LINE SEE ELECTRICAL PLANS FOR MORE INFORMATION.

11. 6"Ø SEWER LATERAL (7/C501) 12. 12"Ø NYLOPLAST YARD DRAIN OR APPROVED EQUAL (2/C503) 13. 4" Ø WATER LINE (4/C502)

#### **GENERAL NOTES:**

1. CONTRACTOR TO FIELD VERIFY ALL EXISTING UTILITY LOCATIONS AND CONTACT ENGINEER IF DIFFERENT FROM LOCATIONS DISPLAYED ON THESE

2. MINIMUM 18" OF VERTICAL SEPARATION REQUIRED BETWEEN WATER MAIN

AND SEWER MAIN WHERE LINES INTERSECT. MINIMUM OF 10' FROM OUTSIDE-OF-PIPE TO OUTSIDE-OF-PIPE REQUIRED BETWEEN CULINARY WATER LINE AND ALL OTHER WET UTILITIES. 4. ALL SEWER LINES SHALL BE CONSTRUCTED OF PVC SDR-35

5. ALL STORM DRAIN LINES SHALL BE CORRUGATED HDPE.

ALL IRRIGATION MAIN PIPE SHALL BE "PURPLE PIPE" FOR USE WITH RECLAIMED WATER SYSTEMS AS IS REQUIRED BY STATE REGULATIONS. CONTRACTOR SHALL PLACE CONCRETE THRUST BLOCKS ON ALL TEES, WYES, BENDS, ANGLES, ETC ON ALL WATER AND IRRIGATION LINES AS SHOWN IN DETAIL 6 ON SHEET C502.

8. POWER - CONTRACTOR SHALL COORDINATE WITH OWNER AND BOUNTIFUL LIGHT & POWER TO DETERMINE PRECISE LOCATION AND LAYOUT OF POWER LINES THROUGH DEVELOPMENT. CONTRACTOR SHALL BE RESPONSIBLE TO TRENCH, BED, INSTALL AND FILL IN THE POWER TRENCH AND PROVIDE THE REQUIRED PVC SCHEDULE 40 CONDUIT. 9. TELEPHONE AND CABLE - CONTRACTOR SHALL COORDINATE WITH UTILITY

COMPANIES FOR LOCATION OF CONDUIT CROSSINGS AND SHALL INSTALL

ALL CONDUITS. 10. GAS - CONTRACTOR SHALL COORDINATE INSTALLATION OF GAS WITH

QUESTAR GAS.

#### STORMWATER NOTES:

1. THE RATIONAL METHOD WAS USED TO CALCULATE THE REQUIRED STORAGE VOLUME FOR THE SITE. THE 100-YEAR, 24-HOUR STORM WAS USED FOR THE CALCULATIONS.

2. TOTAL REQUIRED VOLUME IS 6,657 CF. TOTAL VOLUME PROVIDED IS 6,720 CF.

4. STORAGE VOLUME FOR THE SITE IS PROVIDED IN THE PROPOSED SUMP. THE STORAGE VOLUME INCLUDES STORMWATER FROM ALL THREE PARCELS. △ 5. SUMP INFORMATION:


HIGH WATER ELEVATION: 4384.67 BOTTOM OF MANHOLE: 4374.67 BOTTOM OF GRAVEL: 4372.67 WIDTH: 15' LENGTH: 80'

HEIGHT: 14' 6. THERE IS NO INCREASE IN IMPERVIOUS SURFACE AREA FROM

PRE-REDEVELOPMENT OF THE SITE. AN INFILTRATION TEST WAS COMPLETED BY A LICENSED GEOTECHNICAL ENGINEER. THE MEASURED INFILTRATION RATE WAS 1 min/inch.


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A. OCHSENBEIN DRAWN BY

PROJECT MANAGER: W. SOUTHWICK ISSUED: 11/17/2022

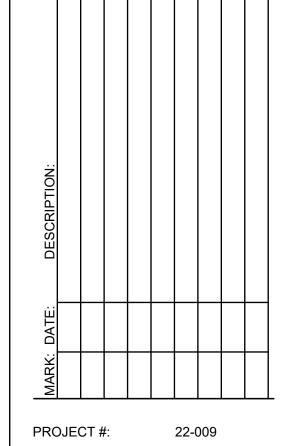

STORM DRAIN & UTILITY **PLAN** C301

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Know what's **below.** 

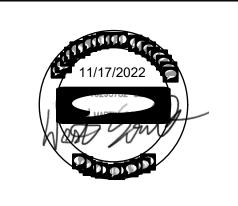December 6, 2022 Bountiful City Planning Commission

SECTION A-A

## NOTES:

NOTES:

1. SEE DRIVE APPROACH DETAILS FOR SIDEWALK THICKNESS THROUGH DRIVE APPROACHES.


2. EXPANSION JOINT SPACING: 100 FT OR AT DRIVE APPROACHES IF LESS THAN 100 FT.

3. JOINT SPACING: WIDTH (MIN), 1.5xWIDTH (MAX). MATCH CURB JOINT SPACING.

4. APWA MATERIAL SPECIFICATIONS APPLY.

5. TREAT FIELD CUT ENDS OF EPOXY COATED REINFORCING PRIOR TO PLACING CONCRETE FOR SIDEWALK.

**SIDEWALK** NOT TO SCALE

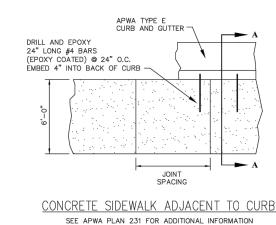

C501



SOLUTIONS GROUP.

PAVEMENT SECTION SHALL CONFORM TO THE SITE
 GEOTECHNICAL STUDY PERFORMED BY CIVIL

INSTALL 6" PORTLAND -

CEMENT CONCRETE

INSTALL 6" UNTREATED BASE COURSE.

COMPACT TO 95% MODIFIED PROCTOR







3" ASPHALT CONCRETE

PER GEOTECH REPORT

6" UNTREATED BASE COURSE ,


FILL PER GEOTECH REPORT

PROPERLY PREPARED NATURAL STABILIZED


SUBGRADE OR STRUCTURAL SITE GRADING


SURFACE COURSE




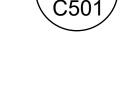





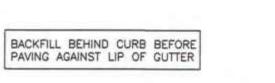

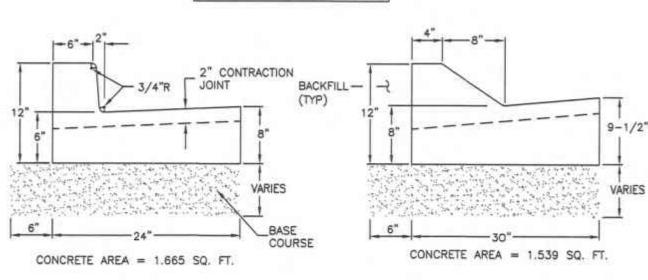

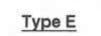

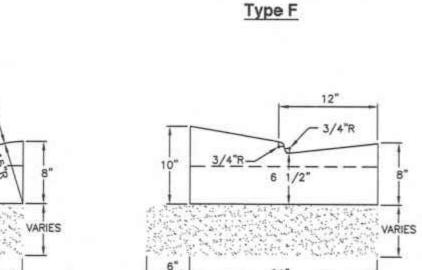

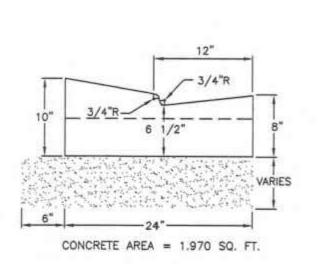


Type G Type H CONTRACTION EXISTING CONCRETE 12' MAX (NOT IN CONTRACT)




(SEE PLAN 206)


DOWELLED COLD JOINT



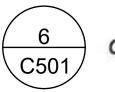

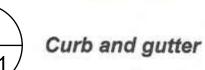




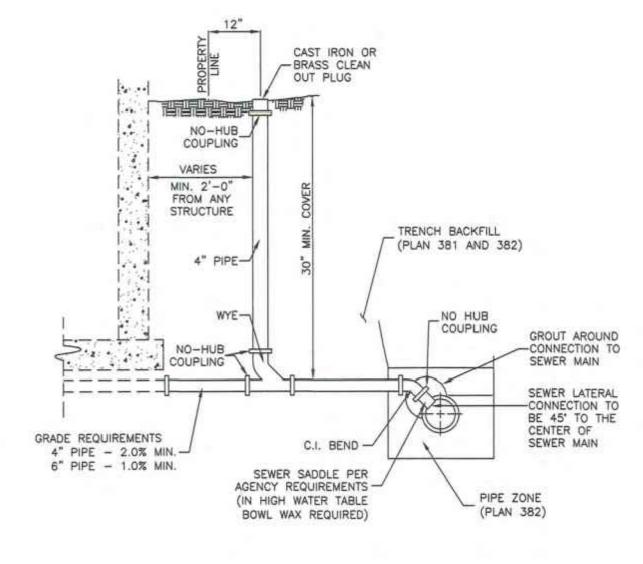









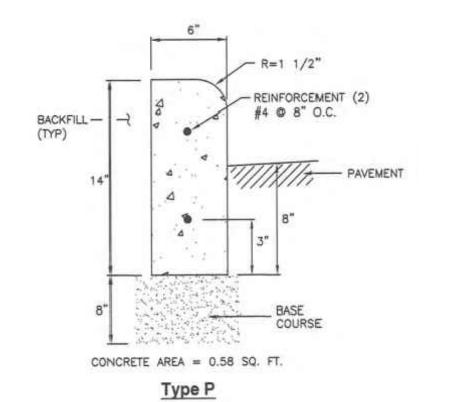

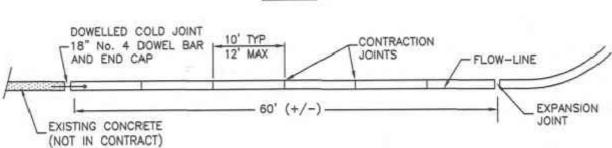

## JOINT SPACING DETAIL

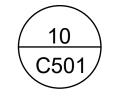

APWA TYPE P CURB NOT TO SCALE



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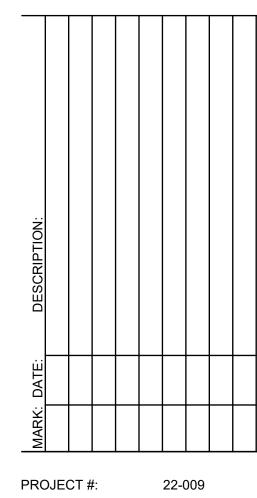
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**4** 



DRAWN BY: A. OCHSENBEIN PROJECT MANAGER: W. SOUTHWICK ISSUED: 11/17/2022


**DETAILS** 


C501

REINFORCEMENT #4 @ 24" O.C. BASE COURSE

3' CONCRETE WATERWAY

NOT TO SCALE

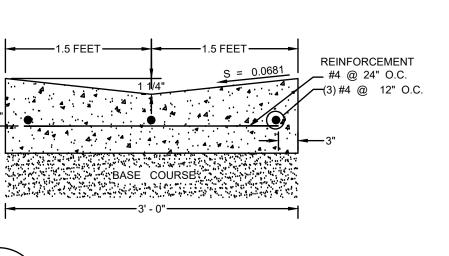

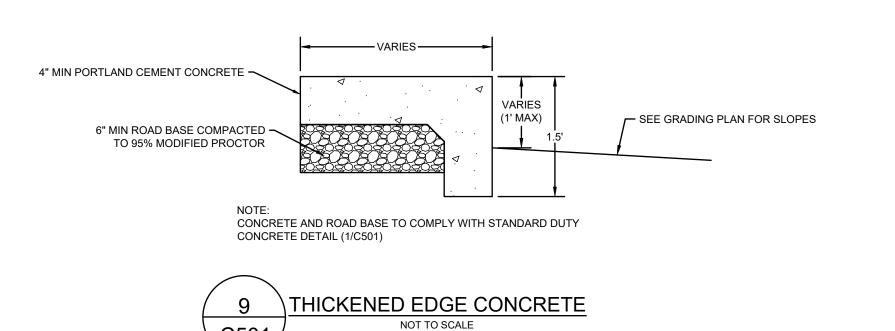

- DESIGNING OUR FUTURE -

December 6, 2022 Bountiful City Planning Commission

INSTALL 4" PORTLAND -

CEMENT CONCRETE

C501

TYPE B DRIVE APPROACH

TO BE USED WHEN WALK IS AGAINST CURB

W/4' WALK -- 7'-0" --W/8' WALK OR 11' WALK

BOUNTIFUL STANDARD

**PLAN VIEW** 

SECTION A-A

NOTES

INSTALL 6" UNTREATED BASE COURSE.

COMPACT TO 95% MODIFIED PROCTOR

4

1. PAVEMENT SECTION SHALL CONFORM TO THE SITE

GEOTECHNICAL STUDY PERFORMED BY CIVIL

6" THICK CONCRETE MINIMUM THROUGHOUT DRIVEWAY TO EXPANSION JOINTS.

LENGTH TO BE MEASURED FOR DRIVE APPROACH PAYMENT

WHICH INCLUDES WALK AND CURB AND GUTTER.

—12' MINIMUM / 30' MAXIMUM—

A **←** 

1. CONCRETE: CLASS 4000 PER APWA SECTION 03304. PLACE PER APWA SECTION 02770. CURE PER APWA SECTION 03390
2. COMPACT EXISTING SUBGRADE 95% MINIMUM (MODIFIED PROCTOR).
3. CURING BY APPLICATION OF CURING COMPOUND PER CURRENT APWA SPECIFICATIONS.
4. WHERE CONCRETE, OR ASPHALT IS TO BE REMOVED, THE MATERIAL MUST BE SAWCUT TO FULL DEPTH WITH STRAIGHT LINES. MINIMUM WIDTH OF ASPHALT REMOVAL IN FRONT OF A DRIVE APPROACH IS 3 FT- 0 INCHES.
5. 6" ROAD BASE MINIMUM UNDER ALL NEW CONCRETE.
6. EPOLY COATED PERAP BEQUIPED.

6. EPOXY COATED REBAR REQUIRED.
7. STRAIGHT METAL FORMS REQUIRED FOR ALL TANGENT SECTIONS OR WHERE THE CURB RADIUS IS NOT LESS THAN 150 FT.

C501

C501

← CONTROL JOINT REQUIRED WHEN DRIVEWAY WIDTH

EXCEEDS 14'

2 #4 BARS CONTINUOUS

DRIVE APPROACH NOT TO SCALE

SAW CUT 36" BACK AS REQUIRED

- 1/2" EXPANSION JOINT MATERIAL

STANDARD DUTY CONCRETE

NOT TO SCALE

SOLUTIONS GROUP.


PROJECT #: 22-009 A. OCHSENBEIN DRAWN BY: PROJECT MANAGER: W. SOUTHWICK

ISSUED: 11/17/2022



**DETAILS** 

C502

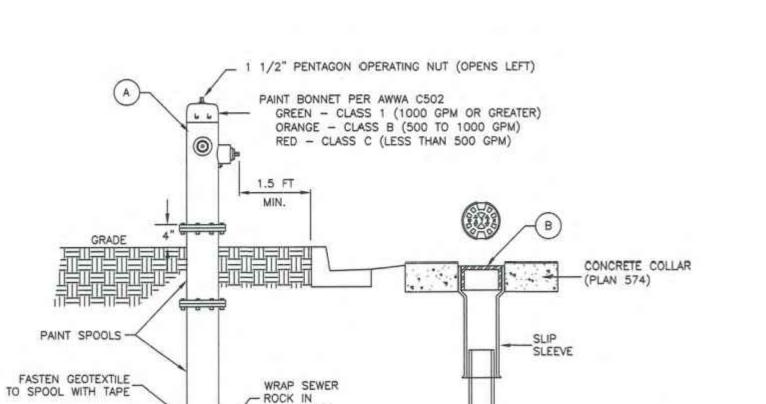


GREASE AND WRAP	SPOOL SPOOL
THRUST BLOCK (PLAN 561)	WHEN SPOOL LENGTH IS GREATER THAN 16 FEET, VERIFY WITH AGENCY IF AN ADDITIONAL VALVE IS REQUIRED AT THE HYDRANT
	EGEND

GEOTEXTILE

		LEGEND	
No.	٠	ITEM	DESCRIPTION
(A)		FIRE HYDRANT	AWWA C502
B		VALVE BOX WITH LID	2-PIECE CAST IRON
0		GATE VALVE WITH 2" X 2" NUT	AWWA C509
0		TEE WITH 125 # FLANGE	AWWA C110



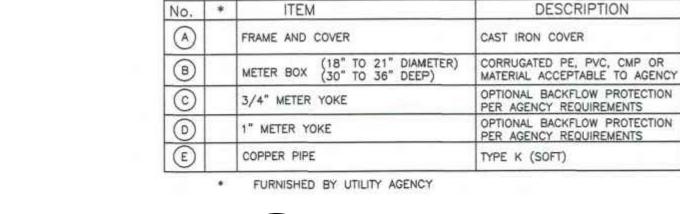


METER BOX (B)-

CROSS-BAR REQUIRED -

(NOTE 3C)




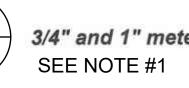








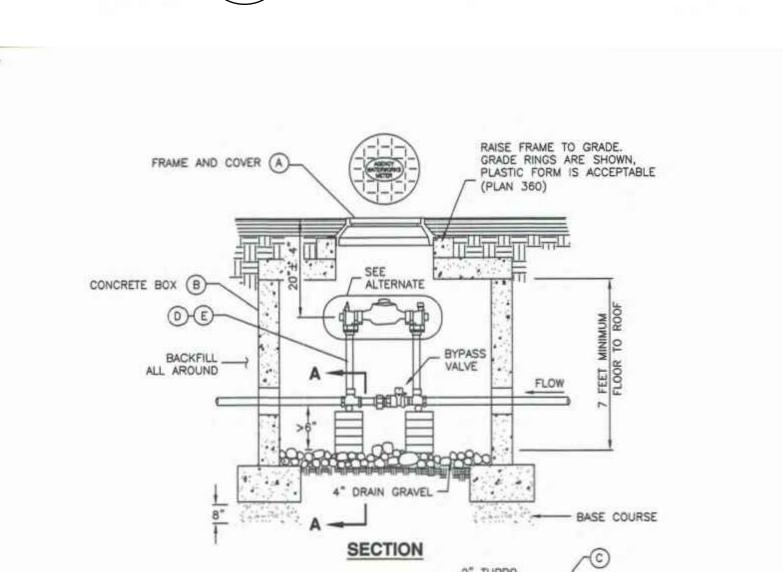

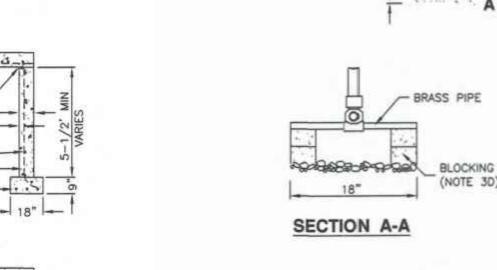

	LEGEND				
No.	*	ITEM	DESCRIPTION		
(A)	H	27" FRAME AND COVER	PLAN 502		
(B)		CONCRETE BOX	PLAN 505		
0		STAINLESS STEEL METER BOLTS	5/8" x 2 3/4" BRASS		
0		1 1/2" CUSTOM SETTER WITH BYPASS			
(E)		2" CUSTOM SETTER WITH BYPASS			

STRAINER -

ALTERNATE TURBO METER

INSTALLATION (NOTE 1A)

- DESIGNING OUR FUTURE —

C502

1 1/2" and 2" meter SEE NOTE #1

(NOTE 3D)

522 August 2001

C502 SEE NOTE #1


20" 27 52 28.5 14.5 9 24" 53 74 41 21 12

30" 81 114 62 32 16

Direct bearing thrust block

Plan 561 August 2010 Know what's **below.** www.bluestakes.org 1-800-662-4111

PERMISSION. THE OWNERS AND ENGINEERS OF CIVIL SOLUTIONS GROUP, INC.

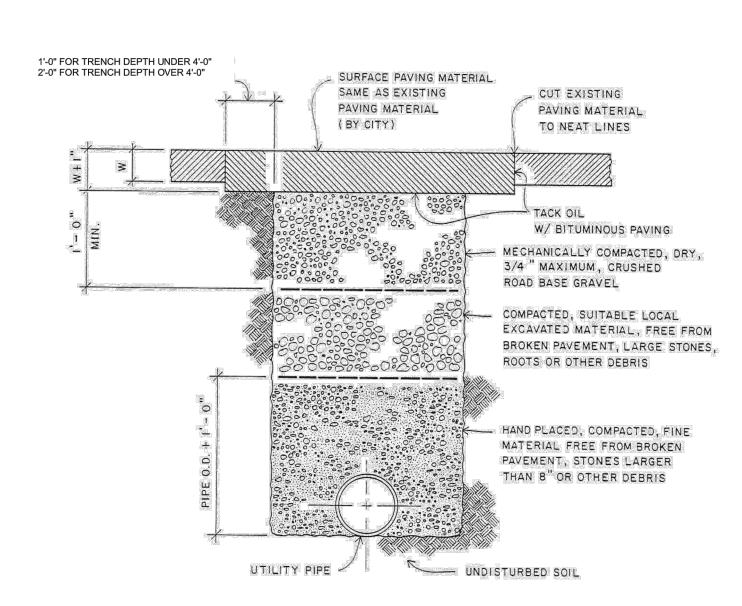

NOTES:

T. MATERIAL MUST BE REPLACED AND COMPACTED TO 95 % MODIFIED PROCTOR DENSITY.

EXCESS MATERIAL.

CONTRACTOR TO IMMEDIATELY REMOVE

BOUNTIFUL STANDARD STREET EXCAVATION DETAIL




TRENCHING DETAIL



DRAIN HOLES

(LOCATIONS VARY)

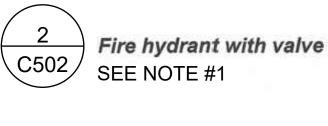

\* FURNISHED BY UTILITY AGENCY

THRUST BLOCK

(PLAN 561)

C502

3/4" and 1" meter

FLARED JOINTS

SECTION

LEGEND

-(A) FRAME AND COVER

CD YOKE


AROUND

BACKFILL ALL

DO NOT PLACE

IN METER BOX

ANY BACKFILL

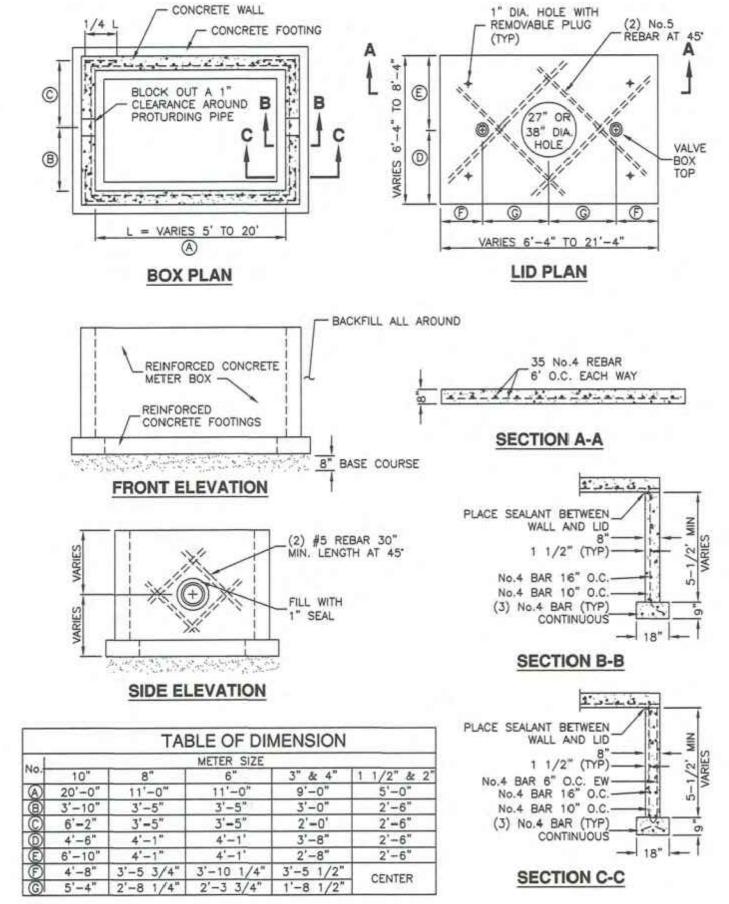

Concrete meter boxes


SEE NOTE #1

C502/

SECTION C-C

505


August 2001

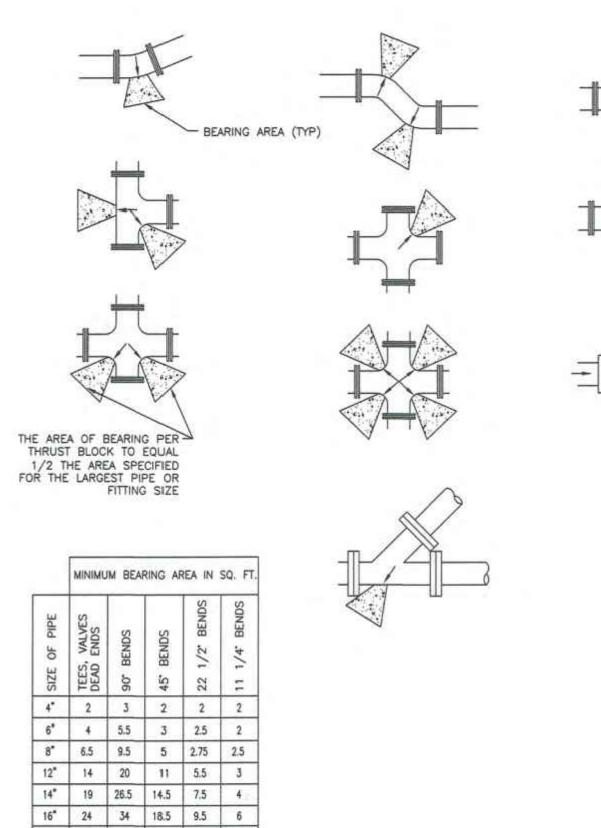

NOTES: 1. TO BE FURNISHED AND INSTALLED BY BOUNTIFUL CITY WATER DEPARTMENT. COORDINATE WITH BOUNTIFUL CITY WATER DEPARTMENT.



THESE PLANS AND SPECIFICATIONS ARE THE PROPERTY OF CIVIL SOLUTIONS GROUP, NC. AND SHALL NOT BE PHOTOCOPIED, RE-DRAWN, OR USED ON ANY OTHER PROJECT OTHER THAN THE PROJECT SPECIFICALLY DESIGNED FOR, WITHOUT WRITTEN DISCLAIM ANY LIABILITY FOR ANY CHANGES OR MODIFICATIONS MADE TO THESE PLANS OR THE DESIGN THEREON WITHOUT THEIR CONSENT. THESE PLANS ARE DRAWN TO SCALE WHEN PLOTTED ON A 24" X 36" SHEET OF PAPER. THESE PLANS ARE PRODUCED IN COLOR AND SHOULD BE PLOTTED AS SUCH.

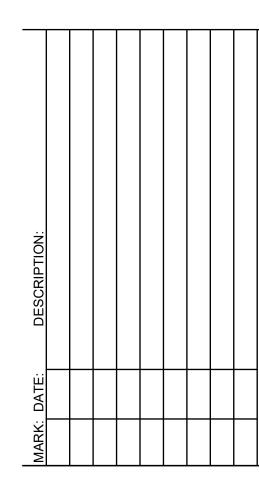

PROJECT #: 22-009 DRAWN BY: A. OCHSENBEIN


PROJECT MANAGER: W. SOUTHWICK 11/17/2022


ISSUED:


**DETAILS** 

C503




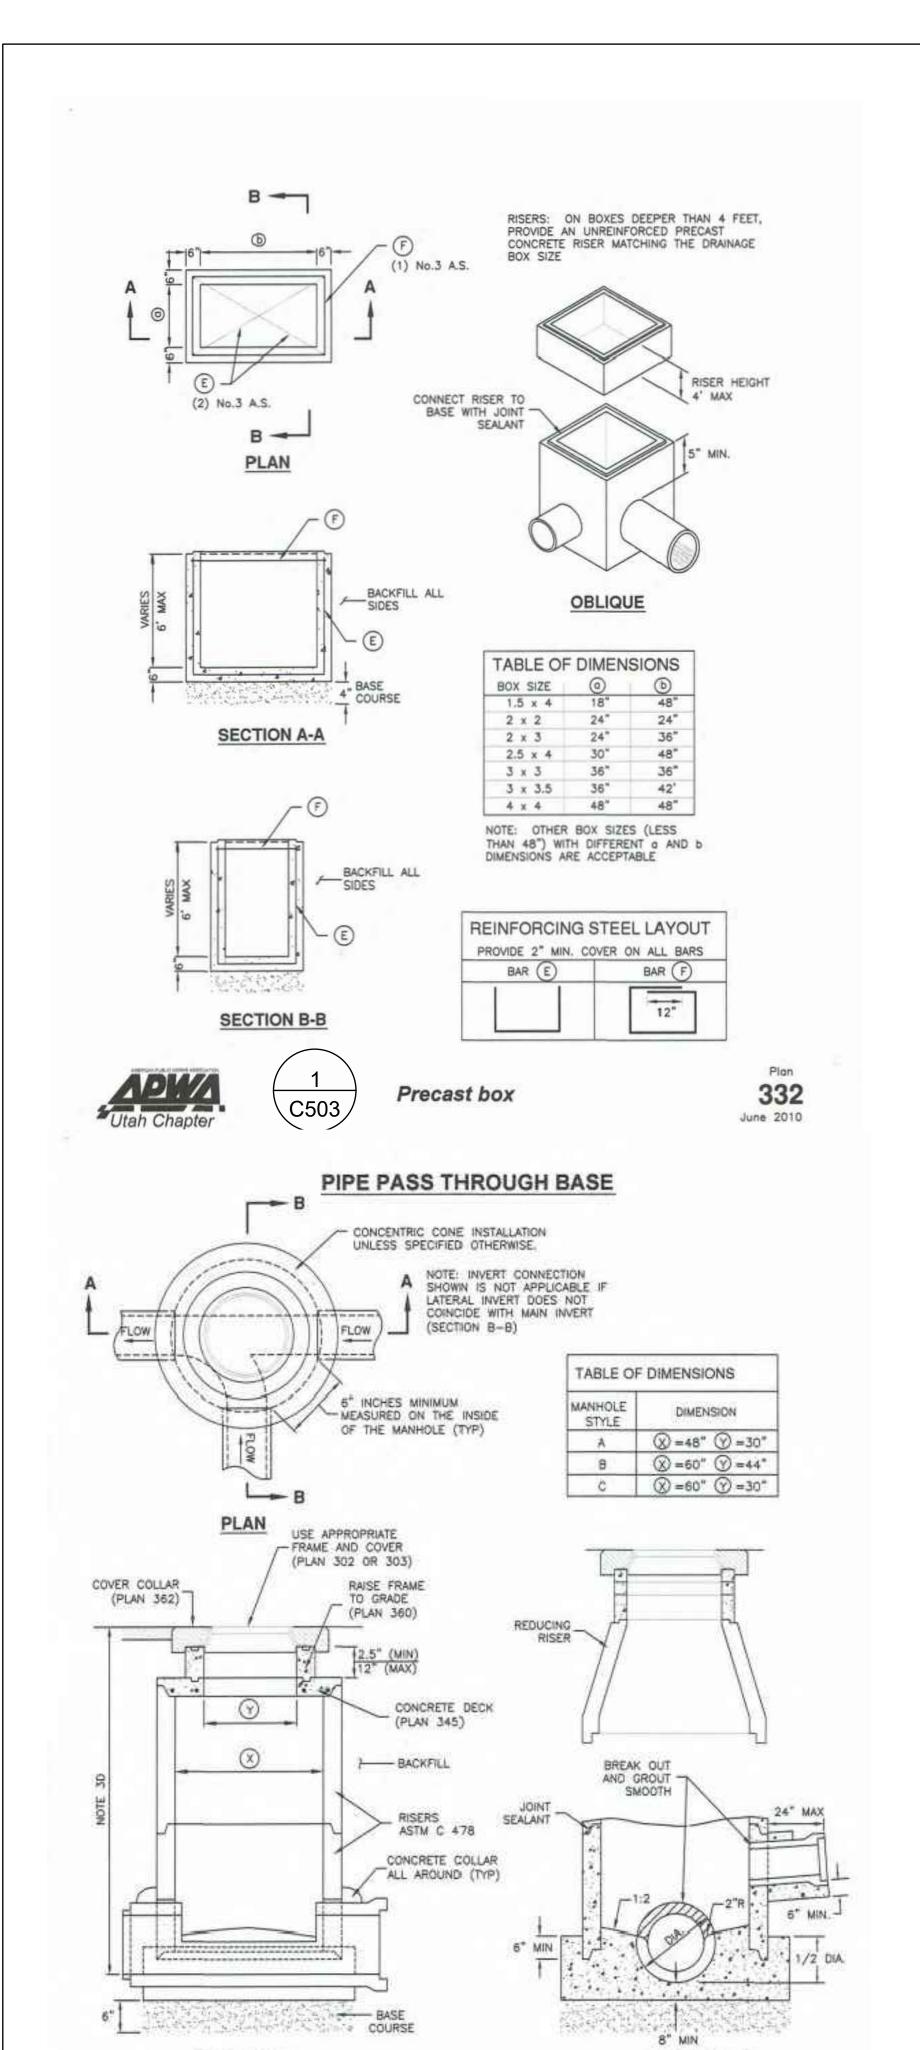

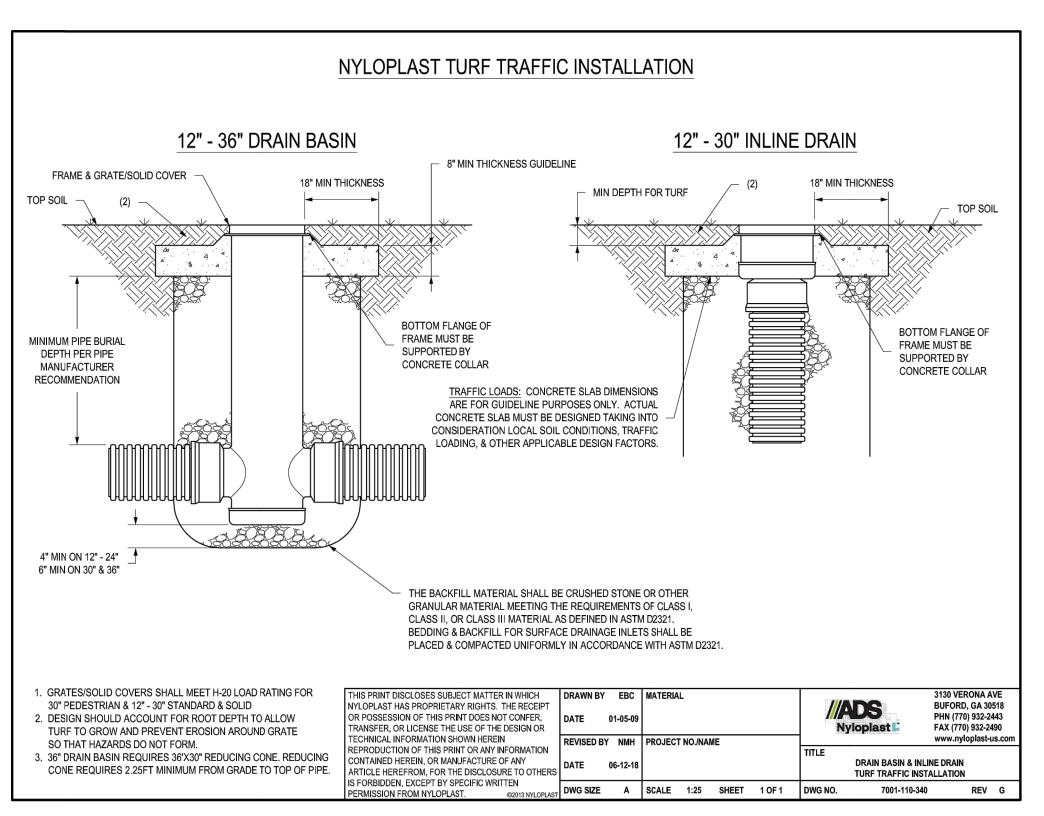

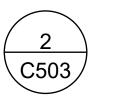

YARD DRAIN NOT TO SCALE

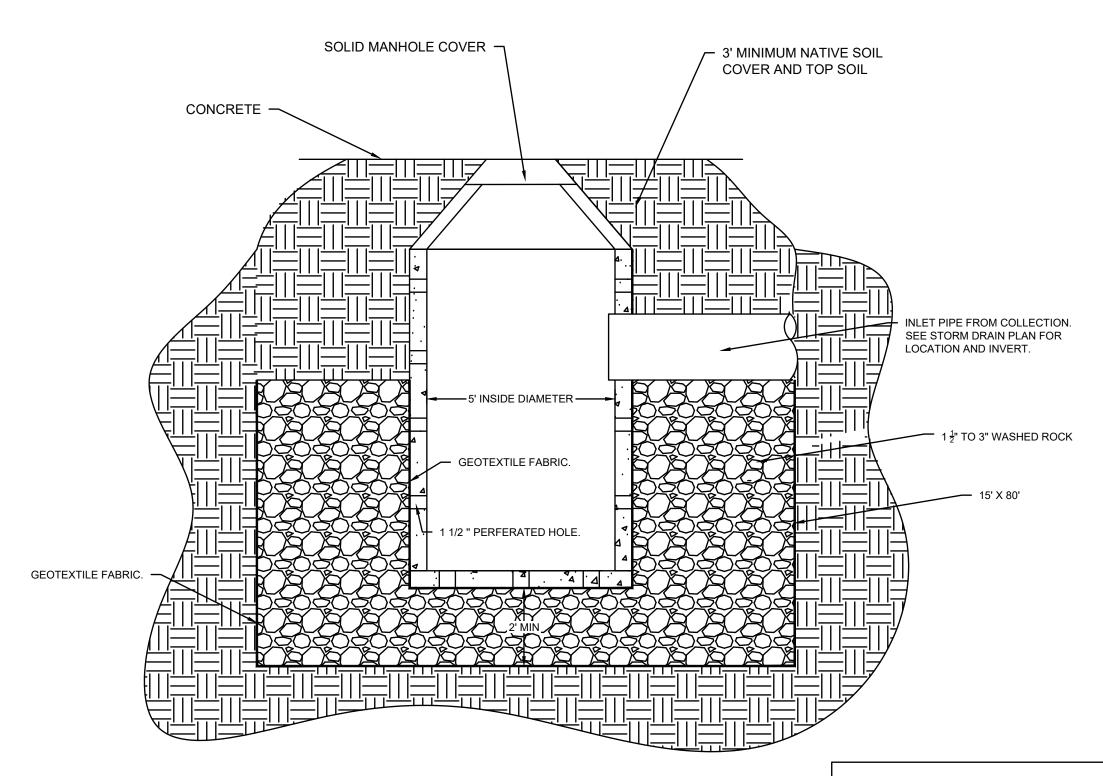



STORM DRAIN SUMP NOT TO SCALE



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DESIGNING OUR FUTURE —

December 6, 2022 Bountiful City Planning Commission

Precast manhole


SECTION A-A (CONCRETE DECK OPTION)

C503

SECTION B-B (REDUCING RISER OPTION)

341.2

November 2010

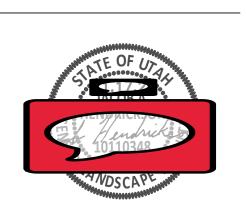

LANDSCAPE PLAN

DESIGNING OUR FUTURE

	TYP (7)			
5	10	LIMIT LINE 1  9		
PROPOSI BUILDING			9	MAIN STREET
PROPOS BUILDING	ED 1			
TYP 1 400 SO	UTH			

BOUNTIFUL CITY - DOWNTOWN ZONE			
* LANDSCAPE REQUIREMENTS			
PLANT TYPE	REQUIREMENT	NUMBER REQUIRED	NUMBER PLANNED
SITE TREES	1 screening tree / 750 SF required landscape area	2	5
SITE TREES	1 ornamental tree/750 SF required landscape area	2	6
SITE SHRUBS	1 shrub/200 SF landscape area	8	62
STREET TREES - 400 SOUTH	1 tree/35 ft	3	3
LANDSCAPE AREA	10% plus 50 SF per unit	1,294 + 50 SF X 8 UNITS = 1,695 SF	3167.2 SF

\*LANDSCAPE QUANTITIES ARE WITHIN PARCEL 030320055. REPAIRED LANDSCAPE AT ELECTRICAL TRANSFORMER AND DUMPSTER ENCLOSURE ARE NOT PART OF THESE NUMBERS.

PLANT SCHEDULE					
TREES	CODE	QTY	BOTANICAL / COMMON NAME	SIZE	CAL
	AC2	8	ACER PLATANOIDES `CRIMSON SENTRY` / CRIMSON SENTRY MAPLE	B&B	2"CAL
	MR	6	MALUS X 'ROYALTY' / ROYALTY CRABAPPLE	B&B	2"CAL
SHRUBS	CODE	QTY	BOTANICAL / COMMON NAME	CONT	<u>HEIGHT</u>
$\odot$	BG	29	BUXUS MICROPHYLLA 'WINTER GEM' / GLOBE WINTER GEM BOXWOOD	5 GAL.	
	СН	4	CORNUS ALBA `BAILHALO` TM / IVORY HALO DOGWOOD	5 GAL.	
	JA	14	JUNIPERUS COMMUNIS 'ALPINE CARPET' / JUNIPER	5 GAL.	
$\bigcirc$	RR	16	RHAMNUS FRANGULA `FINE LINE` / FINE LINE BUCKTHORN	5 GAL.	
$\odot$	RW	10	ROSA X `MEICOUBLAN` / WHITE MEIDILAND	5 GAL.	
PERENNIALS AND GRASSES	CODE	QTY	BOTANICAL / COMMON NAME	CONT	<u>HEIGHT</u>
	CK	12	CALAMAGROSTIS X ACUTIFLORA `KARL FOERSTER` / FEATHER REED GRASS	1 GAL.	
£ <del>;</del> }	DW	11	DIANTHUS GRATIANOPOLITANUS 'FIREWITCH' / FIREWITCH CHEDDAR PINK	1 GAL	
wy 3m	PH	20	PENNISETUM ALOPECUROIDES 'HAMELN' / HAMELN FOUNTAIN GRASS	1 GAL.	

## DEFEDENCE NOTES SCHEDULE

REFEREN	CE NOTES SCHEDULE		
SYMBOL	DESCRIPTION	QTY	DETAIL
1	CONCRETE MOWSTRIP: 6" WIDE- SEE DETAIL		5/L201
2	10' X 10' SIGHT TRIANGLE AT DRIVEWAY INTERSECTION		
3	METER FOR IRRIGATION SYSTEM. SEE CIVIL PLANS FOR EXACT SIZE AND LOCATION. IRRIGATION PLAN BY OTHERS.		
4	EXISTING LARGE SHRUBS AND OTHER VEGETATION TO BE REMOVED ALONG WEST SIDE OF PROPERTY.		
5	EXISTING FLOWERING PEAR TREE TO BE REMOVED.		
6	EXISTING 6` VINYL FENCE TO REMAIN.		
7	EXISTING 6' CHAIN LINK FENCE WITH SLATS TO REMAIN.		
8	PARCEL LINE		
9	OUT OF SCOPE FOR THIS PROJECT		
10	4" CONCRETE OVER 4" COMPACTED BASE COURSE		
11	FUTURE RAMP. SEE CIVIL PLANS		
SYMBOL	DESCRIPTION	QTY	DETAIL
Ψ Ψ Ψ Ψ	TURF GRASS: SOD (IMPERIAL BLUE FROM CHANSHARE SOD OR APPROVED EQUAL) INSTALLED OVER 5" TOPSOIL LAYER.	363 SF	5/L201
	BARK MULCH (SMALL BARK MULCH FROM MILLER COMPANIES LC OR APPROVED EQUAL) INSTALLED AT DEPTH OF 3" WITHOUT WEED BARRIER FABRIC. PLANTINGS WITHIN THIS AREA WILL INCLUDE TREES, SHRUBS, GRASSES AND PERENNIALS.	1,022 SF	5/L201
	ROCK MULCH, 1" (WASATCH TAN CRUSHED ROCK FROM STAKER PARSON OR APPROVED EQUAL) INSTALLED AT DEPTH OF 3" INSTALLED OVER DEWITT PRO 5 BARRIER FABRIC.	1,924 SF	5/L201


## **GENERAL NOTES:**

1. CONTRACTOR TO VERIFY ALL QUANTITIES. 2. SEE L201 FOR PLANTING NOTES AND DETAILS.

## **IRRIGATION NOTES:**

LANDSCAPE TO BE WATERED WITH AUTOMATIC IRRIGATION SYSTEM.
 IRRIGATION PLAN BY OTHERS. PROVIDE SLEEVES UNDER DRIVEWAYS TO

PLANTING ISLANDS AS NEEDED.

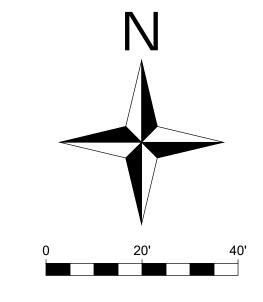

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#### GENERAL NOTES:

1. THE CONTRACTOR SHALL LOCATE AND VERIFY ALL EXISTING UTILITY LINES PRIOR TO ANY SITE WORK, IRRIGATION AND LANDSCAPE WORK; CONTRACTOR SHALL REPORT ANY CONFLICTS TO THE OWNERS REPRESENTATIVE.

- 2. THE CONTRACTOR(S) AND SUBCONTRACTORS ARE 100% RESPONSIBLE FOR ANY DAMAGE OCCURRED BY CONTRACTOR/SUBCONTRACTORS TO BUILDINGS, VEHICLES, TREES, SIDEWALKS, CURBS, DRIVES, UTILITIES AND ALL PROPERTY OF THE OWNER. IF ANY DAMAGE OCCURS TO THE OWNER'S BUILDINGS, SITE, LANDSCAPE, AND PROPERTY THE CONTRACTOR MUST REPORT IT IMMEDIATELY AND WORK OUT A SOLUTION WITH OWNER'S
- 3. TIME IS OF THE ESSENCE AND THE OWNER IS RELYING ON THE LANDSCAPING TO BE COMPLETED IN A PROFESSIONAL AND TIMELY MANNER.
- 4. CONTRACTOR IS TO REVIEW PLANS, VERIFY SITE CONDITIONS AND PLANT QUANTITIES PRIOR TO INSTALLATION. CONFLICTS BETWEEN THE SITE AND THESE PLANS OR WITHIN THESE PLANS SHALL BE BROUGHT TO THE ATTENTION OF THE OWNER'S AUTHORIZED REPRESENTATIVE PRIOR TO LANDSCAPE INSTALLATION. ANY DEVIATION FROM THE PLANS OR SPECIFICATIONS MUST HAVE WRITTEN APPROVAL FROM THE OWNER'S REPRESENTATIVE.

#### PLANTING NOTES

- 5. THE PLANTING PLAN IS DIAGRAMMATIC, AND PLANT LOCATIONS ARE APPROXIMATE. IF NECESSARY ADJUST PLANTING LOCATION TO ACCOMMODATE UTILITIES AND OTHER UN-FORESEEN OBSTACLES
- 6. PLANT SYMBOLS TAKE PRECEDENCE OVER PLANT QUANTITIES SPECIFIED ON PLANT SCHEDULE 7. THE CONTRACTOR SHALL VERIFY PLANT QUANTITIES AND NOTIFY THE LANDSCAPE ARCHITECT OF ANY DISCREPANCIES BETWEEN QUANTITIES AND SYMBOLS SHOWN.
- 8. ANY PROPOSED SUBSTITUTIONS OF PLANT SPECIES SHALL BE MADE WITH PLANTS OF EQUIVALENT OVERALL FORM, HEIGHT, BRANCHING HABIT, FLOWER, LEAF, COLOR, FRUIT, SOLAR NEEDS, WATER NEEDS, AND CULTURE ONLY AS APPROVED BY THE OWNER'S REP.
- 9. PRIOR TO PLANTING, THE IRRIGATION SYSTEM SHALL BE FULLY OPERATIONAL AND ALL PLANTING AREAS SHALL BE MOISTENED BEFORE PLANTINGS.
- 10. ALL GRASS SEED AREAS SHALL RECEIVE A MINIMUM OF SIX [6] INCHES OF IMPORTED TOPSOIL AND TEN (10) INCHES IN PLANTING BEDS. ALL TOPSOIL USED ON THIS PROJECT SHALL MEET THE FOLLOWING CRITERIA:
- 10.1. pH: 5.5 8.0 10.2. MINIMUM 1% PERCENT ORGANIC MATTER)
- 10.3. TEXTURE (PARTICLE SIZE PER USDA SOIL CLASSIFICATION): SAND: <70%, CLAY: <30% 10.4. SILT: = BALANCE
- 10.5. STONE FRAGMENTS (GRAVELS OR ANY SOIL PARTICLE GREATER THAN 2 MM IN SIZE): <5% (BY VOLUME)
- 11. IN ADDITION, THE SOIL SHALL BE FERTILE, FRIABLE, NATURAL LOAM AND SHALL BE CAPABLE OF SUSTAINING VIGOROUS PLANT GROWTH. IT SHALL BE FREE OF STONES, LUMPS, CLODS OF HARD EARTH, PLANTS OR THEIR ROOTS, STICKS AND OTHER EXTRANEOUS MATTER. THE SOIL SHALL CONTAIN NO NOXIOUS WEEDS NOR THEIR SEEDS. IT SHALL NOT BE USED FOR PLANTING OPERATIONS WHILE IN A FROZEN OR MUDDY CONDITION.
- 12. THE FOLLOWING PROCEDURES SHALL BE FOLLOWED IN PLACING ALL TOPSOIL
- 12.1. SUB-GRADE MATERIAL SHALL BE ROUGH GRADED TO PLUS OR MINUS 0.1 FEET OF A FINAL ROUGH GRADE WHICH WILL ALLOW THE CONTRACTOR TO ACHIEVE FINAL FINISH GRADE THROUGH THE INSTALLATION OF IMPORTED TOPSOIL
- 12.2. SCARIFY SURFACE OF SUB-GRADE TO A TWO (2) INCH DEPTH TO PROVIDE TRANSITION ZONE BETWEEN SUB-GRADE AND TOPSOIL. PLACE TOPSOIL ON SUB-GRADE AND FINE GRADE TO FINAL FINISH GRADE AND TOPSOIL DEPTHS AS INDICATED ON THE DRAWINGS AND IN THESE
- 12.3. FINISH GRADE TO BE 1" BELOW TOP OF CURB OR WALK FOR TURF AREAS, 2" FOR PLANTER
- 12.4. LANDSCAPE CONTRACTOR SHALL MAINTAIN A MINIMUM 3% DRAINAGE AWAY FROM ALL BUILDINGS, STRUCTURES, AND WALLS. FINISHED GRADES SHALL BE SMOOTHED TO ELIMINATE STANDING WATER, UNLESS SPECIFIED ON GRADING PLAN (SEE CIVIL SET).
- 12.5. ALL FINISHED GRADES SHALL BE APPROVED BY THE OWNER/OWNER'S AUTHORIZED REPRESENTATIVE PRIOR TO INSTALLATION OF ANY PLANT MATERIALS.
- 13. CONTRACTOR SHALL HAVE THE OWNER'S REP. APPROVE PLANT MATERIAL SIZE AND QUALITY PRIOR TO INSTALLATION. ANY PLANTS WHICH ARE NOT TRUE TO FORM, APPEAR STRESSED OR UNHEALTHY, INFESTED WITH PESTS, OR UNDERSIZED FOR THEIR CONTAINERS SHALL BE
- 14. PLANT MATERIAL SHALL NOT BE ROOT BOUND. THREE (3) GALLON PLANTS AND LARGER SHALL HAVE BEEN GROWN IN CONTAINERS FOR A MINIMUM OF SIX [6] MONTHS UP TO A MAXIMUM OF TWO (2) YEARS. PLANTS SHALL EXHIBIT HEALTHY GROWTH AND BE FREE OF DISEASES AND PESTS. BARE ROOT MAY BE USED WHEN APPROVED BY OWNER'S REP.
- 15. ALL TREES SHALL BE 2" CALIPER SIZE MEASURED 12" ABOVE THE GROUND.
- 16. PLANTS SHALL NOT BE PLACED WITHIN TWELVE [12] INCHES OF SPRINKLER HEADS. 17. PLANTING PROCEDURES FOR ALL PLANT MATERIALS, ESPECIALLY TREES, SHALL BE AS
- 17.1. DIG PLANTING HOLE THREE (3) TIMES THE WIDTH OF THE ROOT BALL, AND SAME DEPTH AS
- THE ROOT BALL DEPTH. SIDES OF HOLE SHOULD BE ROUGHENED AND NOT SMOOTH OR 17.2. FOR CONTAINER PLANTS, REMOVE CONTAINER AND PLACE ROOT BALL IN CENTER OF HOLE,
- WITH ROOT BALL RESTING ON UNDISTURBED SOIL. ROOT CROWN OR COLLAR SHALL BE AT OR JUST ABOVE FINISHED GRADE. 17.3. FOR BALLED AND BURLAP PLANTS, PLACE ROOT BALL IN CENTER OF HOLE AND RESTING ON
- UNDISTURBED GROUND. CUT AND REMOVE WIRE BASKET AND BURLAP OR OTHER WRAPPING MATERIAL FROM ROOT BALL THIS MAY BE DONE WITH ROOT BALL IN HOLE. BURLAP OR WIRE PIECES UNDERNEATH THE ROOT BALL MAY BE LEFT IF THEY CANNOT BE REMOVED. DO NOT FOLD BURLAP OVER, BUT CUT AWAY AS MUCH AS POSSIBLE WITHOUT DISTURBING ROOT BALL. BACKFILL BOTTOM THIRD (1/3) OF HOLE AS WIRE AND BURLAP
- 17.4. PLACE PLANT IN THE HOLE AND BACKFILL TO HALFWAY POINT AND PLACE AGRIFORM PLANTING TABLETS IN THE HOLE ABOUT 1-2 INCHES AWAY FROM THE ROOT TIPS. DO NOT PLACE TABLETS IN THE BOTTOM OF THE PLANTING HOLE. SEE DETAIL AND CHART FOR SUGGESTED APPLICATION RATES.
- 17.5. FINISH FILLING THE HOLE AROUND THE PLANT TO GRADE LEVEL
- 17.6. THOROUGHLY WATER PLANT, THEN COMPLETE BACKFILLING THE HOLE. FORM A WATERING
- BASIN AROUND THE PLANT AND THOROUGHLY WATER AGAIN. 18. MONITOR ALL PLANTS TO INSURE THAT NO SETTLING OCCURS.
- 19. THE LANDSCAPE CONTRACTOR SHALL LEAVE SITE IN A CLEAN CONDITION, REMOVING ALL
- UNUSED MATERIAL, TRASH AND TOOLS.
- 20. AT SUBSTANTIAL COMPLETION OF ALL WORK OUTLINED IN THESE PLANS, THE LANDSCAPE CONTRACTOR SHALL CONTACT OWNER AND ARRANGE FOR A WALK THROUGH. SUBSTANTIAL COMPLETION SHALL BE DEFINED AS COMPLETION OF ALL WORK OUTLINED IN THE PLANS AND SPECIFICATIONS WITH THE EXCEPTION OF FINAL CLEAN UP AND DEMOBILIZATION. WORK MUST BE FULLY COMPLETED ACCORDING TO ALL PLANS, NOTES, AND SPECIFICATIONS AND EXHIBIT PROFESSIONAL WORKMANSHIP. A MAINTENANCE PERIOD WILL BEGIN ON THE DATE OF ACCEPTANCE OF SUBSTANTIAL COMPLETION BY OWNER.
- 21. LANDSCAPE CONTRACTOR TO PROVIDE DETAILED AS BUILT DRAWINGS TO OWNERS REPRESENTATIVE UPON COMPLETION OF LANDSCAPE PLANTING. THE DRAWING TO SHOW LOCATION OF: BUILDING, HARDSCAPES, AND ALL PLANT MATERIAL (TREES, SHRUBS, GRASSES, PERENNIALS AND OTHERS). THE AS-BUILT DRAWINGS MUST USE THE BOTANIC NAMES OF SPECIES INSTALLED. THE CONTRACTOR MUST REVIEW THE AS-BUILT DRAWINGS WITH
- OWNERS REPRESENTATIVE PRIOR TO COMPLETION OF PROJECT. 22. LANDSCAPE CONTRACTOR SHALL MAINTAIN ALL PLANTINGS UNTIL PROJECT COMPLETION AS DETERMINED BY THE OWNER'S REP. TURF SHALL BE CONSIDERED FULLY ESTABLISHED WHEN GRASS STANDS COME IN UNIFORM AND THICK, WITH NO BARE OR THIN SPOTS, AND ROOTS HAVE BEGUN TO SPREAD AND KNIT TOGETHER. NO WEEDS SHALL BE ALLOWED IN THE GRASS. THE MAINTENANCE WORK REQUIRED SHALL INCLUDE BUT NOT BE LIMITED TO THE FOLLOWING:
- 22.1. DAILY WATERING OF ALL PLANT MATERIAL 22.2. WEEDING AND REMOVAL OF ALL WEEDS FROM GROUND COVER AND PLANTING AREAS. 22.3. REPLACEMENT OF ANY DEAD, DYING, OR DAMAGED TREES, SHRUBS OR GROUNDCOVER. 22.4. FILLING AND REPLANTING OF ANY LOW AREAS WHICH MAY CAUSE STANDING WATER. 22.5. ADJUSTING OF SPRINKLER HEAD HEIGHTS AND WATERING PATTERNS.
- 22.6. FILLING AND RE-COMPACTION OF ERODED AREAS. ALONG WITH ANY REQUIRED RE-SEEDING AND/OR RE-PLANTING. 22.7. GRASS SHALL BE MOWED WHEN BLADES REACH THREE (3) INCHES TALL. NO MORE THAN
- ONE THIRD (1/3) OF THE BLADE SHALL BE REMOVED PER CUTTING. CUTTING FREQUENCY SHALL BE ONCE EVERY FIVE (5) TO SEVEN (7) DAYS.
- 22.8. WEEKLY REMOVAL OF ALL TRASH, LITTER, CLIPPINGS AND ALL FOREIGN DEBRIS.

December 6, 2022 Bountiful City Planning Commission

- 23. CONTRACTOR TO FERTILIZE TREES, SHRUBS, PERENNIALS AND GRASSES WITH MILLERS A TO Z
- MIX ACCORDING TO MANUFACTURER'S RECOMMENDATIONS. 24. PLANT QUALITY AT OR BELOW THE SOIL LINE:

ROOTS ACROSS THE TOP OF THE STRUCTURAL ROOTS.

- 24.1. A MINIMUM OF THREE STRUCTURAL ROOTS REASONABLY DISTRIBUTED AROUND THE TRUNK SHALL BE FOUND IN EACH PLANT. PLANTS WITH STRUCTURAL ROOTS ON ONLY ONE
- SIDE OF THE TRUNK (J ROOTS) SHALL BE REJECTED. 24.2. THE ROOT CROWN MUST NOT BE MORE THAN TWO INCHES BELOW THE SOIL LINE. THE TOP TWO STRUCTURAL ROOTS SHALL BE NO MORE THAN TREE INCHES BELOW THE SOIL LINE WHEN MEASURED FOUR INCHES RADIAL TO THE TRUNK. THE TOP OF THE OTHER STRUCTURAL ROOT SHALL BE NO GREATER THAN FIVE INCHES BELOW THE SOIL LINE WHEN MEASURED FOUR INCHES RADIAL TO THE TRUNK. THE GROWER MAY REQUEST A MODIFICATION TO THIS REQUIREMENT FOR SPECIES WITH ROOTS THAT RAPIDLY DESCEND, PROVIDED THAT THE GROWER REMOVES ALL CIRCLING ROOTS ABOVE THE STRUCTURAL
- 24.3. THE ROOT SYSTEM SHALL BE REASONABLY FREE OF ROOT DEFECTS INCLUDING POTENTIALLY STEM-GIRDLING ROOTS ABOVE THE ROOT COLLAR AND MAIN STRUCTURAL ROOTS, VERTICAL ROOTS, AND/OR KINKED ROOTS FROM NURSERY PRODUCTION PRACTICES, INCLUDING
- ROOTS ON THE INTERIOR OF THE ROOT BALL 24.3.1.REASONABLE AND REASONABLY - WHEN USED IN THIS SPECIFICATION RELATIVE TO PLANT QUALITY - ARE INTENDED TO MEAN THAT THE CONDITIONS CITED WILL NOT AFFECT THE ESTABLISHMENT OR LONG-TERM STABILITY, HEALTH, OR GROWTH OF THE PLANT. THIS SPECIFICATION RECOGNIZES THAT IT IS NOT POSSIBLE TO PRODUCE PLANTS FREE OF ALL DEFECTS AND THAT SOME DECISIONS CANNOT BE TOTALLY BASED ON MEASURED FINDINGS, SO PROFESSIONAL JUDGEMENT IS REQUIRED. IN CASES OF DIFFERING OPINION. THE LANDSCAPE ARCHITECT SHALL DETERMINE WHEN CONDITIONS WITHIN THE PLANT ARE JUDGED AS REASONABLE.
- 24.3.2.THE FINAL PLANT GROWER SHALL BE RESPONSIBLE FOR CERTIFYING THAT THE PLANTS HAVE BEEN ROOT PRUNED AT EACH STEP IN THE PLANT PRODUCTION PROCESS TO REMOVE STEM-GIRDLING ROOTS AND KINKED ROOTS, OR SHALL ENSURE THAT THE PREVIOUS LINER PRODUCTION SYSTEM USED OTHER PRACTICES THAT PRODUCE A ROOT SYSTEM THROUGHOUT THE ROOT BALL THAT MEETS THESE SPECIFICATIONS. REGARDLESS OF THE WORK OF PREVIOUS GROWERS, THE PLANT'S ROOT SYSTEM SHALL BE MODIFIED AT THE FINAL PRODUCTIONS STAGE TO PRODUCE THE REQUIRED PLANT ROOT QUALITY. THE FINAL GROWER SHALL CERTIFY IN WRITING THAT ALL PLANTS ARE REASONABLY FREE OF ROOT DEFECTS AS DEFINED IN THIS SPECIFICATION AND THAT THE TREE HAS BEEN GROWN AND HARVESTED TO PRODUCE A PLANT THAT MEETS THESE SPECIFICATIONS.
- 24.4. ALL PLANTS MAY BE INSPECTED AT THE SUPPLIER'S NURSERY. THE LANDSCAPE ARCHITECT MAY MAKE INVASIVE INSPECTION OF THE ROOT BALL AS NEEDED TO VERIFY THAT PLANTS MEET THE REQUIREMENTS. INSPECTIONS OF CONTAINER TREES MAY REQUIRE RANDOM CUTTING INTO THE INTERIOR ROOT BALL OF UP TO 2 PERCENT BUT NOT FEWER THAN TWO TREES OF EACH TYPE OF TREE IN A CONTAINER AT EACH SOURCE NURSERY. SUCH CUTTING AND INSPECTION MAY RENDER THE CONTAINER TREE UNSUITABLE FOR PLANTING. FINDINGS OF THE ROOT INSPECTIONS SHALL BE CONSIDERED AS REPRESENTATIVE OF ALL TREES OF THAT TYPE FROM THAT SOURCE.
- 24.5. CONTAINER-GROWN PLANTS, IN ADDITION TO THE ABOVE REQUIREMENTS, SHOULD COMPLY WITH THE FOLLOWING:
- 24.5.1.1.CONTAINER-GROWN PLANTS MAY BE PERMITTED ONLY WHEN INDICATED ON THE DRAWING OR THIS SPECIFICATION.
- 24.5.2.CONTAINER-GROWN STOCK SHALL HAVE BEEN GROWN IN A CONTAINER LONG ENOUGH FOR THE ROOT SYSTEM TO HAVE DEVELOPED
- 24.6. SUFFICIENTLY TO HOLD ITS POTTING MEDIUM TOGETHER BUT NOT SO LONG AS TO HAVE DEVELOPED ROOTS THAT ARE MATTED OR CIRCLING AROUND THE EDGE OR INTERIOR OF THE ROOT MASS. PLANTS SHALL HAVE BEEN ROOT PRUNED AT EACH CHANGE IN CONTAINER
- 24.6.1.PLANTS THAT FAIL TO MEET ANY OF THE ABOVE REQUIREMENTS SHALL BE MODIFIED TO CORRECT DEFICIENCIES IF APPROVED BY THE LANDSCAPE ARCHITECT. MODIFICATION SHALL INCLUDE THE FOLLOWING:
- 24.6.1.1.SHAVING ALL CIRCLING ROOTS ON THE EXTERIOR OF THE ROOT MASS DEEP ENOUGH SO THAT ALL CUT ROOTS ENDS ARE ROUGHLY RADIAL TO THE TRUNK.
- 24.6.1.2.REMOVAL OF ALL ROOTS ABOVE THE TOP OF THE MAIN STRUCTURAL ROOTS AND TRUNK FLARE INCLUDE ANY ROOTS THAT ARE IMPRINTS FROM PREVIOUS SMALLER
  - (THE ABOVE MODIFICATIONS SHALL NOT BE CAUSE TO ALTER THE WARRANTY PROVISIONS OF THIS SPECIFICATION.)

- 31. LANDSCAPE CONTRACTOR TO PROVIDE BID TO STAKE UP TO 50% OF TREES.
- 32. THE OWNER/OWNERS REPRESENTATIVE SHALL HAVE THE AUTHORITY TO REQUIRE THAT TREES ARE STAKED OR TO REJECT STAKING AS AN ALTERNATIVE WAY TO STABILIZE THE TREE. 33. TREES THAT REQUIRE HEAVILY MODIFIED ROOT BALLS TO MEET THE ROOT QUALITY STANDARDS MAY BECOME UNSTABLE. THE OWNER/OWNERS REP MAY CHOOSE TO REJECT THESE TREES
- RATHER THAN UTILIZE STAKING TO TEMPORARILY SUPPORT THE TREE. 34. STAKES SHALL BE LODGE POLE STAKES FREE OF KNOTS AND OF DIAMETERS AND LENGTHS APPROPRIATE TO THE SIZE OF PLANT AS REQUIRED TO ADEQUATELY SUPPORT THE PLANT.
- 35. PLANTS SHALL STAND PLUMB AFTER STAKING REMOVE TREE STAKING AFTER THE FIRST FULL GROWING SEASON UNLESS DIRECTED BY THE
- OWNER/OWNERS REP.

## MULCH:

- 36. ALL PLANTER BEDS ARE TO RECEIVE ROCK MULCH AS SPECIFIED ON PLANS OR APPROVED
- EQUAL BY OWNER'S REP.
- 37. PRIOR TO PLACEMENT OF WEED FABRIC, TREAT AREAS WITH PRE-EMERGENT 38. HERBICIDE ACCORDING TO MANUFACTURERS RECOMMENDATIONS.

## WEED FABRIC:

39. AREAS TO RECEIVE WEED BARRIER FABRIC INCLUDE PLANTER BEDS WITH ROCK MULCH. CONTRACTOR TO INSTALL DEWITT PRO 5 WEED FABRIC. CONTRACTOR TO INSTALL WEED BARRIER PER MANUFACTURERS RECOMMENDATIONS INCLUDING THE USE OF STAPLES AS OFTEN AS RECOMMENDED.

## MAINTENANCE & WARRANTIES:

- 40. THE CONTRACTOR IS RESPONSIBLE FOR MAINTENANCE OF THE TREES, PLANTER BEDS (INCLUDING WEEDING), SHRUB PRUNING, WATERING THE PLANTS AND IRRIGATION SYSTEM
- FOR THE DURATION OF THE CONSTRUCTION PERIOD. 41. THE LANDSCAPE CONTRACTOR IS RESPONSIBLE FOR MAINTENANCE OF LANDSCAPE FOR 90 DAYS PAST THE FINAL INSPECTION. THE MAINTENANCE IS TO INCLUDE: WEEDING PLANTER BED AREAS, SPRAYING THE SOD AREAS FOR WEEDS AND FERTILIZATION (1 APPLICATION AFTER INITIAL APPLICATION), MOWING, TRIMMING, AND IRRIGATION REPAIRS.
- 42. ALL SHRUBS AND GROUND COVERS SHALL BE GUARANTEED BY THE CONTRACTOR AS TO GROWTH AND HEALTH FOR A PERIOD OF ONE (1) YEAR AFTER COMPLETION OF THE MAINTENANCE PERIOD AND FINAL ACCEPTANCE. ALL TREES SHALL BE GUARANTEED BY THE CONTRACTOR TO LIVE AND GROW IN AN ACCEPTABLE UPRIGHT POSITION FOR A PERIOD OF ONE (1) YEAR AFTER COMPLETION OF THE SPECIFIED MAINTENANCE PERIOD AND FINAL
- 43. THE ONLY CONDITIONS WHICH RELIEVE THE CONTRACTOR FROM THE GUARANTEE OF PLANT MATERIALS AS DESCRIBED ABOVE ARE THOSE WHICH CAN BE SHOWN ARE A DIRECT RESULT OF IMPROPER CARE OR WATERING BY THE OWNER AFTER THE MAINTENANCE PERIOD AND DURING THE GUARANTEE PERIOD.
- 44. THE CONTRACTOR, WITHIN FIFTEEN (15) DAYS AFTER RECEIVING WRITTEN NOTIFICATION BY THE OWNERS REP., SHALL REMOVE AND REPLACE ALL GUARANTEED PLANT MATERIALS WHICH FAIL TO MEET THE REQUIREMENTS OF THE GUARANTEE. REPLACEMENT SHALL BE MADE WITH PLANT MATERIALS AS INDICATED OR SPECIFIED ON THE ORIGINAL PLANS, AND ALL SUCH REPLACEMENT MATERIALS SHALL BE GUARANTEED AS SPECIFIED FOR THE ORIGINAL MATERIALS.

## AGRIFORM® 20-10-5 PLANTING TABLETS PLUS MINORS

		SUGGE:	STED APP	LICATION	RATES				
	Agrif	orm <b>e</b> 21-gi (*availak	m Tablets ole in Can	(SKU# E9 ada SKU#	002 <i>6</i> *, G9 E98355)	00 26)			
		Tree / Shrub Container Size							
	1 gal	2 gal	3 gal	S gal	7 gal	15 gal	24" box		
Installation	1	1 to 2	2 to 3	2 to 3	3 to 5	7 to 10	15 to 24		
	- 10	Main	tenance R (Plant	ates for Est . Height or	ablished P Spread)	lan tings			
	18" or less	18-36"	36-54"	4.5-6 ft.	6-7.5 ft.	7.S-9 ft.	Each additional 18"		
Slow Growing	1	1 to 2	2 to 3	3 to 4	4 to 5	5 to 6	add 1		
Fast Growing	2	2 to 4	4 to 6	6 to 8	8 to 10	10 to 12	add 1		
	Agrif Applica	orm <sup>®</sup> 10-g tion Rate fo	m Tablets r Well-Root	: (SKU# E9 ed Liners (Q	10805, G91 (want to gall	0805) on size)	28		
	. 100 100	1 to	2 tablets	for each pl	ant		j		
Ap				(SKU#E9) over/Perenn			er)		
		1	tablet for	each plan	t				

Always refer to label instructions before application:


#### BE 1-2" ABOVE FINISH GRADE — SOIL LINE OF THE TOP OF ROOT BAL **KEEP MULCH 4** AFTER REMOVING INCHES WAY FROM EXCESS SOIL SOIL SAUCER > 3 INCHES -TO 2 INCHES EXCAVATED HOLE TO HAVE SIDES SLOPED AT 45 ARTER ROOT BALL IS DEGREE ANGLES PLACED IN **PLANTING PIT** REMOVE ALL **BURLAP & WIRE** BASKET DOWN TO PLACE ROOT BALL THE BOTTOM OF THE ON UNDISTURBED

TYPICAL TREE B&B PLANTING DETAIL

ROOT FLARE SHALL

BID SPECIFICATIONS:

PLANTING TABLET SHALL BE TIGHTLY COMPRESSED, LONG LASTING AND SLOW RELEASE. WEIGHTS OF 5, 10, AND 21 GRAMS WITH A NITROGEN (N), PHOSPHORUS (P), AND POTASSIUM (K) ANALYSIS OF 20-10-5 AND TRACE ELEMENTS DERIVED FROM THE SOURCES

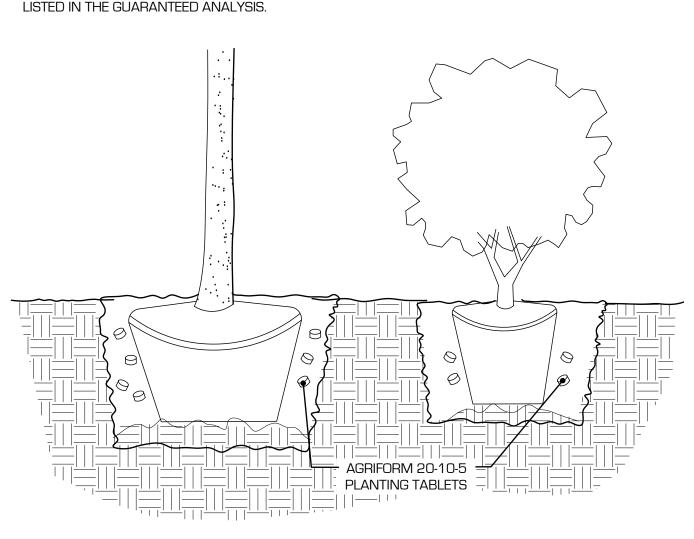

central leader needs to be stakes. straightened or held erect, it is acceptable to attach a 🙎 x 8' bamboo pole to the central leader and trunk. -- 32" long non - abrasıve rubber tıes. Two (2) three inch lodge pole pine stakes. Install approximately 2" away from the edge of the root ball. Stake location shall not interfere with permanent branches.

SECTION VIEW

AGRIFORM 20-10-5 PLANTING TABLETS


3293-01

TREE DOUBLE STAKING

329343-06

ABOVE SOIL LINE

329343-03

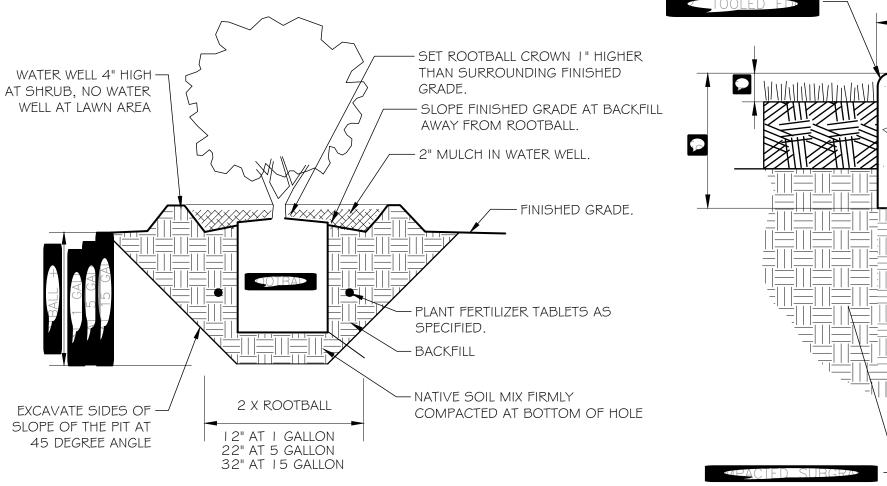

SHRUB PLANTING

329333.13-01

6"X6" CONCRETE MOW STRIP AT PLANTER EDGE


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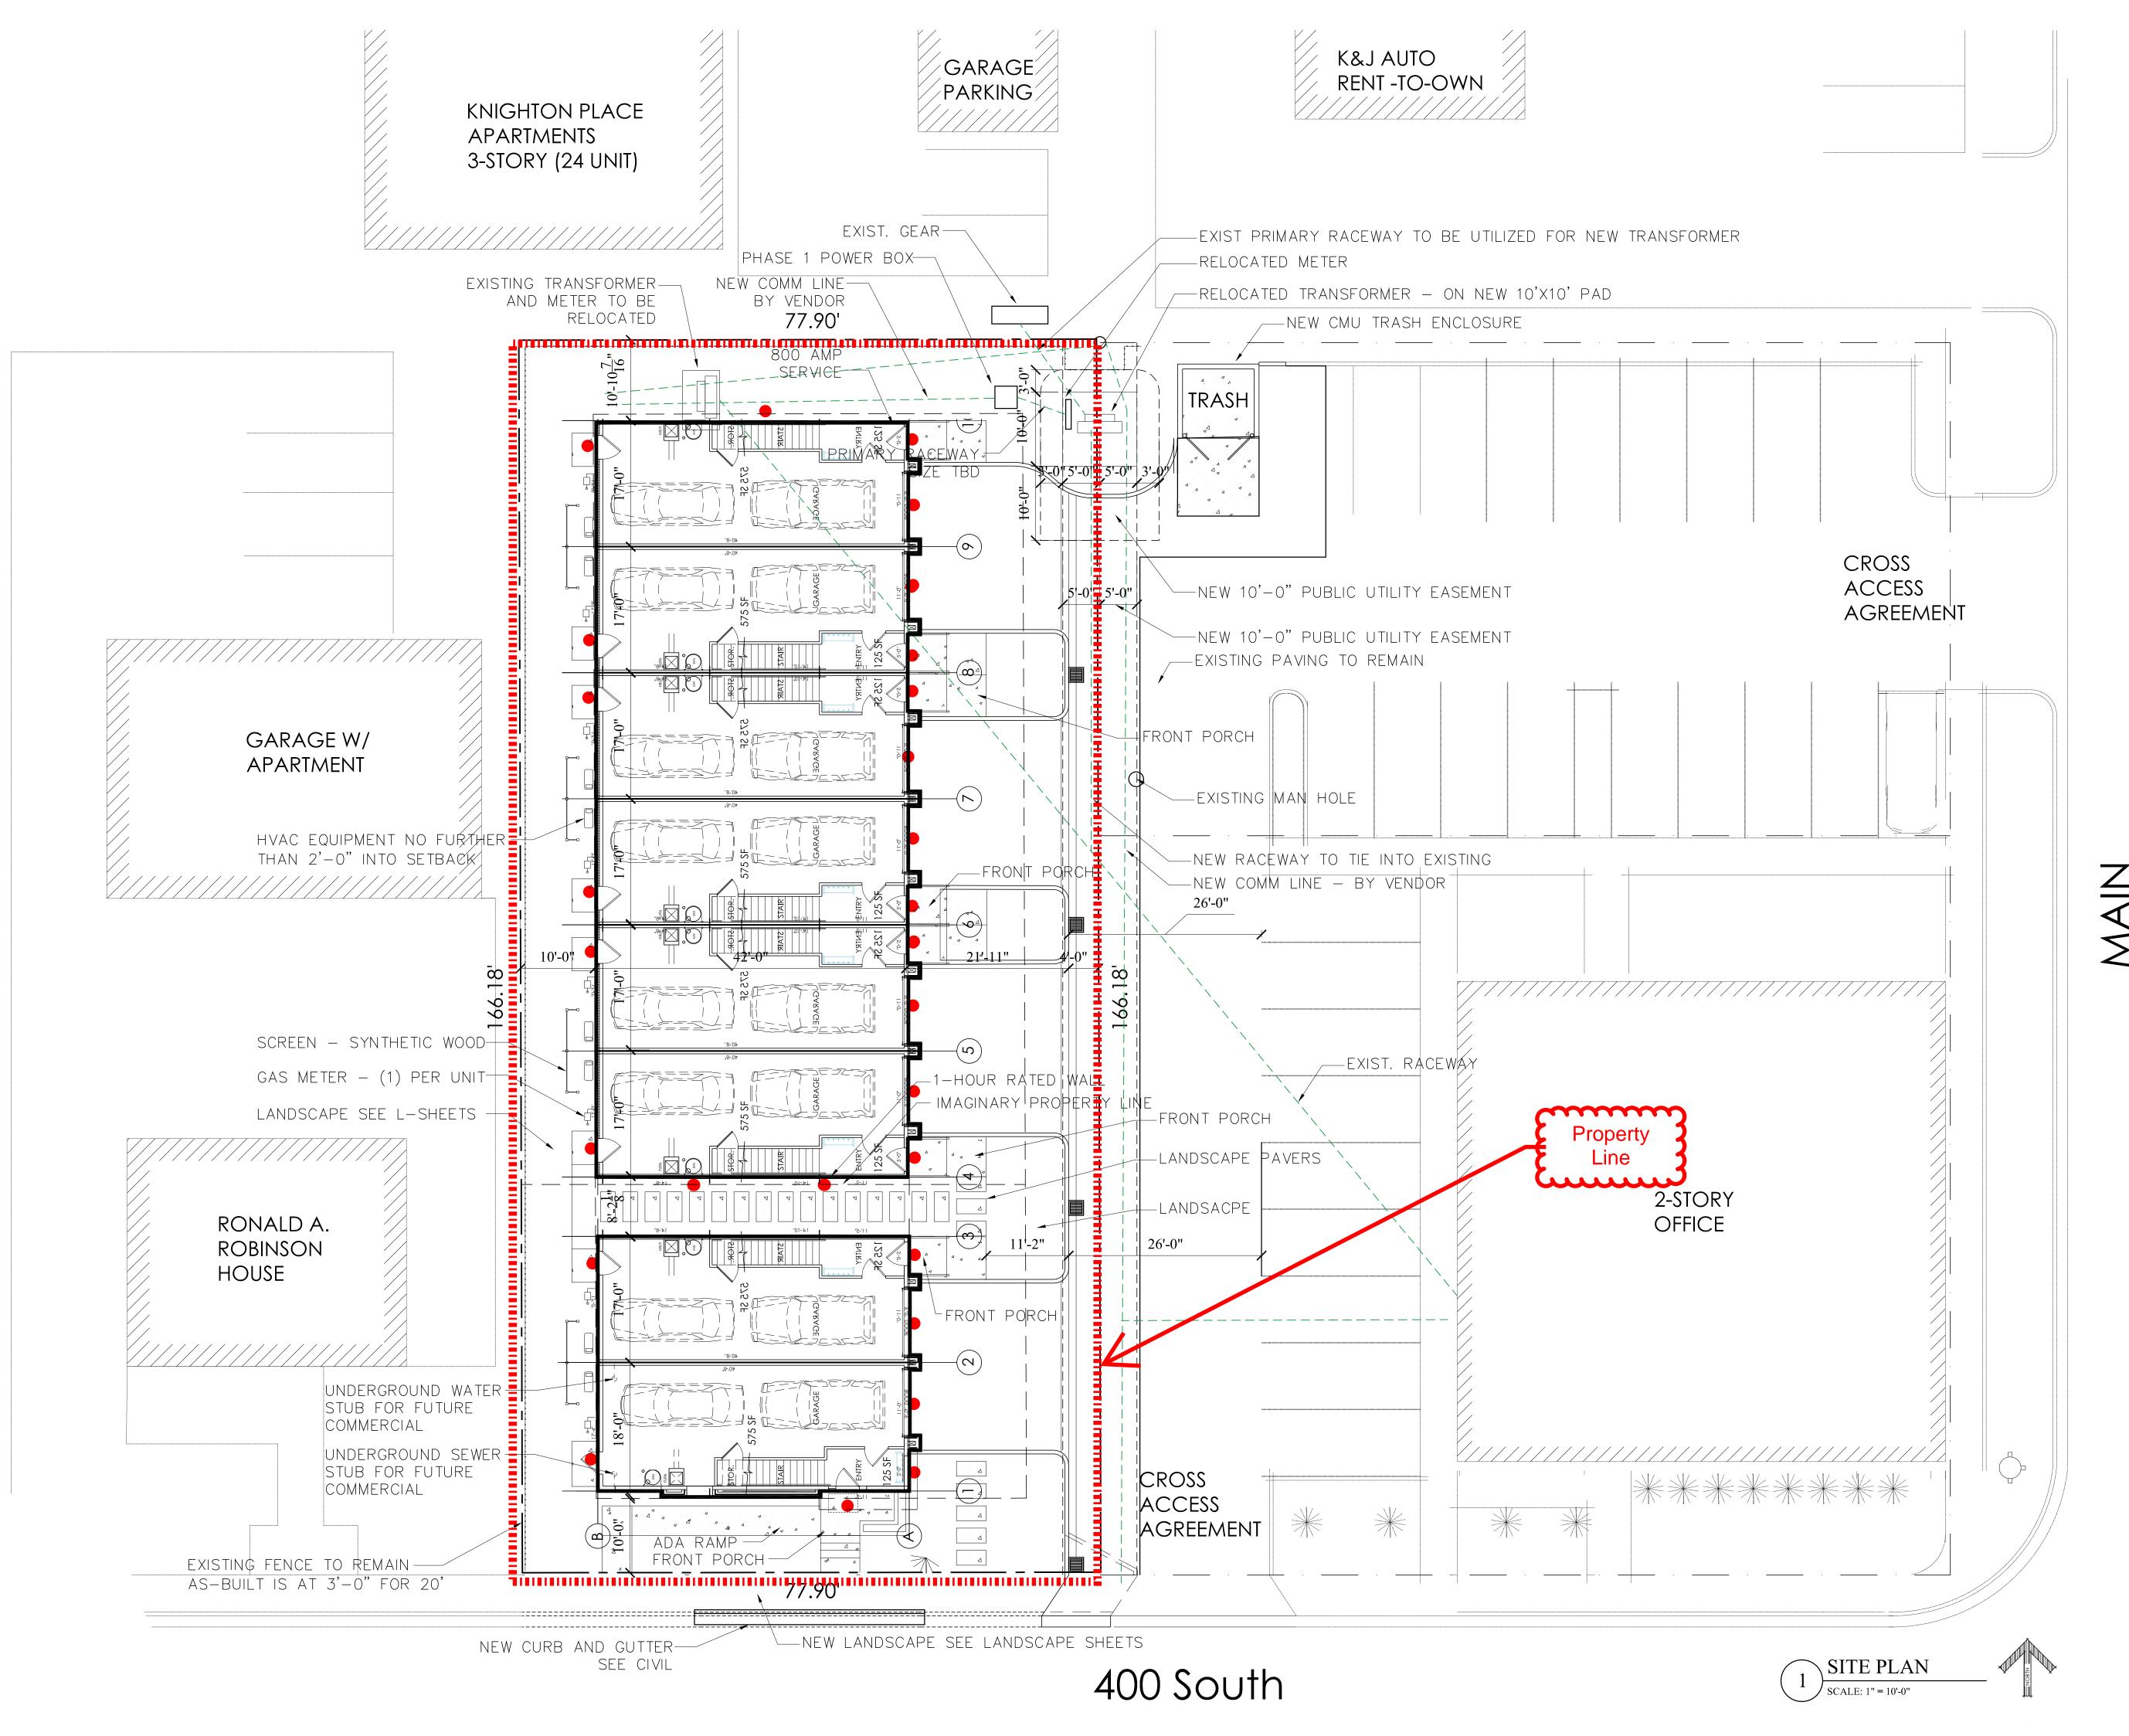
PROJECT #: 22-009 DRAWN BY: REVIEWED BY: ISSUED: 11.17.2022




**DETAILS** 

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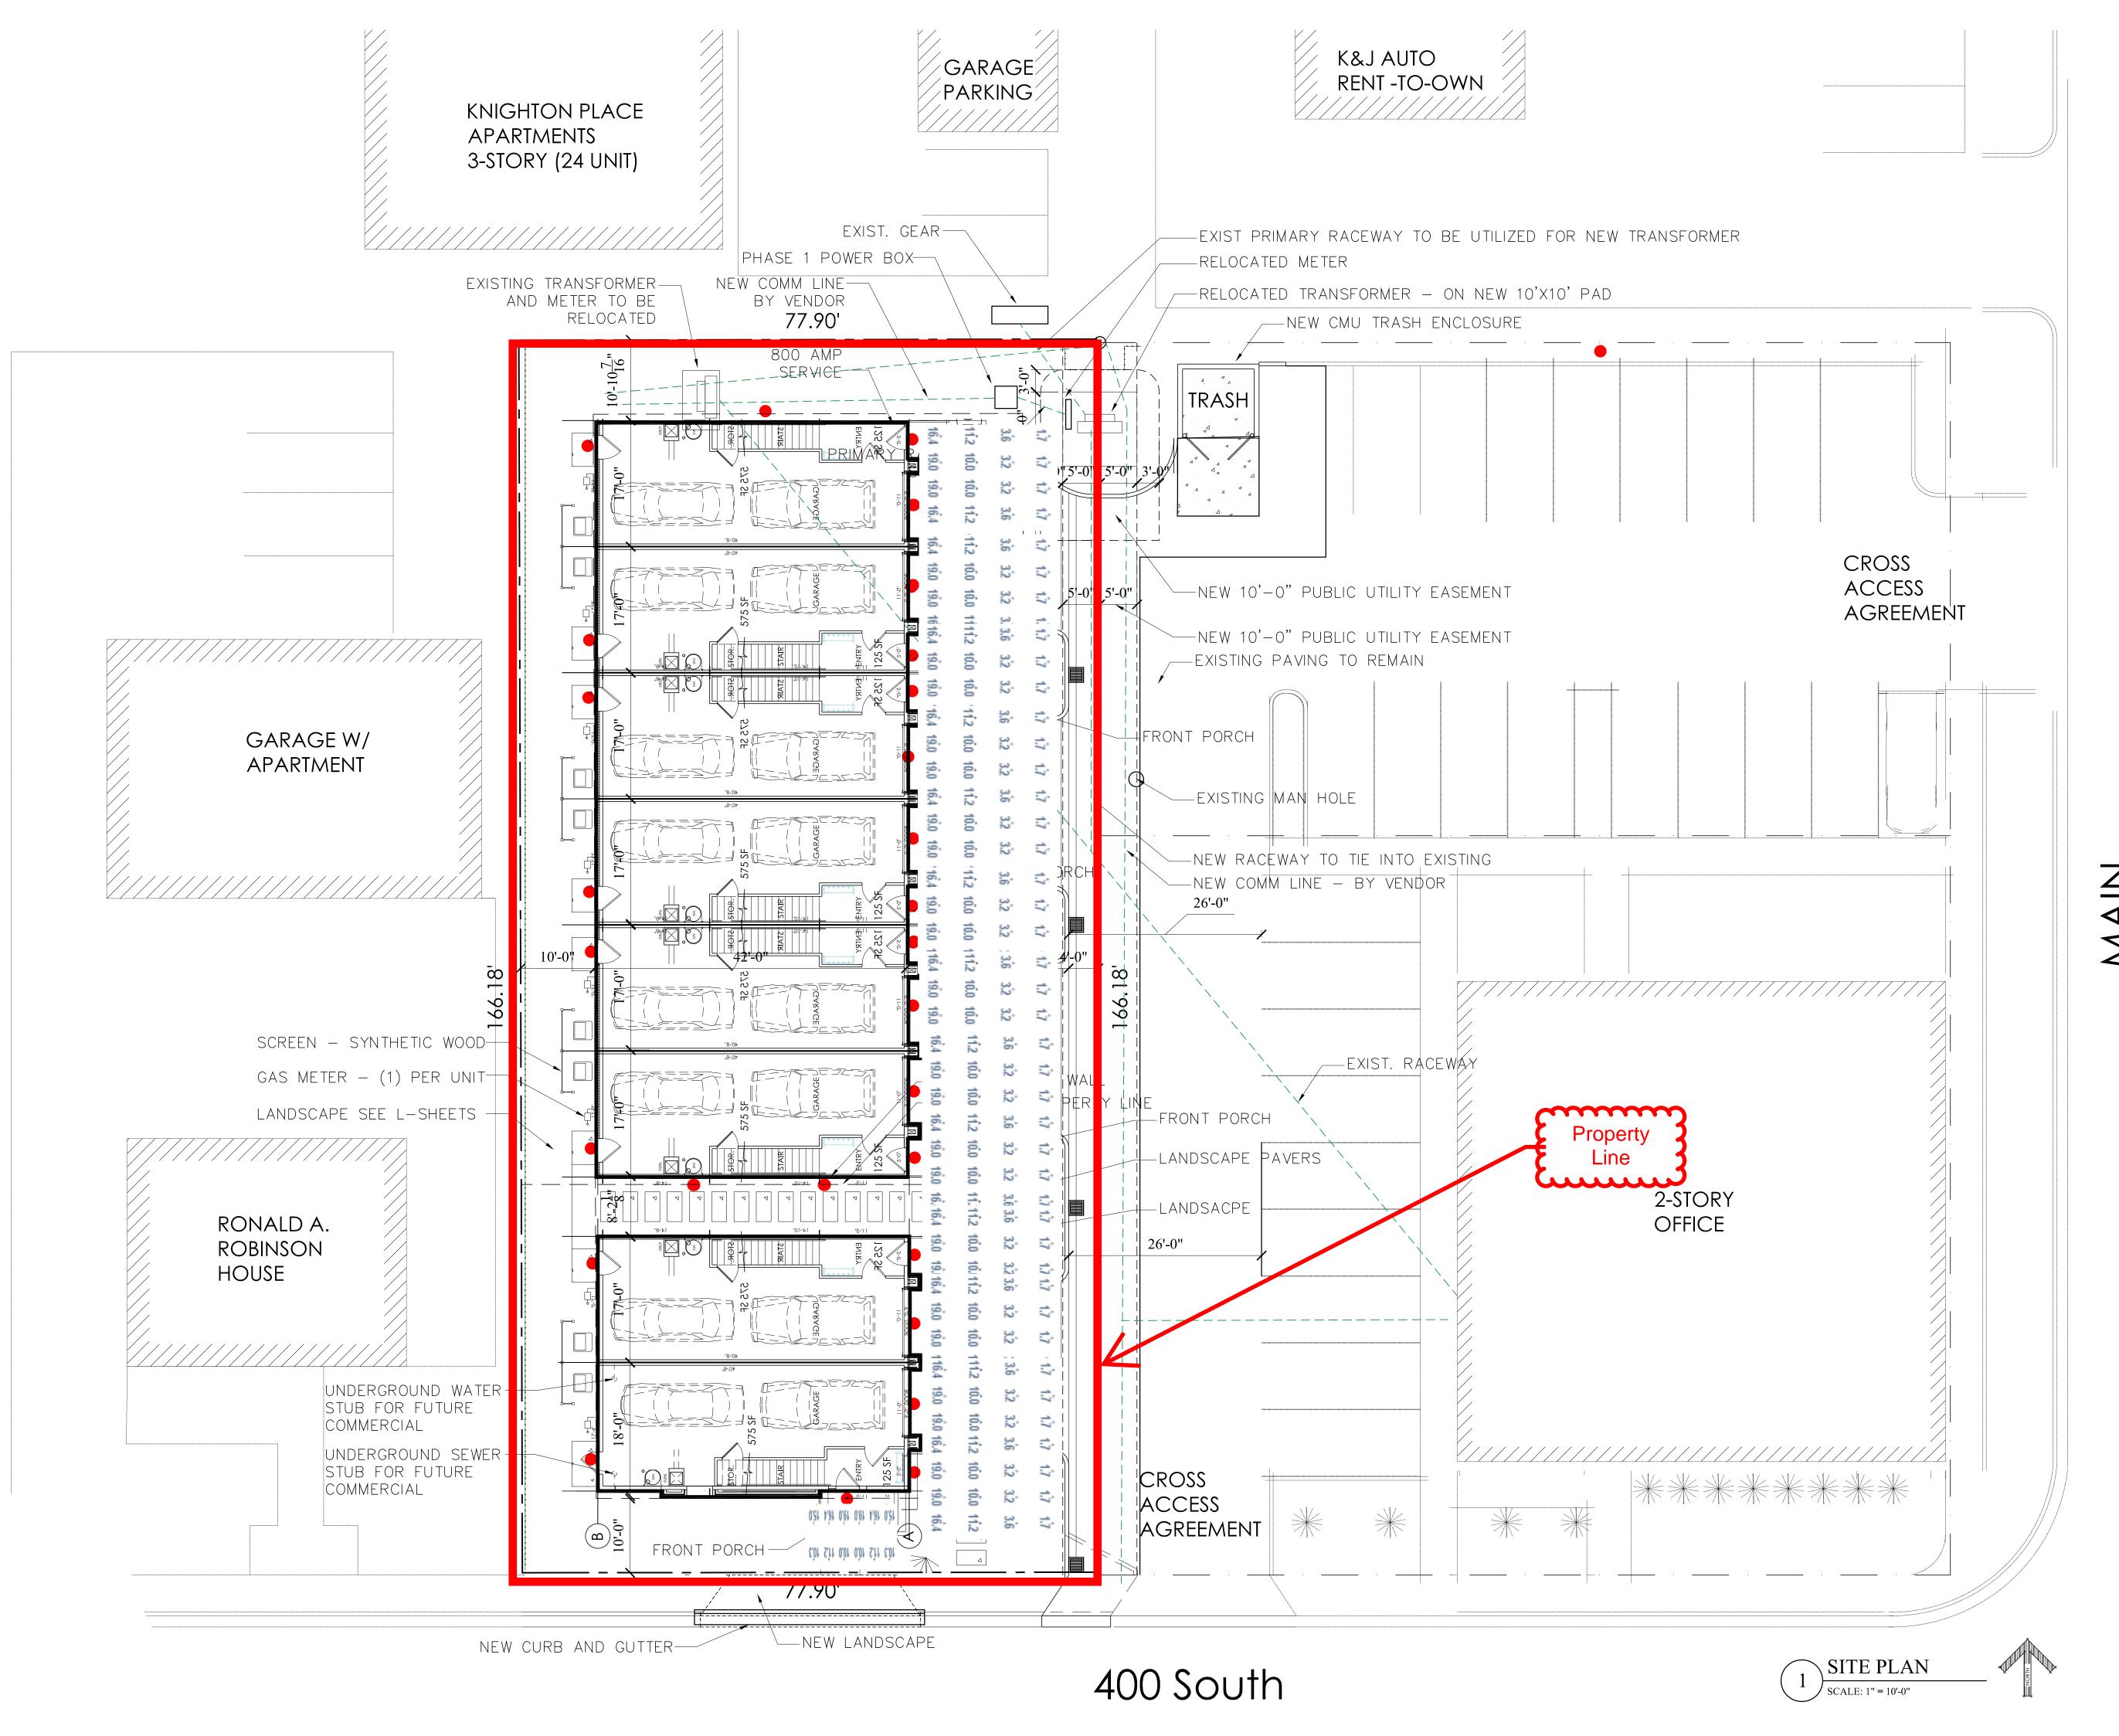
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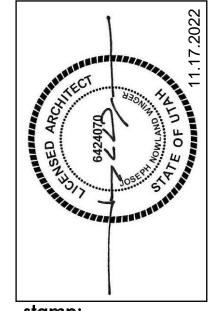
VNS at 400

REVISION BLOCK
NO. DATE: DESCRIPTION:

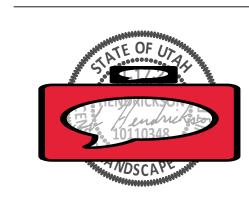E100
LIGHTING
PLAN

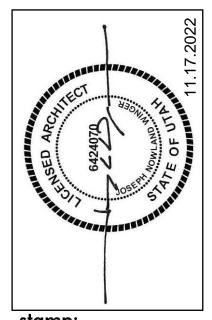date:
11.17.2022





stam

VNS at 400

REVISION BLOCK
NO. DATE: DESCRIPTION:

E101
PHOTOMETRIC
PLAN
date:
11.17.2022

# BOUNTIFUL 390 APARTMENTS CONSTRUCTION DRAWINGS

11/1/2022

LEGEND EXISTING



		ADJACENT PROPERTY BOUNDARY		PROPERTY BOUNDARY
	w	CULINARY WATER LINE	——— w ———	CULINARY WATER LINE (SIZE SHOWN ON PLAN)
	ss	SANITARY SEWER LINE	ss	SANITARY SEWER LINE (SIZE SHOWN ON PLAN)
	sd	STORM DRAIN LINE	SD	STORM DRAIN LINE (SIZE SHOWN ON PLAN)
	ir	IRRIGATION LINE	——————————————————————————————————————	IRRIGATION LINE (SIZE SHOWN ON PLAN)
	g	GAS LINE	G	GAS LINE
	e	UNDERGROUND POWER LINE	— — E —	UNDERGROUND POWER LINE
	е ——	AERIAL POWER LINE	——— E ———	AERIAL POWER LINE
	c	UNDERGROUND COMMUNICATION LINE		UNDERGROUND COMMUNICATION LINE
	####	CONTOUR MINOR		CONTOUR MAJOR
	- ####	CONTOUR MAJOR		CONTOUR MINOR
X	X	FENCE	XX	FENCE
		ASPHALT PAVEMENT		BUILDING SETBACK
		CLOSED FACE CURB AND GUTTER		ASPHALT PAVEMENT
		OPEN FACE CURB AND GUTTER		CLOSED FACE CURB & GUTTER
	4	CONCRETE PAVEMENT		OPEN FACE CURB & GUTTER
		EXISTING TO BE REMOVED		CURB & GUTTER TRANSITION
	W	WATER VALVE	4 4	CONCRETE PAVEMENT
		FIRE HYDRANT	W	WATER VALVE
	$\langle W \rangle$	WATER METER	$\overline{\bigcirc}$	FIRE HYDRANT
	S	SEWER MANHOLE	⟨ <b>W</b> ⟩	WATER METER
		STORM DRAIN BOX	S	SEWER MANHOLE
		STORM WATER CATCH BASIN		STORM DRAIN BOX
		ROAD SIGN		STORM WATER CATCH BASIN
		POWER POLE		ROAD SIGN
	Months of the state of the stat	DECIDUOUS TREE		
		CONIFEROUS TREE		
	V			

Sheet List Table			
Sheet Number	Sheet Title		
C001	COVER & LEGEND		
C101	DEMOLITION PLAN		
C102	SITE & DIMENSION PLAN		
C201	GRADING PLAN		
C301	STORM DRAIN & UTILITY PLAN		
C501	DETAILS		
C502	DETAILS		
C503	DETAILS		

- ALL MATERIALS, WORKMANSHIP, CONSTRUCTION AND PLACEMENT SHALL MEET OR EXCEED THE STANDARDS AND SPECIFICATIONS AS DEFINED IN THE MANUAL OF STANDARD SPECIFICATIONS AND MANUAL OF STANDARD PLANS, UTAH CHAPTER AMERICAN PUBLIC WORKS ASSOCIATION (APWA) AND APPLICABLE CITY, COUNTY, STATE AND FEDERAL REGULATIONS. WHERE THERE IS A CONFLICT BETWEEN THESE PLANS, SPECIFICATIONS OR ANY APPLICABLE STANDARD, THE MOST RESTRICTIVE STANDARD SHALL APPLY. 2. ALL REFERENCES TO ANY PUBLISHED STANDARDS SHALL REFER TO THE LATEST
- REVISION OF SAID STANDARD, UNLESS SPECIFICALLY STATED OTHERWISE. WORK SHALL BE ACCOMPLISHED IN ACCORDANCE WITH THE UTAH CHAPTER OF AMERICAN PUBLIC WORKS ASSOCIATION (APWA) STANDARD PLANS AND
- SPECIFICATIONS, 2017 EDITION. 4. THE CONTRACTOR WILL BE RESPONSIBLE FOR FIELD LOCATING AND VERIFYING ELEVATIONS OF ALL EXISTING SEWER MAINS, WATER MAINS, CURBS, GUTTERS AND OTHER UTILITIES AT THE POINTS OF CONNECTION SHOWN ON THE PLANS AND AT ANY UTILITY CROSSINGS PRIOR TO INSTALLING ANY OF THE SITE ELEMENTS INDICATED IN THESE PLANS. IF A CONFLICT EXISTS AND/OR A DESIGN MODIFICATION IS REQUIRED, THE CONTRACTOR SHALL COORDINATE WITH THE ENGINEER, DESIGN MODIFICATION(S) MUST BE APPROVED BY THE OWNER PRIOR TO BEING IMPLEMENTED.
- THE CONTRACTOR IS SPECIFICALLY CAUTIONED THAT THE LOCATION AND/OR ELEVATIONS OF EXISTING UTILITIES, AS INDICATED ON THESE PLANS, IS BASED ON RECORDS OF THE VARIOUS UTILITY COMPANIES AND, WHERE POSSIBLE, MEASUREMENTS TAKEN IN THE FIELD. THE INFORMATION IS NOT TO BE RELIED UPON AS BEING EXACT OR COMPLETE. THE CONTRACTOR SHALL CONTACT BLUE STAKES (BY DIALING 811) AT LEAST 2 WORKING DAYS PRIOR TO BEGINNING EXCAVATION. TRENCHING OR GRADING TO HAVE ALL REGISTERED UTILITY LOCATIONS MARKED. ALL OTHER UN-REGISTERED UTILITIES (I.E. DITCH, IRRIGATION COMPANY, OTHER SITE-SPECIFIC UTILITIES, ETC.) ARE TO BE LOCATED BY CONTACTING, IN ADVANCE. THE RESPECTIVE REPRESENTATIVE. UTILITY SERVICE LATERALS SHOULD ALSO BE LOCATED PRIOR TO BEGINNING EXCAVATION, TRENCHING OR GRADING ACTIVITIES.
- 6. THE CONTRACTOR SHALL COORDINATE AND COOPERATE WITH THE PROJECT OWNER, LOCAL JURISDICTION AND ALL UTILITY COMPANIES INVOLVED REGARDING RELOCATIONS, ADJUSTMENTS, EXTENSIONS AND REARRANGEMENTS OF EXISTING UTILITIES DURING CONSTRUCTION, AND TO ASSURE THAT THE WORK IS ACCOMPLISHED IN A TIMELY FASHION AND WITH MINIMAL DISRUPTION OF SERVICE. THE CONTRACTOR SHALL BE RESPONSIBLE FOR CONTACTING, IN ADVANCE, ALL PARTIES AFFECTED BY ANY DISRUPTION OF UTILITY SERVICE AS WELL AS THE UTILITY

- 7. THE CONTRACTOR SHALL BE RESPONSIBLE FOR PROTECTING ALL UTILITIES DURING CONSTRUCTION AND FOR COORDINATING WITH THE APPROPRIATE UTILITY COMPANY FOR ANY UTILITY CROSSINGS REQUIRED. THE CONTRACTOR SHALL BE RESPONSIBLE FOR THE COST OF ALL MEANS REQUIRED TO PROTECT EXISTING UTILITIES AND/OR TO WORK AROUND SUCH UTILITIES. THIS INCLUDES, BUT IS NOT LIMITED TO, SUPPORTING EXISTING UTILITIES, SHORING AROUND EXITING UTILITIES, PHASING OF WORK AND
- TRAFFIC CONTROL. 8. THE CONTRACTOR SHALL NOTIFY THE LOCAL JURISDICTION AND AFFECTED UTILITY COMPANY, AND ALL AFFECTED PARTIES A MINIMUM OF 24 HOURS PRIOR TO ANY WATER INTERRUPTION.
- 9. THE CONTRACTOR IS NOT TO OPERATE ANY VALVES, FIRE HYDRANTS AND OTHER APPURTENANCES. COORDINATE WITH THE UTILITY SUPPLIER. 10. THE CONTRACTOR SHALL BE RESPONSIBLE FOR ALL ASPECTS OF SAFETY. INCLUDING, BUT NOT LIMITED TO, EXCAVATION, TRENCHING, SHORING, TRAFFIC CONTROL, SECURITY AND OTHER SITE RELATED SAFETY PRACTICES. REFER TO OSHA
- PUBLICATION 2226, EXCAVATING AND TRENCHING. 11. IF DURING CONSTRUCTION CONDITIONS ARE ENCOUNTERED WHICH COULD INDICATE A SITUATION THAT IS NOT IDENTIFIED IN THE PLANS OR SPECIFICATIONS, THE CONTRACTOR SHALL CONTACT THE ENGINEER IMMEDIATELY.
- 12. THE CONTRACTOR SHALL SUBMIT A CONSTRUCTION TRAFFIC CONTROL PLAN TO THE REVIEWING AGENCY (LOCAL GOVERNMENT, UDOT OR OTHERS AS REQUIRED BY PERMIT) FOR REVIEW AND ACCEPTANCE, PRIOR TO ANY CONSTRUCTION ACTIVITIES WITHIN, OR AFFECTING THE RIGHT-OF-WAY. ALL TRAFFIC CONTROL PLANS SHALL BE IN ACCORDANCE WITH MUTCD OR UDOT STANDARDS. THE CONTRACTOR SHALL BE RESPONSIBLE FOR PROVIDING ALL TRAFFIC CONTROL DEVICES, PERSONNEL AND OTHER FACILITIES AS MAY BE REQUIRED BY THE CONSTRUCTION ACTIVITIES.
- 13. THE CONTRACTOR SHALL HAVE ONSITE AT ALL TIMES AN UP TO DATE STORM WATER POLLUTION PREVENTION PLAN (SWPPP), A BMP MAINTENANCE FOLDER, ONE (1) SIGNED COPY OF THE APPROVED PLANS, ONE (1) COPY OF THE APPROPRIATE STANDARDS AND SPECIFICATIONS, AND A COPY OF ANY PERMITS AND AGREEMENTS NEEDED FOR THE JOB.
- 14. THE CONTRACTOR SHALL COMPLY WITH ALL TERMS AND CONDITIONS OF THE UTAH PERMIT FOR STORM WATER DISCHARGE, THE SWPPP AND THE EROSION CONTROL
- 15. ALL BMPS SHALL BE INSTALLED AT THE LIMITS OF CONSTRUCTION AND AT AREAS WITH DISTURBED SOIL (ON OR OFF SITE) PRIOR TO ANY OTHER GROUND DISTURBING ACTIVITY. ALL BMPS SHALL BE MAINTAINED IN GOOD REPAIR BY THE CONTRACTOR,

- UNTIL THE ENTIRE DISTURBED AREA IS STABILIZED WITH HARD SURFACING OR
- LANDSCAPING. 16. MUD AND DEBRIS MUST BE REMOVED BY THE END OF EACH WORKING DAY BY AN APPROPRIATE MECHANICAL METHOD (I.E. MACHINE BROOM SWEEP, HAND SWEEPING,


LEGEND PROPOSED

- 17. THE CONTRACTOR SHALL BE RESPONSIBLE FOR RECORDING AS-CONSTRUCTED INFORMATION ON A SET OF RECORD DRAWINGS KEPT ON THE CONSTRUCTION SITE. THIS RECORD DRAWING SET SHALL BE AVAILABLE TO THE OWNERS/ENGINEERS DESIGNATED REPRESENTATIVE AT ALL TIMES.
- 18. WORK ACTIVITY AND SCHEDULES SHALL BE COORDINATED WITH THE OWNER AND THEIR ACTIVITIES ON-SITE.
- 19. UPON COMPLETION OF CONSTRUCTION, THE SITE SHALL BE CLEANED AND RESTORED TO A CONDITION EQUAL TO, OR BETTER THAN, THAT WHICH EXISTED BEFORE CONSTRUCTION, OR TO THE GRADES AND CONDITION AS REQUIRED BY THESE PLANS
- 20. IMPROVEMENTS DEPICTED IN THESE PLANS AND CONSTRUCTED BY THE CONTRACTOR SHALL BE GUARANTEED BY THE CONTRACTOR TO BE FREE FROM MATERIAL AND WORKMANSHIP DEFECTS FOR A PERIOD OF ONE YEAR FROM THE DATE OF
- 21. THE APPROVED, DESIGNATED PROJECT SUPERVISOR SHALL BE ON-SITE WHILE WORK IS BEING CONDUCTED. 22. SOIL COMPACTION EFFORT SHALL BE PER GEOTECHINCAL REPORT BY CIVIL SOLUTIONS GROUP.

**BLUE STAKES OF UTAH** UTILITY NOTIFICATION CENTER, INC. www.bluestakes.org 1-800-662-4111


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Lond

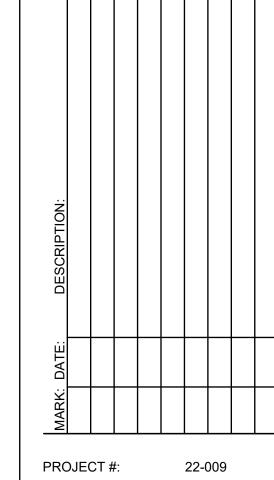

A. OCHSENBEIN DRAWN BY:

PROJECT MANAGER: W. SOUTHWICK

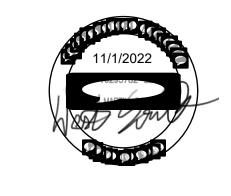

- DESIGNING OUR FUTURE

9. REMOVE TRASH ENCLOSURE
10. REMOVE CONCRETE PAD AND RELOCATE ELECTRICAL EQUIPMENT. SEE

# solutionsgrou

3

**4** 

CACHE VALLEY | P: 435.21 SALT LAKE | P: 801.216.319 UTAH VALLEY | P: 801.874. info@civilsolutionsgroup.net www.civilsolutionsgroup.net

390 APARTMENTS
390 SOUTH MAIN STREET
BOUNTIFUL, UTAH


MARK: DATE: DESCRIPTION:

PROJECT #: 22-009

DRAWN BY: A. OCHSENBEIN

PROJECT MANAGER: W. SOUTHWICK

ISSUED: 11/1/2022

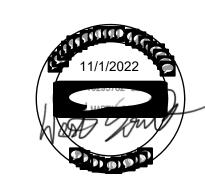

DEMOLITION PLAN

C101




1. ALL ITEMS NOT CALLED OUT FOR REMOVAL ARE TO REMAIN

7. REMOVE STORM WATER STRUCTURE (SUMP)

UTILITY PLAN FOR PROPOSED LOCATIONS.

11. REMOVE CONCRETE WATERWAY

8. REMOVE LIGHT POLE

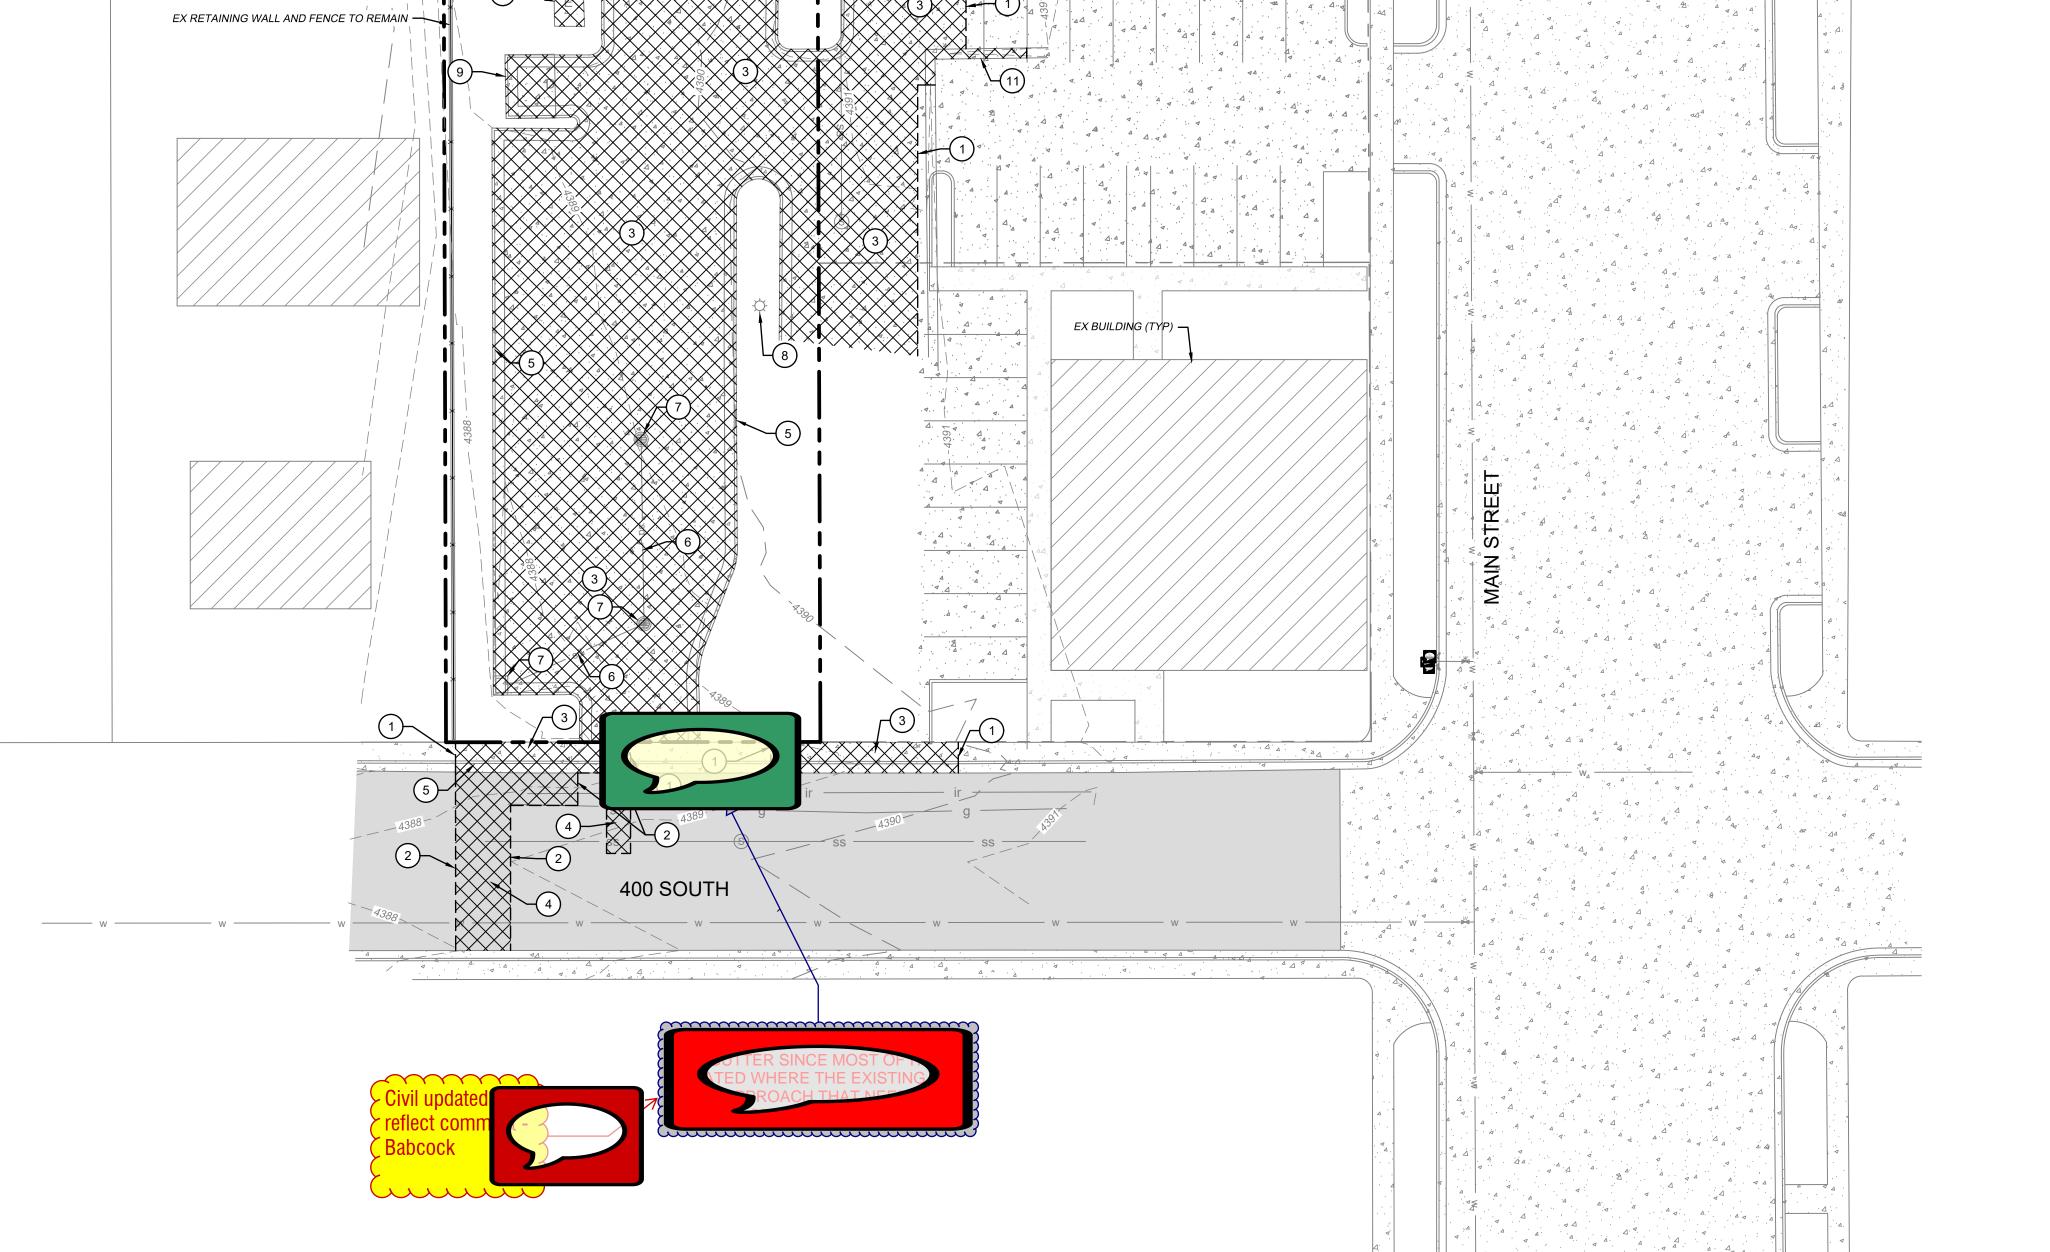

0 20' 40'

Know what's below.

Call 811 before you dig.


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O SITE SHEET KEY NOTES:

PROVIDE, INSTALL, AND/OR CONSTRUCT THE FOLLOWING PER THE SPECIFICATIONS GIVEN OR REFERENCED, THE DETAILS NOTED, AND/OR AS SHOWN ON THE CONSTRUCTION DRAWINGS:

STANDARD DUTY CONCRETE PAVEMENT (1/C501)
HEAVY DUTY CONCRETE PAVEMENT (2/C501)
CONCRETE STAIRS. SEE ARCHITECTURAL PLANS FOR DETAILS.

CURB (10/C501)

DRIVEWAY APPROACH (5/C501)

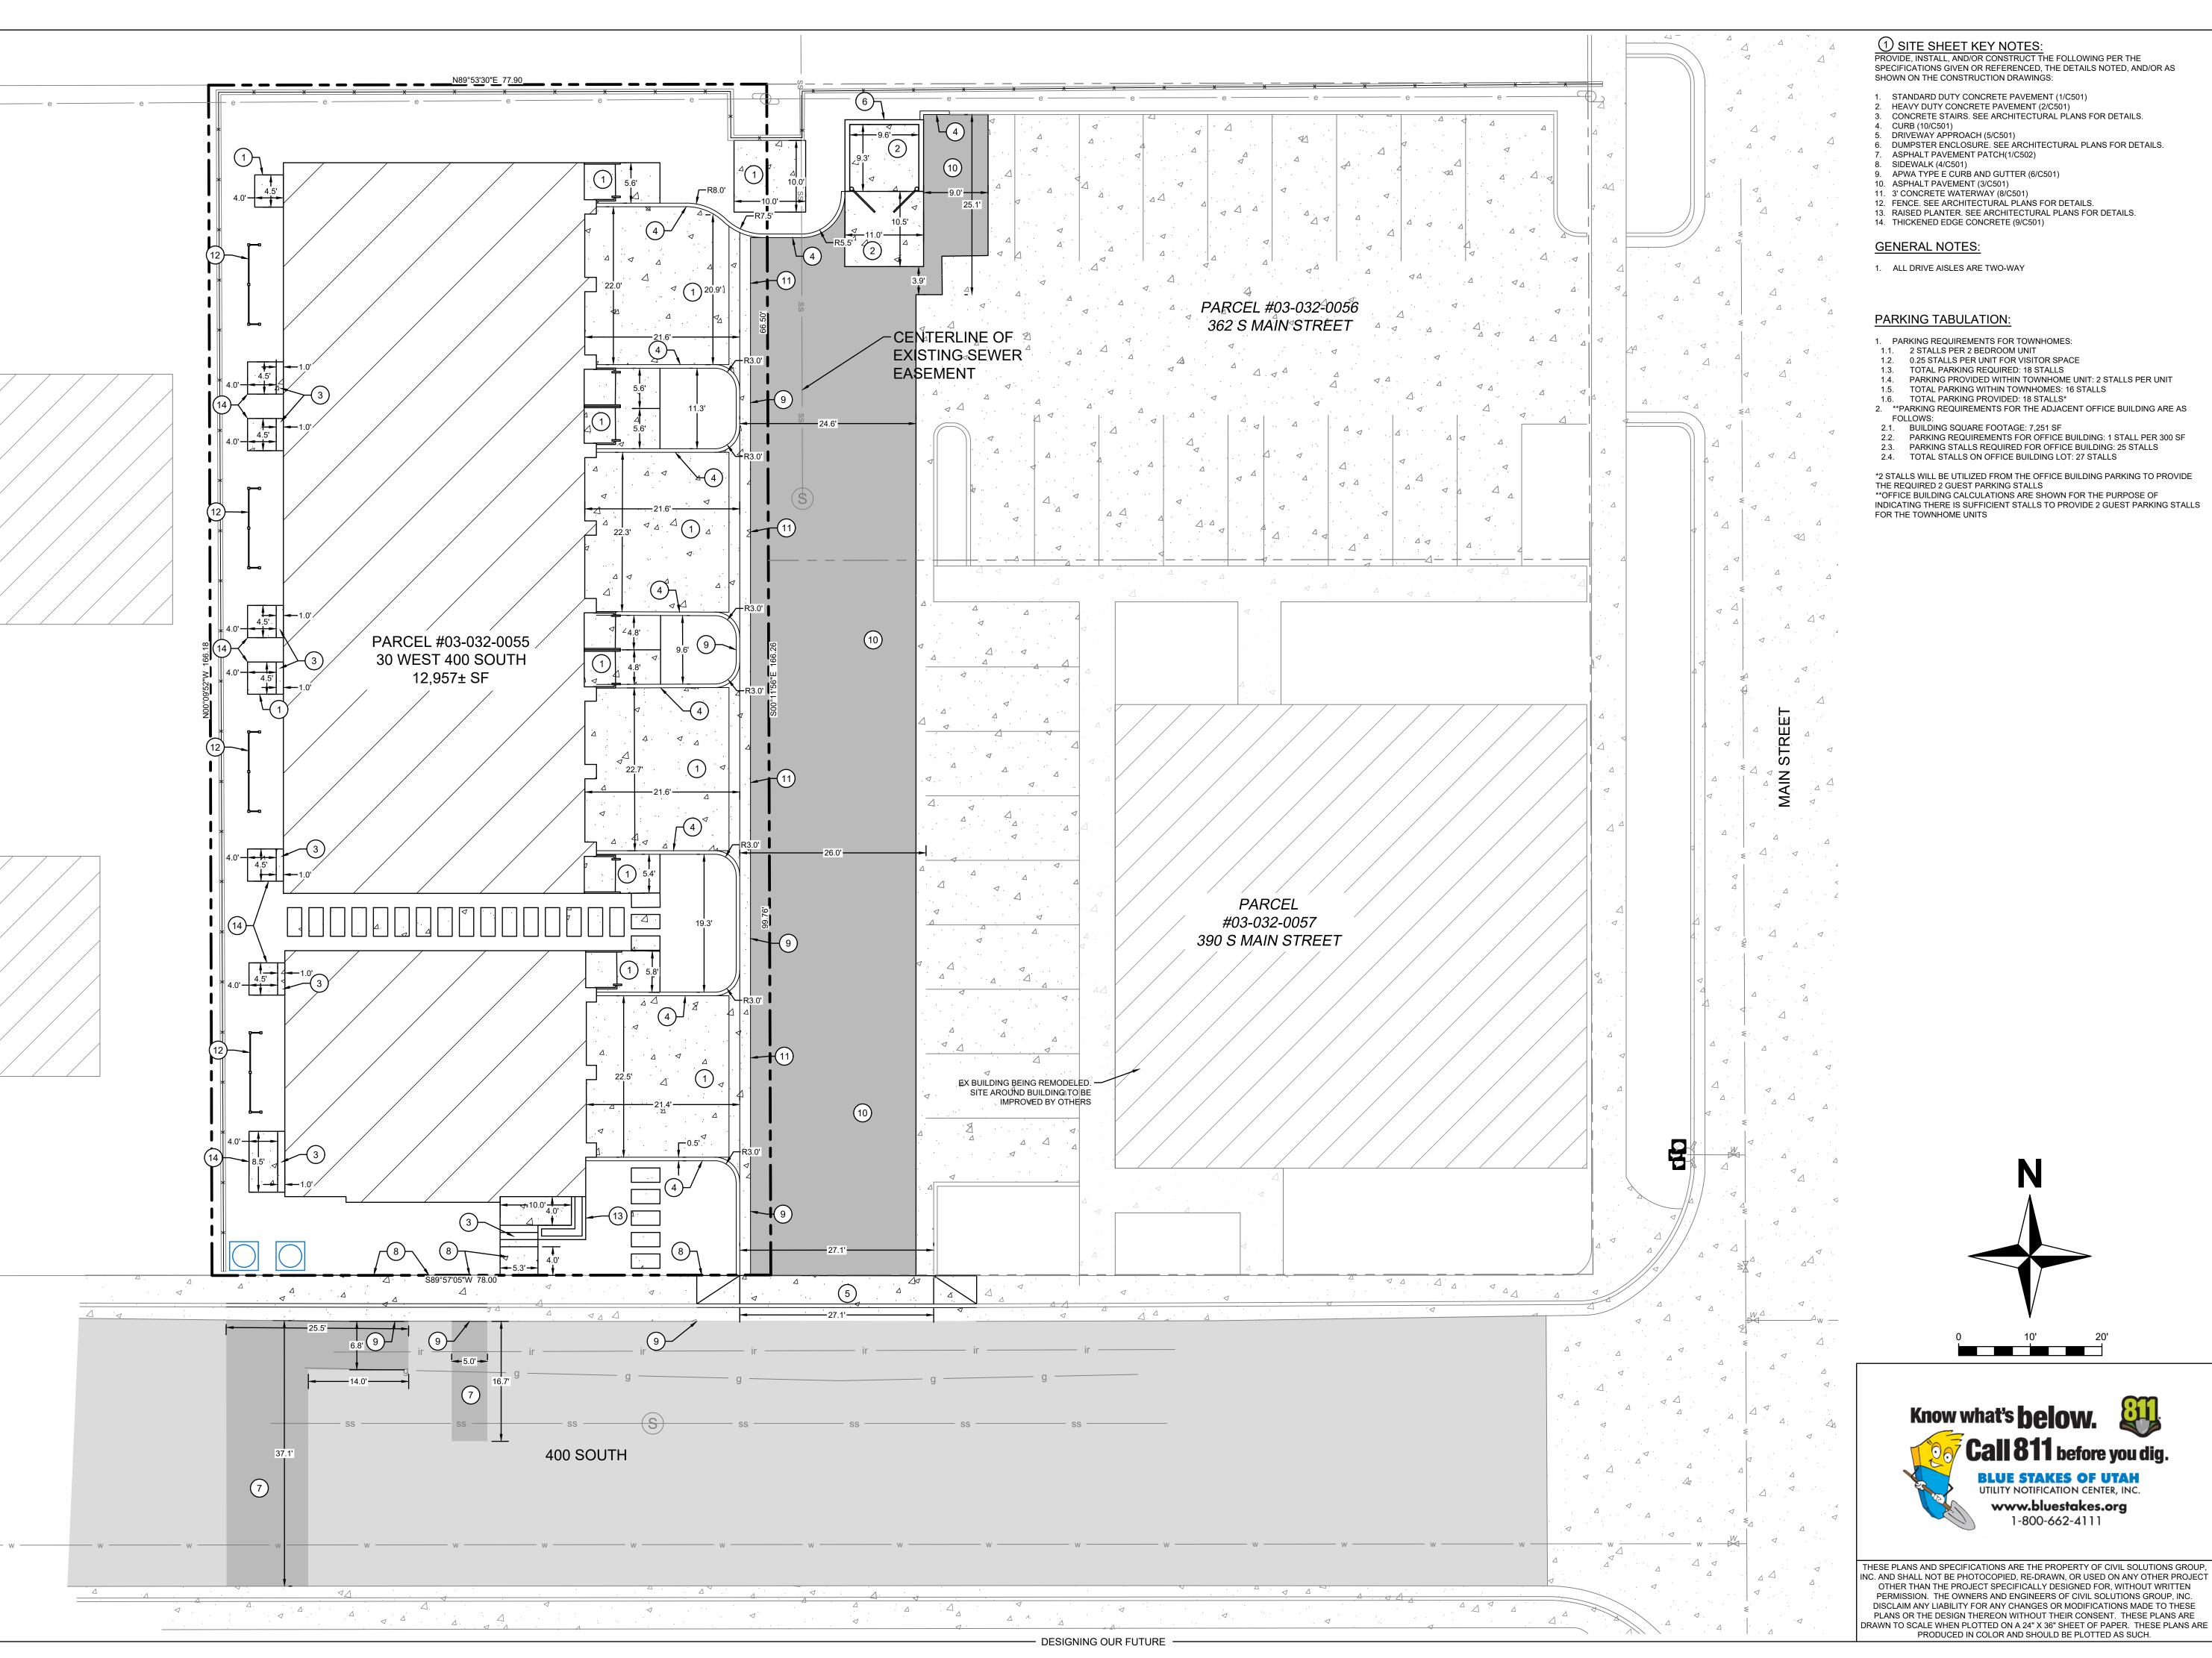DUMPSTER ENCLOSURE. SEE ARCHITECTURAL PLANS FOR DETAILS.

ASPHALT PAVEMENT PATCH(1/C502)

SIDEWALK (4/C501)

 SIDEWALK (4/C501)
 APWA TYPE E CURB AND GUTTER (6/C501)
 ASPHALT PAVEMENT (3/C501)
 3' CONCRETE WATERWAY (8/C501) 12. FENCE. SEE ARCHITECTURAL PLANS FOR DETAILS. 13. RAISED PLANTER. SEE ARCHITECTURAL PLANS FOR DETAILS.
14. THICKENED EDGE CONCRETE (9/C501)

# **GENERAL NOTES:**

1. ALL DRIVE AISLES ARE TWO-WAY

# PARKING TABULATION:

PARKING REQUIREMENTS FOR TOWNHOMES:
 1.1. 2 STALLS PER 2 BEDROOM UNIT
 1.2. 0.25 STALLS PER UNIT FOR VISITOR SPACE
 1.3. TOTAL PARKING REQUIRED: 18 STALLS

PARKING PROVIDED WITHIN TOWNHOME UNIT: 2 STALLS PER UNIT 1.4. FARRING PROVIDED WITHIN TOWNHOMES: 16 STALLS
1.5. TOTAL PARKING WITHIN TOWNHOMES: 16 STALLS
1.6. TOTAL PARKING PROVIDED: 18 STALLS\*
2. \*\*PARKING REQUIREMENTS FOR THE ADJACENT OFFICE BUILDING ARE AS

2.1. BUILDING SQUARE FOOTAGE: 7,251 SF
2.2. PARKING REQUIREMENTS FOR OFFICE BUILDING: 1 STALL PER 300 SF
2.3. PARKING STALLS REQUIRED FOR OFFICE BUILDING: 25 STALLS
2.4. TOTAL STALLS ON OFFICE BUILDING LOT: 27 STALLS

Know what's **below.** 

Call 811 before you dig.

**BLUE STAKES OF UTAH** UTILITY NOTIFICATION CENTER, INC.


www.bluestakes.org

1-800-662-4111

\*2 STALLS WILL BE UTILIZED FROM THE OFFICE BUILDING PARKING TO PROVIDE THE REQUIRED 2 GUEST PARKING STALLS \*\*OFFICE BUILDING CALCULATIONS ARE SHOWN FOR THE PURPOSE OF INDICATING THERE IS SUFFICIENT STALLS TO PROVIDE 2 GUEST PARKING STALLS

S

TMENTS AIN STREET JTAH 390 AP/ 390 SOUTH BOUNTIFUL

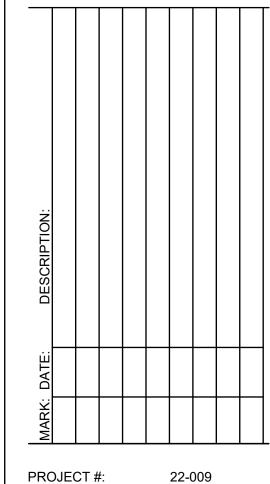


22-009 A. OCHSENBEIN DRAWN BY:

PROJECT MANAGER: W. SOUTHWICK ISSUED: 11/1/2022



SITE & DIMENSION PLAN C102

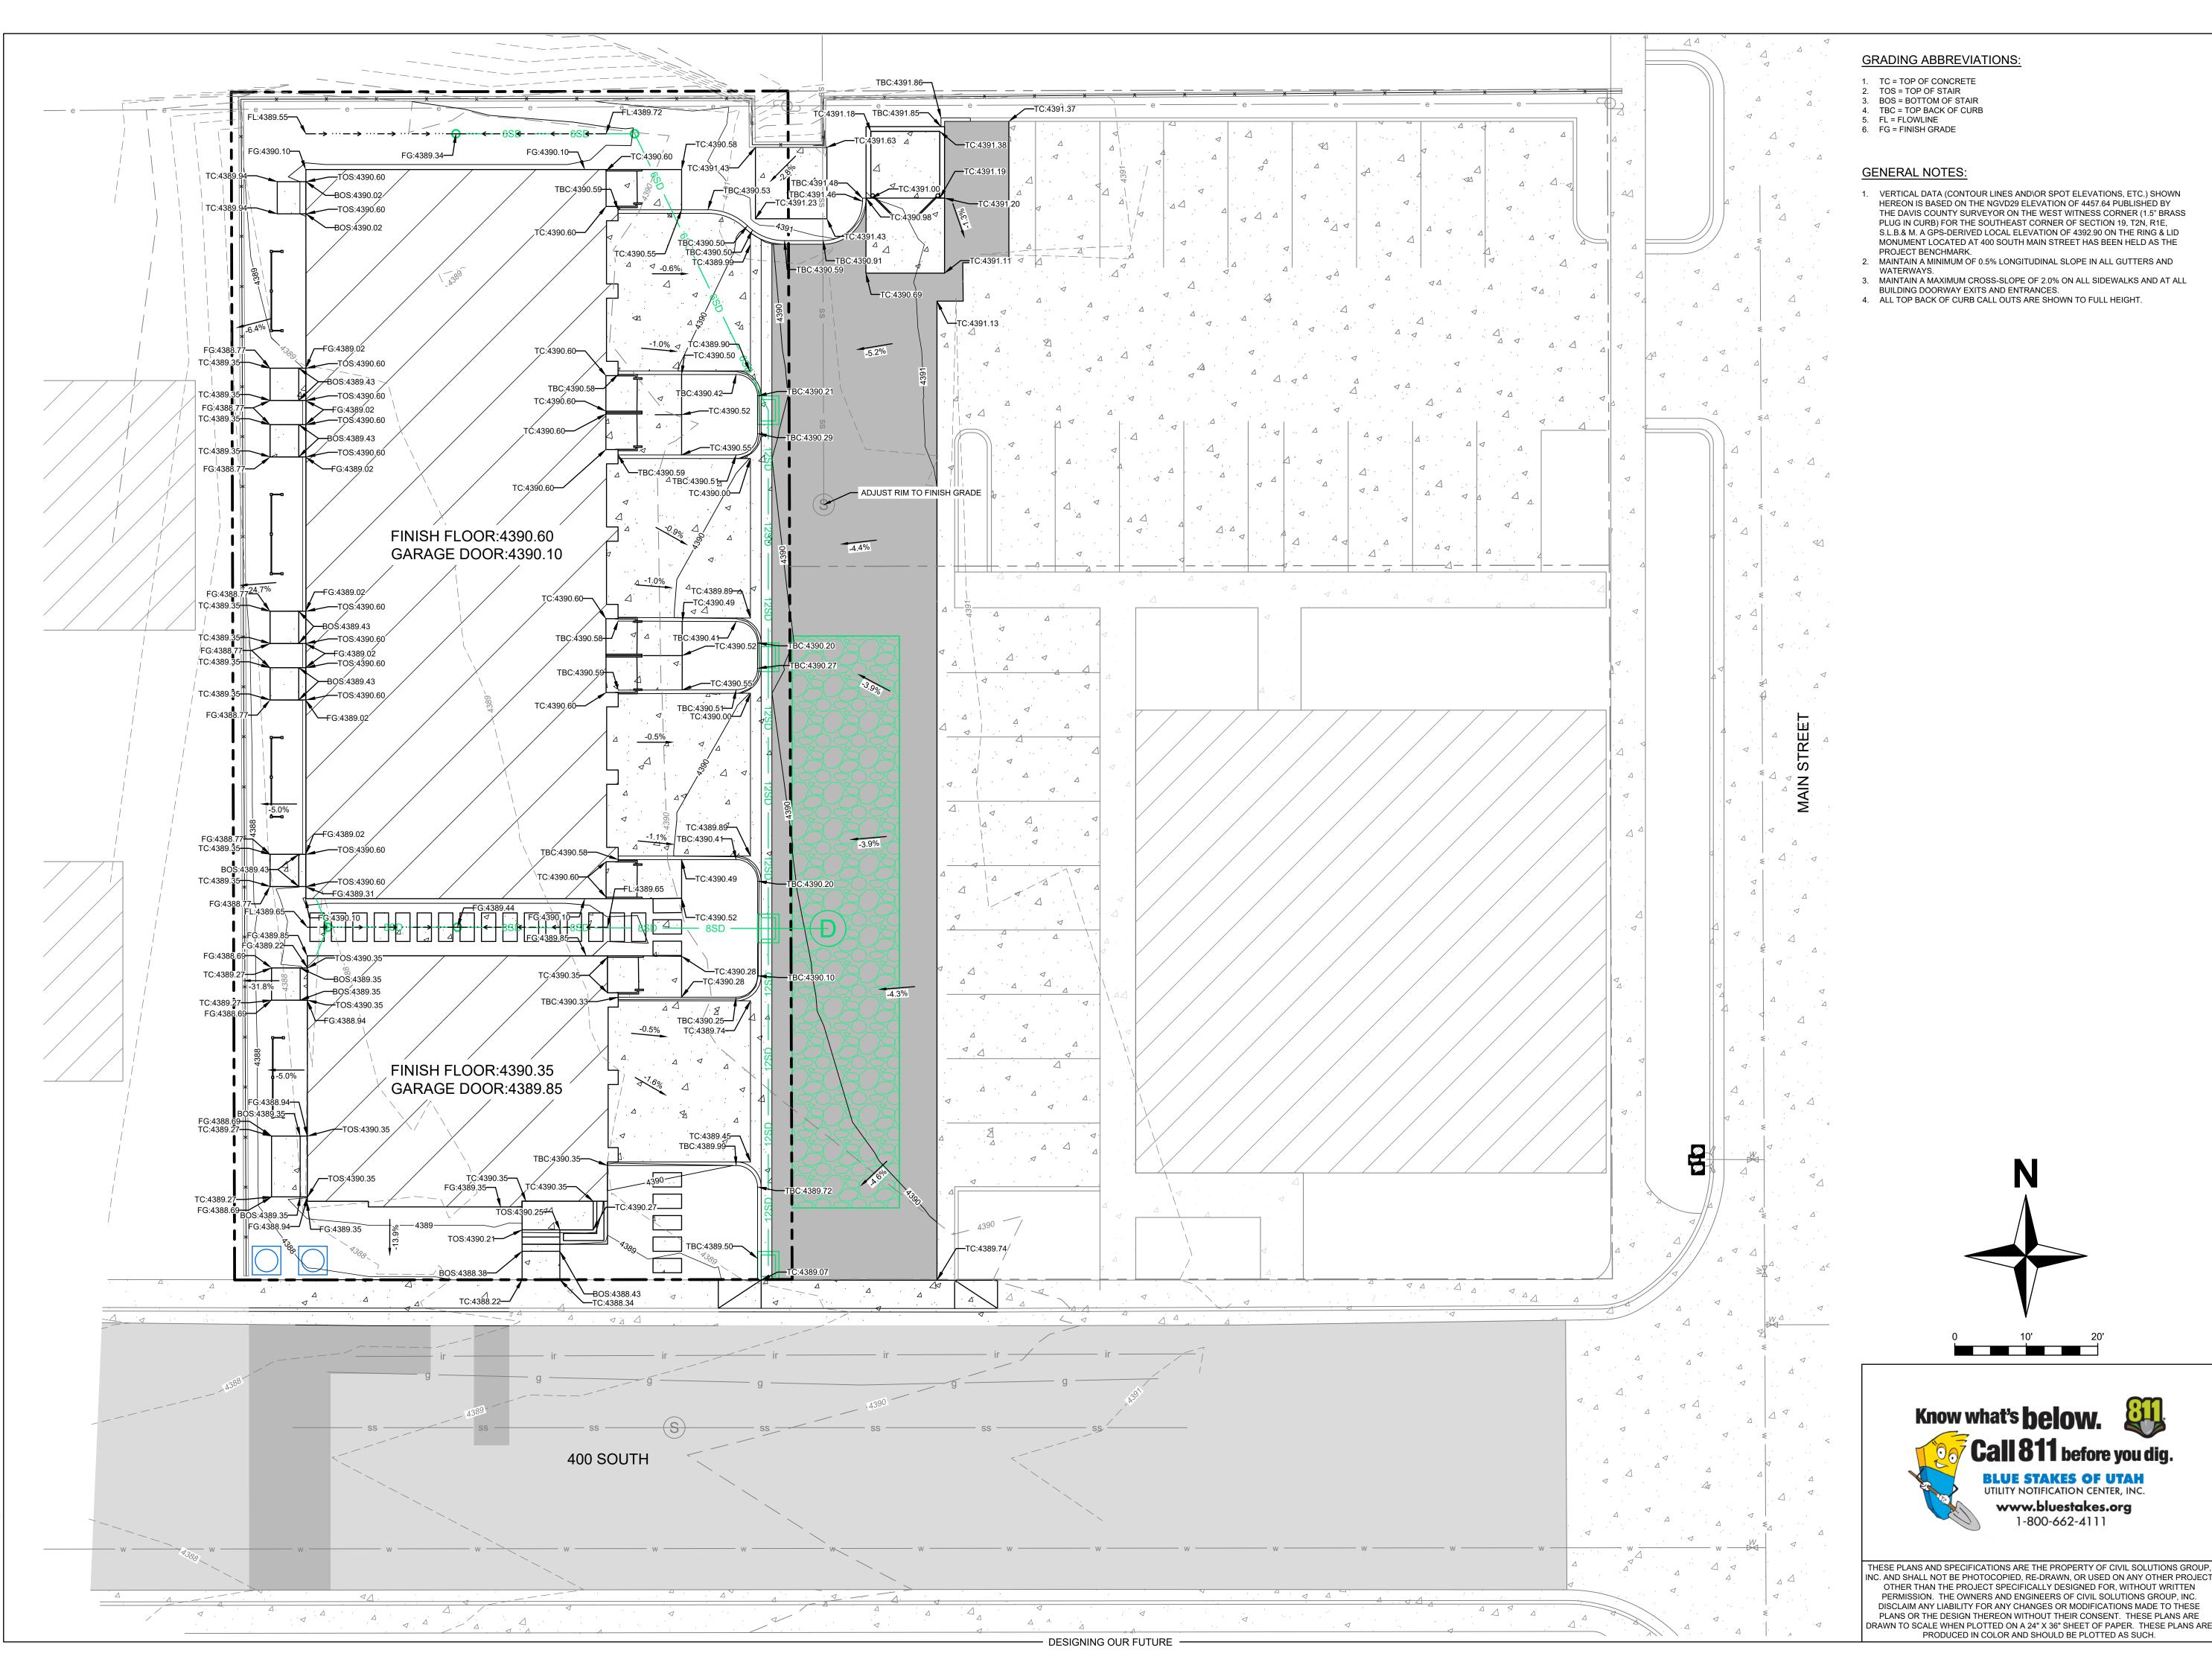

# **GRADING ABBREVIATIONS:**

- TC = TOP OF CONCRETE
  TOS = TOP OF STAIR
  - BOS = BOTTOM OF STAIR
  - TBC = TOP BACK OF CURB 5. FL = FLOWLINE
  - 6. FG = FINISH GRADE

# **GENERAL NOTES:**

- 1. VERTICAL DATA (CONTOUR LINES AND\OR SPOT ELEVATIONS, ETC.) SHOWN HEREON IS BASED ON THE NGVD29 ELEVATION OF 4457.64 PUBLISHED BY THE DAVIS COUNTY SURVEYOR ON THE WEST WITNESS CORNER (1.5" BRASS PLUG IN CURB) FOR THE SOUTHEAST CORNER OF SECTION 19, T2N, R1E, S.L.B.& M. A GPS-DERIVED LOCAL ELEVATION OF 4392.90 ON THE RING & LID MONUMENT LOCATED AT 400 SOUTH MAIN STREET HAS BEEN HELD AS THE
- PROJECT BENCHMARK. 2. MAINTAIN A MINIMUM OF 0.5% LONGITUDINAL SLOPE IN ALL GUTTERS AND
- WATERWAYS.
- 3. MAINTAIN A MAXIMUM CROSS-SLOPE OF 2.0% ON ALL SIDEWALKS AND AT ALL

Know what's **below**.

Call 811 before you dig.

BLUE STAKES OF UTAH UTILITY NOTIFICATION CENTER, INC.

www.bluestakes.org

1-800-662-4111

IC. AND SHALL NOT BE PHOTOCOPIED, RE-DRAWN, OR USED ON ANY OTHER PROJECT OTHER THAN THE PROJECT SPECIFICALLY DESIGNED FOR, WITHOUT WRITTEN

PERMISSION. THE OWNERS AND ENGINEERS OF CIVIL SOLUTIONS GROUP, INC. DISCLAIM ANY LIABILITY FOR ANY CHANGES OR MODIFICATIONS MADE TO THESE PLANS OR THE DESIGN THEREON WITHOUT THEIR CONSENT. THESE PLANS ARE

BUILDING DOORWAY EXITS AND ENTRANCES. 4. ALL TOP BACK OF CURB CALL OUTS ARE SHOWN TO FULL HEIGHT.

> TMENTS N STREET AH 390 AP/ 390 SOUTH BOUNTIFUI

S


PROJECT #: 22-009 A. OCHSENBEIN DRAWN BY:

PROJECT MANAGER: W. SOUTHWICK ISSUED:



GRADING PLAN

C201

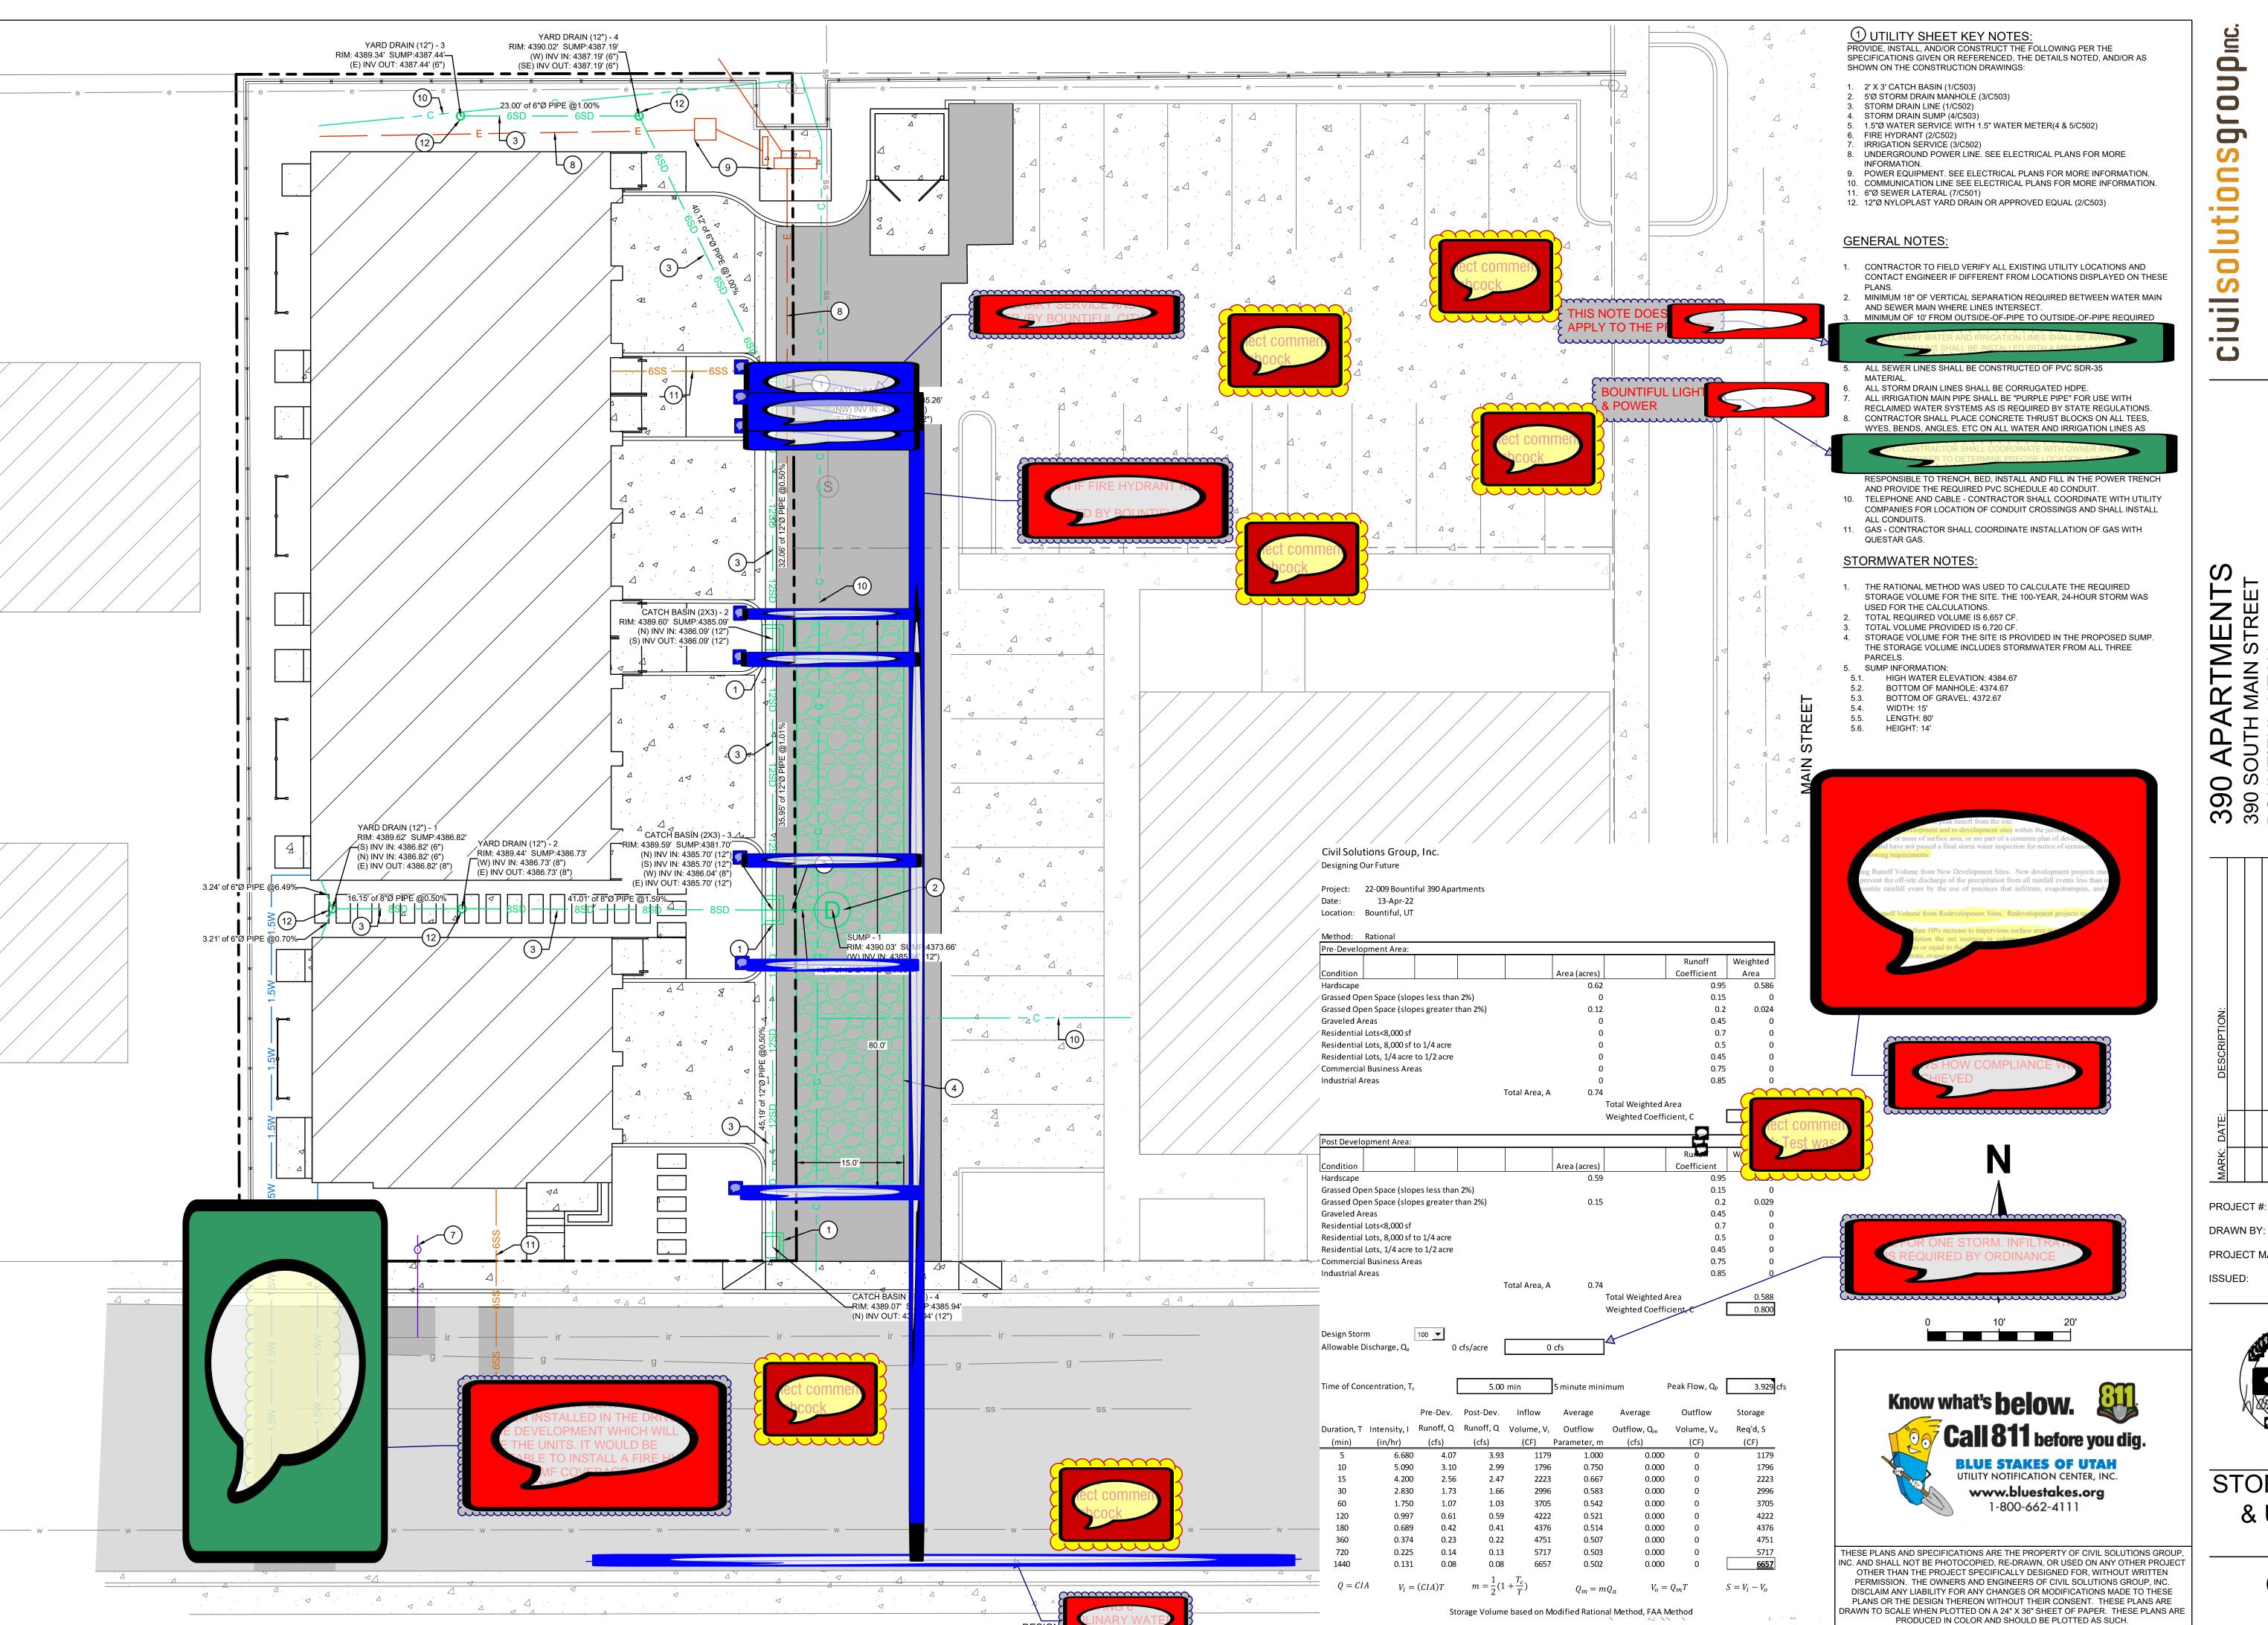

'MEN' N STRE! AH 390 AP/ 390 SOUTH BOUNTIFUL

PROJECT #:

22-009


A. OCHSENBEIN PROJECT MANAGER: W. SOUTHWICK

ISSUED: 11/1/2022



STORM DRAIN & UTILITY **PLAN** 

C301

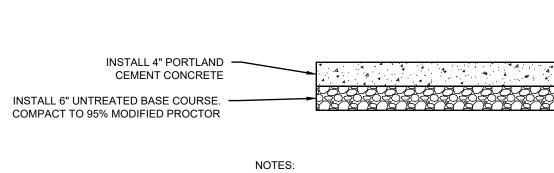


1. PAVEMENT SECTION SHALL CONFORM TO THE SITE GEOTECHNICAL STUDY PERFORMED BY CIVIL SOLUTIONS GROUP.




BOUNTIFUL STANDARD TYPE B DRIVE APPROACH TO BE USED WHEN WALK IS AGAINST CURB

# **PLAN VIEW**

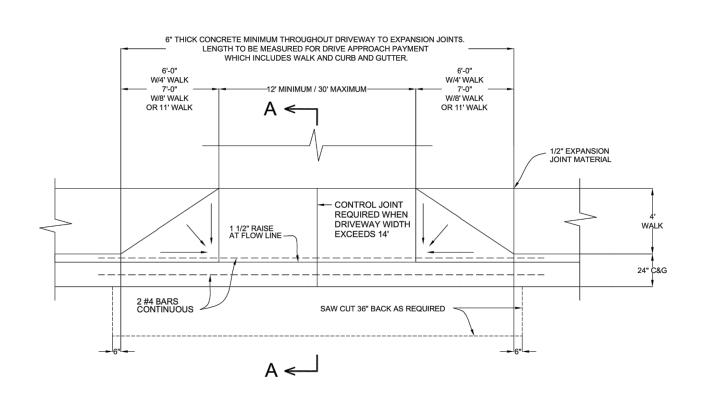


# SECTION A-A

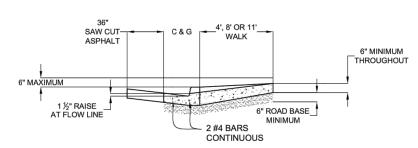


# NOTES

- 1. CONCRETE: CLASS 4000 PER APWA SECTION 03304. PLACE PER APWA SECTION 02770. CURE PER APWA SECTION 03390
  2. COMPACT EXISTING SUBGRADE 95% MINIMUM (MODIFIED PROCTOR).
  3. CURING BY APPLICATION OF CURING COMPOUND PER CURRENT APWA SPECIFICATIONS.
  4. WHERE CONCRETE, OR ASPHALT IS TO BE REMOVED, THE MATERIAL MUST BE SAWCUT TO FULL DEPTH WITH STRAIGHT LINES. MINIMUM WIDTH OF ASPHALT REMOVAL IN FRONT OF A DRIVE APPROACH IS 3 FT- 0 INCHES.
  5. 6" ROAD BASE MINIMUM UNDER ALL NEW CONCRETE.
  6. EPOLY COATED PERAP BEQUIPED.
- 6. EPOXY COATED REBAR REQUIRED.
  7. STRAIGHT METAL FORMS REQUIRED FOR ALL TANGENT SECTIONS OR WHERE THE CURB RADIUS IS NOT LESS THAN 150 FT.

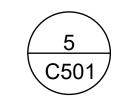

DRIVE APPROACH NOT TO SCALE


> REINFORCEMENT #4 @ 24" O.C.

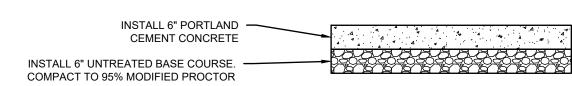

 PAVEMENT SECTION SHALL CONFORM TO THE SITE
 GEOTECHNICAL STUDY PERFORMED BY CIVIL SOLUTIONS GROUP.


HEAVY DUTY CONCRETE

NOT TO SCALE

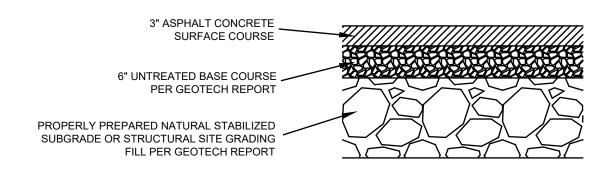




# **PLAN VIEW**

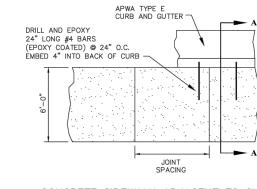

CONCRETE SIDEWALK ADJACENT TO CURB SEE APWA PLAN 231 FOR ADDITIONAL INFORMATION

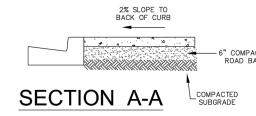

NOTES:

NOTES:


1. SEE DRIVE APPROACH DETAILS FOR SIDEWALK THICKNESS THROUGH DRIVE APPROACHES.

2. EXPANSION JOINT SPACING: 100 FT OR AT DRIVE APPROACHES IF LESS THAN 100 FT.


3. JOINT SPACING: WIDTH (MIN), 1.5xWIDTH (MAX). MATCH CURB JOINT SPACING.

4. APWA MATERIAL SPECIFICATIONS APPLY.


5. TREAT FIELD CUT ENDS OF EPOXY COATED REINFORCING PRIOR TO PLACING CONCRETE FOR SIDEWALK.

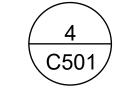




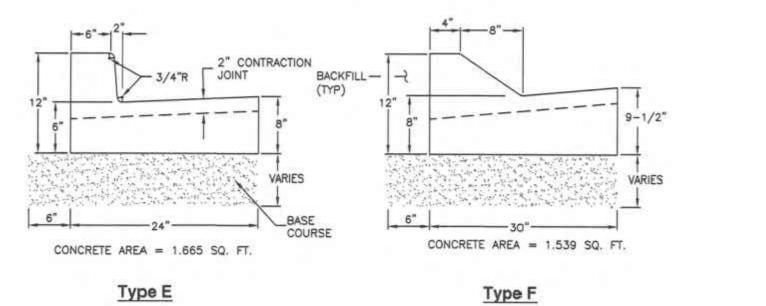

BACKFILL BEHIND CURB BEFORE PAVING AGAINST LIP OF GUTTER

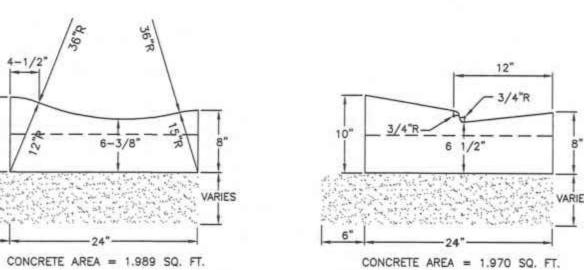


Type G Type H CONTRACTION 12' MAX

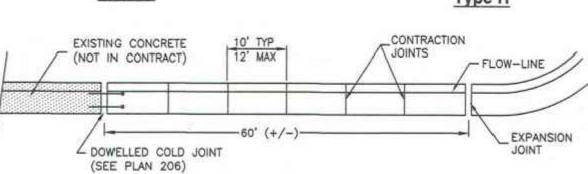


JOINT DETAIL



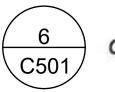


Curb and gutter



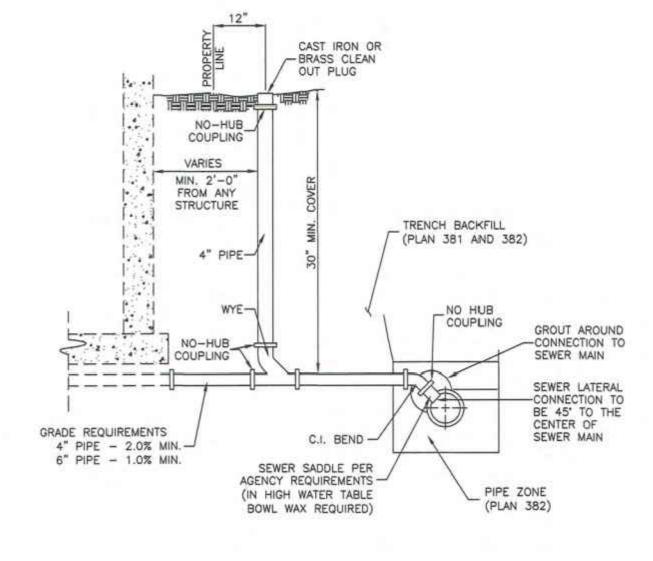







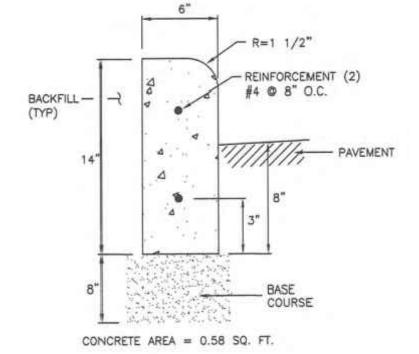

Type P

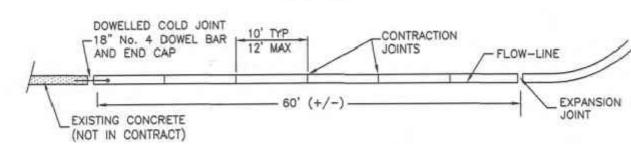

JOINT SPACING DETAIL

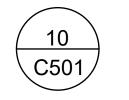

APWA TYPE P CURB NOT TO SCALE



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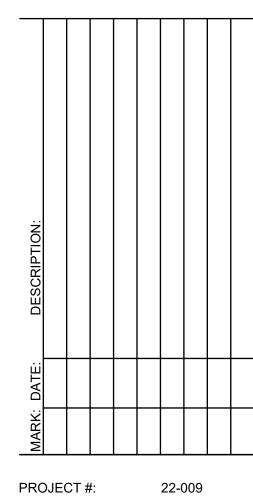
TMENTAIN STREET TAH 390 AP/ 390 SOUTH BOUNTIFUL

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**4** 



DRAWN BY: A. OCHSENBEIN

PROJECT MANAGER: W. SOUTHWICK ISSUED: 11/1/2022



**DETAILS** 

C501

C501

3' CONCRETE WATERWAY NOT TO SCALE

BASE COURSE


4" MIN PORTLAND CEMENT CONCRETE ~ VARIES (1' MAX) - SEE GRADING PLAN FOR SLOPES 6" MIN ROAD BASE COMPACTED ~ TO 95% MODIFIED PROCTOR CONCRETE AND ROAD BASE TO COMPLY WITH STANDARD DUTY CONCRETE DETAIL (1/C501)

THICKENED EDGE CONCRETE

NOT TO SCALE

-VARIES-

- DESIGNING OUR FUTURE -

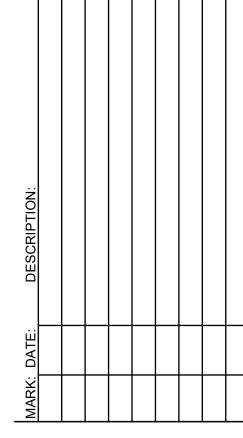


PROJECT #: 22-009 A. OCHSENBEIN DRAWN BY:

PROJECT MANAGER: W. SOUTHWICK ISSUED: 11/1/2022

**DETAILS** 

C502

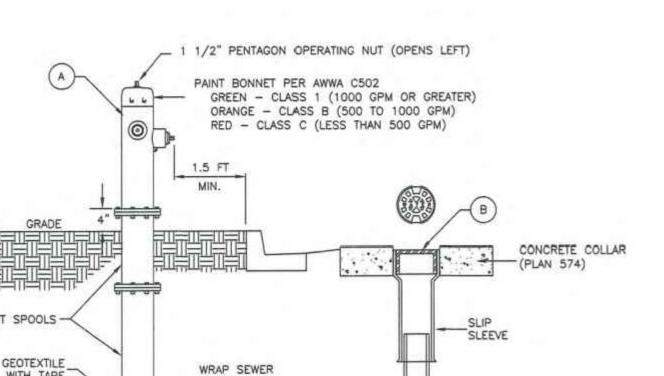


# PAINT SPOOLS -FASTEN GEOTEXTILE WRAP SEWER TO SPOOL WITH TAPE - ROCK IN GEOTEXTILE THRUST BLOCK DRAIN HOLES (PLAN 561) (LOCATIONS VARY) SEWER ROCK GREASE AND WHEN SPOOL LENGTH IS GREATER THAN 16 FEET, VERIFY WITH THRUST BLOCK AGENCY IF AN ADDITIONAL VALVE

	LEGEND				
No. * ITEM DESCRIF					
A		FIRE HYDRANT	AWWA C502		
B VALVE BOX WITH LID 2-		2-PIECE CAST IRON			
© GATE VALVE WITH 2" X 2" NUT AW		AWWA C509			
D TEE WITH 125 # FLANGE		TEE WITH 125 # FLANGE	AWWA C110		

IS REQUIRED AT THE HYDRANT





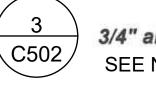

FURNISHED BY UTILITY AGENCY

ITEM

FRAME AND COVER

3/4" METER YOKE

1" METER YOKE

COPPER PIPE

METER BOX (B)-

CROSS-BAR REQUIRED -

(NOTE 3C)

3/4" and 1" meter SEE NOTE #1

FLARED JOINTS

METER BOX (18" TO 21" DIAMETER) CORRUGATED PE, PVC, CMP OR MATERIAL ACCEPTABLE TO AGENCY

SECTION

LEGEND

521 August 2001

-(A) FRAME AND COVER

C D YOKE

AROUND

DESCRIPTION

OPTIONAL BACKFLOW PROTECTION PER AGENCY REQUIREMENTS

OPTIONAL BACKFLOW PROTECTION

PER AGENCY REQUIREMENTS

CAST IRON COVER


TYPE K (SOFT)

BACKFILL ALL

DO NOT PLACE

ANY BACKFILL

IN METER BOX

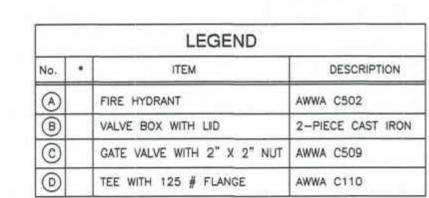


(PLAN 561)






\* FURNISHED BY UTILITY AGENCY

511 February 2011

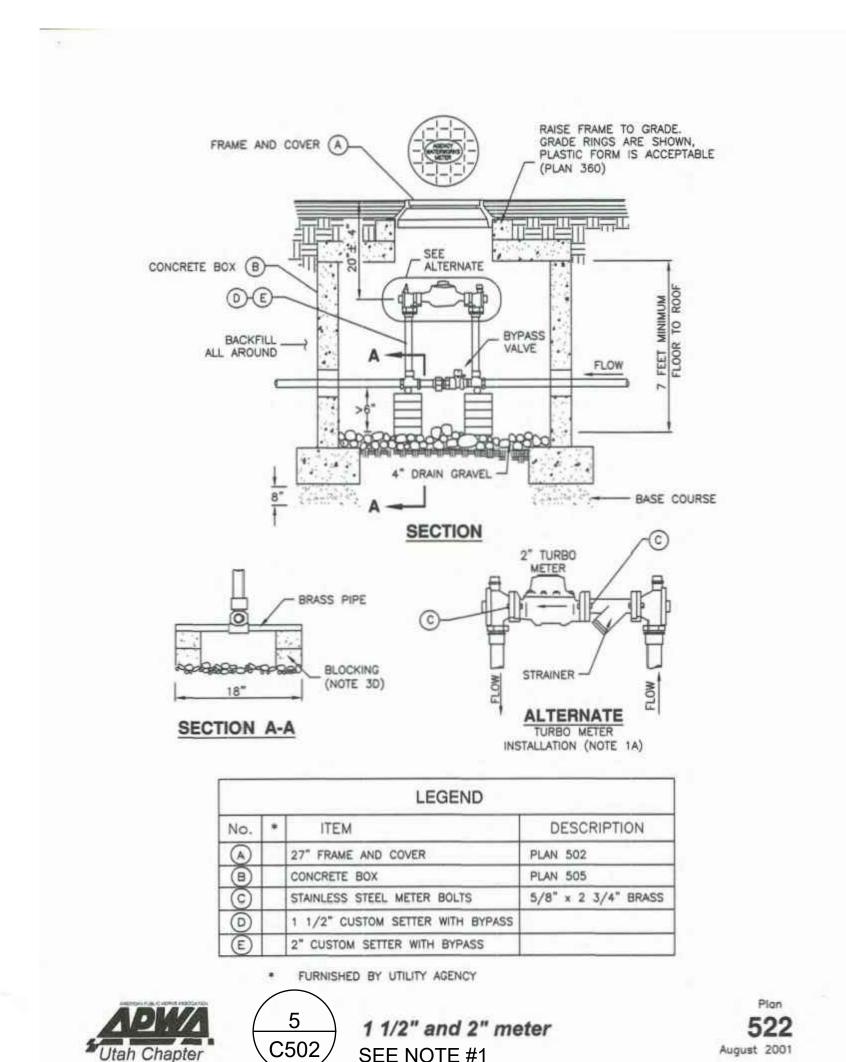

SEE NOTE #1

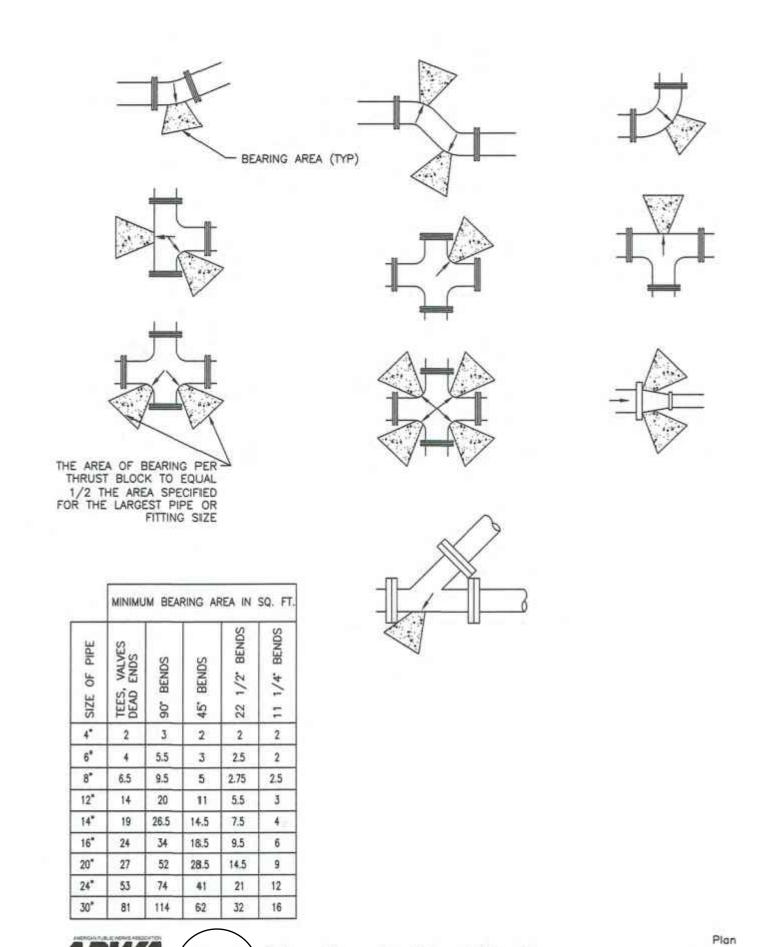


Direct bearing thrust block

NOTES:

1. TO BE FURNISHED AND INSTALLED BY BOUNTIFUL CITY WATER DEPARTMENT. COORDINATE WITH BOUNTIFUL CITY WATER DEPARTMENT.



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1'-0" FOR TRENCH DEPTH UNDER 4'-0"

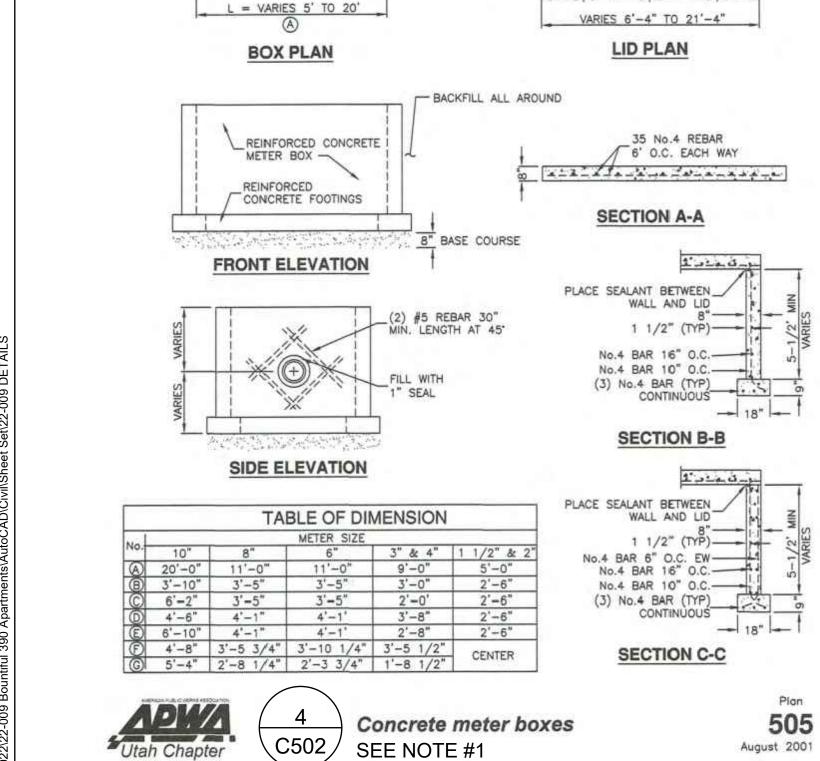SURFACE PAVING MATERIAL

CUT EXISTING

TACK OIL

ROAD BASE GRAVEL

PAVING MATERIAL

W/ BITUMINOUS PAVING

MECHANICALLY COMPACTED, DRY,

3/4" MAXIMUM, CRUSHED

COMPACTED, SUITABLE LOCAL

ROOTS OR OTHER DEBRIS

- HAND PLACED, COMPACTED, FINE

MATERIAL FREE FROM BROKEN PAVEMENT, STONES LARGER THAN 8" OR OTHER DEBRIS

1" DIA. HOLE WITH — REMOVABLE PLUG (TYP)

UNDISTURBED SOIL

TRENCHING DETAIL

EXCAVATED MATERIAL, FREE FROM

BROKEN PAVEMENT, LARGE STONES,

TO NEAT LINES

SAME AS EXISTING

PAVING MATERIAL

(BY CITY)

UTILITY PIPE

2'-0" FOR TRENCH DEPTH OVER 4'-0"

NOTES:

T. MATERIAL MUST BE REPLACED AND COMPACTED TO 95 % MODIFIED PROCTOR DENSITY.

CONTRACTOR TO IMMEDIATELY REMOVE

STREET EXCAVATION DETAIL

C502

- CONCRETE WALL

TERLESCONE CONTRACTOR

Carried Towns

BLOCK OUT A 1"

— CLEARANCE AROUND B

PROTURDING PIPE

- CONCRETE FOOTING

EXCESS MATERIAL.

BOUNTIFUL STANDARD


DESIGNING OUR FUTURE —

August 2001

561

August 2010

C502 SEE NOTE #1

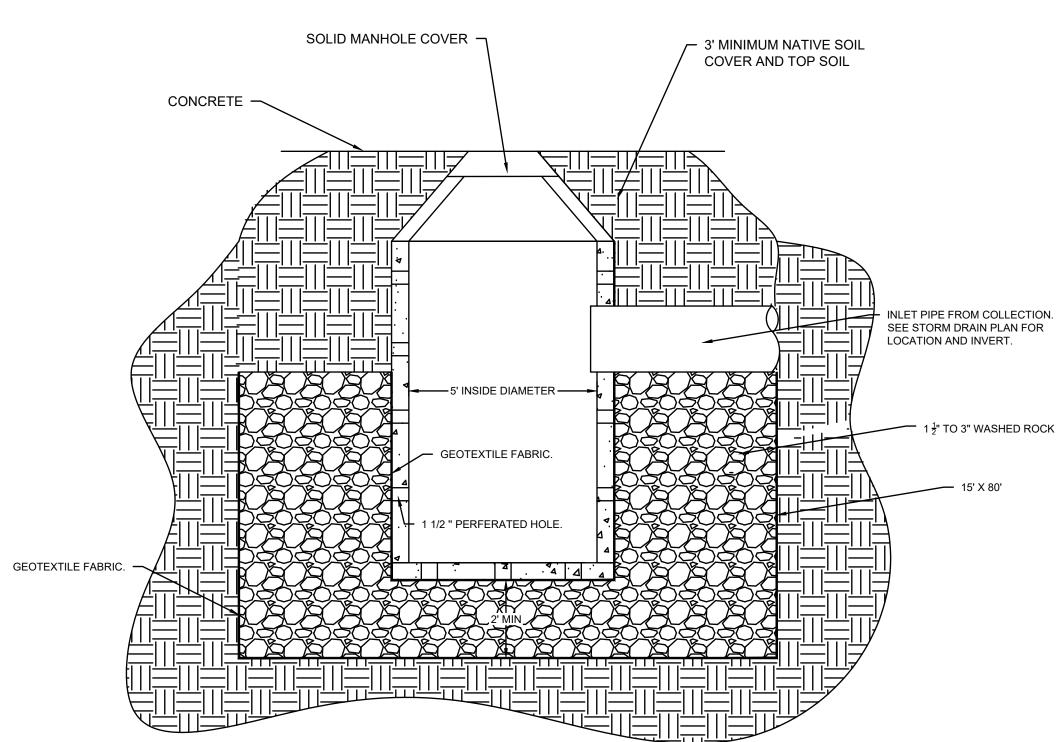

TOP SOIL

BOTTOM FLANGE OF

FRAME MUST BE

CONCRETE COLLAR

3130 VERONA AVE

BUFORD, GA 30518

PHN (770) 932-2443

FAX (770) 932-2490

DRAIN BASIN & INLINE DRAIN

TURF TRAFFIC INSTALLATION

7001-110-340

SUPPORTED BY

4 STORM DRAIN SUMP
NOT TO SCALE



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390 APARTMENTS
390 SOUTH MAIN STREET
BOUNTIFUL, UTAH

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PROJECT #: 22-009

PROJECT #: 22-009
DRAWN BY: A. OCHSENBEIN

PROJECT MANAGER: W. SOUTHWICK ISSUED: 11/1/2022

ISSUED: 11/1/2022



**DETAILS** 

C503

Utah Chapter C503 November 2010

341.2

SECTION B-B (REDUCING RISER OPTION)

Page 46 of 91

December 6, 2022 Bountiful City Planning Commission

RISERS: ON BOXES DEEPER THAN 4 FEET, PROVIDE AN UNREINFORCED PRECAST CONCRETE RISER MATCHING THE DRAINAGE

OBLIQUE

TABLE OF DIMENSIONS

36"

NOTE: OTHER BOX SIZES (LESS

THAN 48") WITH DIFFERENT a AND b DIMENSIONS ARE ACCEPTABLE

REINFORCING STEEL LAYOUT

PROVIDE 2" MIN. COVER ON ALL BARS

12"

TABLE OF DIMENSIONS

DIMENSION

C ⊗=60" ⊕=30"

BREAK OUT AND GROUT

MANHOLE

STYLE

REDUCING RISER

332

June 2010

BOX SIZE

2 x 2

2 x 3

3 x 3

2.5 x 4

3 x 3.5

4 x 4

Precast box

PIPE PASS THROUGH BASE

(SECTION B-B)

A NOTE: INVERT CONNECTION
SHOWN IS NOT APPLICABLE IF
LATERAL INVERT DOES NOT
COINCIDE WITH MAIN INVERT

CONCENTRIC CONE INSTALLATION UNLESS SPECIFIED OTHERWISE.

6" INCHES MINIMUM - MEASURED ON THE INSIDE

OF THE MANHOLE (TYP)

FLOW

USE APPROPRIATE
- FRAME AND COVER

BASE

SECTION A-A (CONCRETE DECK OPTION)

COVER COLLAR

(PLAN 352)

(PLAN 302 OR 303)

RAISE FRAME

(PLAN 345)

ASTM C 478

CONCRETE COLLAR
ALL AROUND (TYP)

Precast manhole

- BACKFILL

TO GRADE

(PLAN 360)

SECTION A-A

**SECTION B-B** 

CONNECT RISER TO BASE WITH JOINT SEALANT RISER HEIGHT

# DESIGNING OUR FUTURE ———

PROJECT #: DRAWN BY: REVIEWED BY: ISSUED: 11.01.2022

LANDSCAPE PLAN

L101

	1 TYP 7	LIMIT LINE 1	
5	10	9	
TYP 4	PROPOSED BUILDING	8	
6 FIMILTIME	TYP 10		MAIN STREET
CONSTRUCTED 6.111 SOLID FENC ED WITHIN 20	PROPOSED 1		
TYP 1		2	
OLND			
ents/AutoCAD/Landscape/Sheet Set/22-009 LND		NUMBER Indscape area 2 Indscape area 3 Indscap	5 6 66 3 O SF X 8 UNITS = 1,695 SF 3934 SF

# PLANT SCHEDULE CODE QTY BOTANICAL / COMMON NAME SIZE CAL ACER PLATANOIDES `CRIMSON SENTRY` / CRIMSON SENTRY MAPLE MALUS X `ROYALTY` / ROYALTY CRABAPPLE B&B 2"CAL CONT HEIGHT CODE QTY BOTANICAL / COMMON NAME BUXUS MICROPHYLLA 'WINTER GEM' / GLOBE WINTER GEM BOXWOOD 5 GAL. CORNUS ALBA `BAILHALO` TM / IVORY HALO DOGWOOD 5 GAL. 5 GAL. JUNIPERUS COMMUNIS `ALPINE CARPET` / JUNIPER RHAMNUS FRANGULA 'FINE LINE' / FINE LINE BUCKTHORN ROSA X `MEICOUBLAN` / WHITE MEIDILAND 5 GAL. PERENNIALS AND GRASSES CODE QTY BOTANICAL / COMMON NAME 12 CALAMAGROSTIS X ACUTIFLORA `KARL FOERSTER` / FEATHER REED GRASS 1 GAL. £#3 DIANTHUS GRATIANOPOLITANUS 'FIREWITCH' / FIREWITCH CHEDDAR PINK 3.4× 1 GAL. PH 30 PENNISETUM ALOPECUROIDES `HAMELN` / HAMELN FOUNTAIN GRASS

# REFERENCE NOTES SCHEDULE

SYMBOL	DESCRIPTION	<u>QTY</u>	DETAIL
1	CONCRETE MOWSTRIP: 6" WIDE- SEE DETAIL		5/L201
2	10' X 10' SIGHT TRIANGLE AT DRIVEWAY INTERSECTION		
3	METER FOR IRRIGATION SYSTEM. SEE CIVIL PLANS FOR EXACT SIZE AND LOCATION. IRRIGATION PLAN BY OTHERS.		
4	EXISTING LARGE SHRUBS AND OTHER VEGETATION TO BE REMOVED ALONG WEST SIDE OF PROPERTY.		
5	EXISTING FLOWERING PEAR TREE TO BE REMOVED.		
6	EXISTING 6' VINYL FENCE TO REMAIN.		
7	EXISTING 6` CHAIN LINK FENCE WITH SLATS TO REMAIN.		
8	PARCEL LINE		
9	OUT OF SCOPE FOR THIS PROJECT		
10	4" CONCRETE OVER 4" COMPACTED BASE COURSE		
SYMBOL	DESCRIPTION	QTY	DETAIL
\( \psi \)	TURF GRASS: SOD (IMPERIAL BLUE FROM CHANSHARE SOD OR APPROVED EQUAL) INSTALLED OVER 5" TOPSOIL LAYER.	431 SF	5/L201
	BARK MULCH (SMALL BARK MULCH FROM MILLER COMPANIES LC OR APPROVED EQUAL) INSTALLED AT DEPTH OF 3" WITHOUT WEED BARRIER FABRIC. PLANTINGS WITHIN THIS AREA WILL INCLUDE TREES, SHRUBS, GRASSES AND PERENNIALS.	1,067 SF	5/L201
	ROCK MULCH, 1" (WASATCH TAN CRUSHED ROCK FROM STAKER PARSON OR APPROVED EQUAL) INSTALLED AT DEPTH OF 3" INSTALLED OVER DEWITT PRO 5 BARRIER FABRIC.	2,436 SF	5/L201


**GENERAL NOTES:** 

CONTRACTOR TO VERIFY ALL QUANTITIES. 2. SEE L201 FOR PLANTING NOTES AND DETAILS.

**IRRIGATION NOTES:** 

1. LANDSCAPE TO BE WATERED WITH AUTOMATIC IRRIGATION SYSTEM. 2. IRRIGATION PLAN BY OTHERS. PROVIDE SLEEVES UNDER DRIVEWAYS TO

PLANTING ISLANDS AS NEEDED.

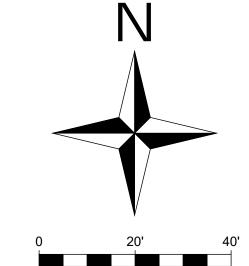

THESE PLANS AND SPECIFICATIONS ARE THE PROPERTY OF CIVIL SOLUTIONS GROUP, INC, AN SHALL NOT BE PHOTOCOPIED, RE-DRAWN, OR USED ON ANY OTHER PROJECT OTHER THAN THE PROJECT SPECIFICALLY DESIGNED FOR, WITHOUT WRITTEN PERMISSION. THE OWNERS AND ENGINEERS OF CIVIL SOLUTIONS GROUP, INC. DISCLAIM ANY LIABILITY FOR ANY CHANGES OR MODIFICATIONS MADE TO THESE PLANS OR THE DESIGN THEREON WITHOUT THEIR CONSENT. THESE PLANS ARE DRAWN TO SCALE WHEN PLOTTED ON A 24" X 36" SHEET OF PAPER. THESE PLANS ARE PRODUCED IN COLOR AND SHOULD BE PLOTTED AS SUCH.

# GENERAL NOTES:

- 1. THE CONTRACTOR SHALL LOCATE AND VERIFY ALL EXISTING UTILITY LINES PRIOR TO ANY SITE WORK, IRRIGATION AND LANDSCAPE WORK; CONTRACTOR SHALL REPORT ANY CONFLICTS TO THE OWNERS REPRESENTATIVE.
- 2. THE CONTRACTOR(S) AND SUBCONTRACTORS ARE 100% RESPONSIBLE FOR ANY DAMAGE OCCURRED BY CONTRACTOR/SUBCONTRACTORS TO BUILDINGS, VEHICLES, TREES, SIDEWALKS, CURBS, DRIVES, UTILITIES AND ALL PROPERTY OF THE OWNER. IF ANY DAMAGE OCCURS TO THE OWNER'S BUILDINGS, SITE, LANDSCAPE, AND PROPERTY THE CONTRACTOR MUST REPORT IT IMMEDIATELY AND WORK OUT A SOLUTION WITH OWNER'S
- 3. TIME IS OF THE ESSENCE AND THE OWNER IS RELYING ON THE LANDSCAPING TO BE COMPLETED IN A PROFESSIONAL AND TIMELY MANNER.
- 4. CONTRACTOR IS TO REVIEW PLANS, VERIFY SITE CONDITIONS AND PLANT QUANTITIES PRIOR TO INSTALLATION. CONFLICTS BETWEEN THE SITE AND THESE PLANS OR WITHIN THESE PLANS SHALL BE BROUGHT TO THE ATTENTION OF THE OWNER'S AUTHORIZED REPRESENTATIVE PRIOR TO LANDSCAPE INSTALLATION. ANY DEVIATION FROM THE PLANS OR SPECIFICATIONS MUST HAVE WRITTEN APPROVAL FROM THE OWNER'S REPRESENTATIVE.

# PLANTING NOTES

- 5. THE PLANTING PLAN IS DIAGRAMMATIC, AND PLANT LOCATIONS ARE APPROXIMATE. IF NECESSARY ADJUST PLANTING LOCATION TO ACCOMMODATE UTILITIES AND OTHER UN-FORESEEN OBSTACLES
- 6. PLANT SYMBOLS TAKE PRECEDENCE OVER PLANT QUANTITIES SPECIFIED ON PLANT SCHEDULE 7. THE CONTRACTOR SHALL VERIFY PLANT QUANTITIES AND NOTIFY THE LANDSCAPE ARCHITECT OF ANY DISCREPANCIES BETWEEN QUANTITIES AND SYMBOLS SHOWN.
- 8. ANY PROPOSED SUBSTITUTIONS OF PLANT SPECIES SHALL BE MADE WITH PLANTS OF EQUIVALENT OVERALL FORM, HEIGHT, BRANCHING HABIT, FLOWER, LEAF, COLOR, FRUIT, SOLAR NEEDS, WATER NEEDS, AND CULTURE ONLY AS APPROVED BY THE OWNER'S REP.
- 9. PRIOR TO PLANTING, THE IRRIGATION SYSTEM SHALL BE FULLY OPERATIONAL AND ALL PLANTING AREAS SHALL BE MOISTENED BEFORE PLANTINGS.
- 10. ALL GRASS SEED AREAS SHALL RECEIVE A MINIMUM OF SIX [6] INCHES OF IMPORTED TOPSOIL AND TEN (10) INCHES IN PLANTING BEDS. ALL TOPSOIL USED ON THIS PROJECT SHALL MEET THE FOLLOWING CRITERIA:
- 10.1. pH: 5.5 8.0 10.2. MINIMUM 1% PERCENT ORGANIC MATTER)
- 10.3. TEXTURE (PARTICLE SIZE PER USDA SOIL CLASSIFICATION): SAND: <70%, CLAY: <30% 10.4. SILT: = BALANCE
- 10.5. STONE FRAGMENTS (GRAVELS OR ANY SOIL PARTICLE GREATER THAN 2 MM IN SIZE): <5% (BY VOLUME)
- 11. IN ADDITION, THE SOIL SHALL BE FERTILE, FRIABLE, NATURAL LOAM AND SHALL BE CAPABLE OF SUSTAINING VIGOROUS PLANT GROWTH. IT SHALL BE FREE OF STONES, LUMPS, CLODS OF HARD EARTH, PLANTS OR THEIR ROOTS, STICKS AND OTHER EXTRANEOUS MATTER. THE SOIL SHALL CONTAIN NO NOXIOUS WEEDS NOR THEIR SEEDS. IT SHALL NOT BE USED FOR PLANTING OPERATIONS WHILE IN A FROZEN OR MUDDY CONDITION.
- 12. THE FOLLOWING PROCEDURES SHALL BE FOLLOWED IN PLACING ALL TOPSOIL
- 12.1. SUB-GRADE MATERIAL SHALL BE ROUGH GRADED TO PLUS OR MINUS 0.1 FEET OF A FINAL ROUGH GRADE WHICH WILL ALLOW THE CONTRACTOR TO ACHIEVE FINAL FINISH GRADE THROUGH THE INSTALLATION OF IMPORTED TOPSOIL
- 12.2. SCARIFY SURFACE OF SUB-GRADE TO A TWO (2) INCH DEPTH TO PROVIDE TRANSITION ZONE BETWEEN SUB-GRADE AND TOPSOIL. PLACE TOPSOIL ON SUB-GRADE AND FINE GRADE TO FINAL FINISH GRADE AND TOPSOIL DEPTHS AS INDICATED ON THE DRAWINGS AND IN THESE
- 12.3. FINISH GRADE TO BE 1" BELOW TOP OF CURB OR WALK FOR TURF AREAS, 2" FOR PLANTER
- 12.4. LANDSCAPE CONTRACTOR SHALL MAINTAIN A MINIMUM 3% DRAINAGE AWAY FROM ALL BUILDINGS, STRUCTURES, AND WALLS. FINISHED GRADES SHALL BE SMOOTHED TO ELIMINATE STANDING WATER, UNLESS SPECIFIED ON GRADING PLAN (SEE CIVIL SET).
- 12.5. ALL FINISHED GRADES SHALL BE APPROVED BY THE OWNER/OWNER'S AUTHORIZED REPRESENTATIVE PRIOR TO INSTALLATION OF ANY PLANT MATERIALS.
- 13. CONTRACTOR SHALL HAVE THE OWNER'S REP. APPROVE PLANT MATERIAL SIZE AND QUALITY PRIOR TO INSTALLATION. ANY PLANTS WHICH ARE NOT TRUE TO FORM, APPEAR STRESSED OR UNHEALTHY, INFESTED WITH PESTS, OR UNDERSIZED FOR THEIR CONTAINERS SHALL BE
- 14. PLANT MATERIAL SHALL NOT BE ROOT BOUND. THREE (3) GALLON PLANTS AND LARGER SHALL HAVE BEEN GROWN IN CONTAINERS FOR A MINIMUM OF SIX [6] MONTHS UP TO A MAXIMUM OF TWO (2) YEARS. PLANTS SHALL EXHIBIT HEALTHY GROWTH AND BE FREE OF DISEASES AND PESTS. BARE ROOT MAY BE USED WHEN APPROVED BY OWNER'S REP.
- 15. ALL TREES SHALL BE 2" CALIPER SIZE MEASURED 12" ABOVE THE GROUND.
- 16. PLANTS SHALL NOT BE PLACED WITHIN TWELVE [12] INCHES OF SPRINKLER HEADS. 17. PLANTING PROCEDURES FOR ALL PLANT MATERIALS, ESPECIALLY TREES, SHALL BE AS
- 17.1. DIG PLANTING HOLE THREE (3) TIMES THE WIDTH OF THE ROOT BALL, AND SAME DEPTH AS THE ROOT BALL DEPTH. SIDES OF HOLE SHOULD BE ROUGHENED AND NOT SMOOTH OR
- 17.2. FOR CONTAINER PLANTS, REMOVE CONTAINER AND PLACE ROOT BALL IN CENTER OF HOLE, WITH ROOT BALL RESTING ON UNDISTURBED SOIL. ROOT CROWN OR COLLAR SHALL BE AT
- OR JUST ABOVE FINISHED GRADE. 17.3. FOR BALLED AND BURLAP PLANTS, PLACE ROOT BALL IN CENTER OF HOLE AND RESTING ON UNDISTURBED GROUND. CUT AND REMOVE WIRE BASKET AND BURLAP OR OTHER WRAPPING MATERIAL FROM ROOT BALL THIS MAY BE DONE WITH ROOT BALL IN HOLE. BURLAP OR WIRE PIECES UNDERNEATH THE ROOT BALL MAY BE LEFT IF THEY CANNOT BE REMOVED. DO NOT FOLD BURLAP OVER, BUT CUT AWAY AS MUCH AS POSSIBLE WITHOUT DISTURBING ROOT BALL. BACKFILL BOTTOM THIRD (1/3) OF HOLE AS WIRE AND BURLAP
- 17.4. PLACE PLANT IN THE HOLE AND BACKFILL TO HALFWAY POINT AND PLACE AGRIFORM PLANTING TABLETS IN THE HOLE ABOUT 1-2 INCHES AWAY FROM THE ROOT TIPS. DO NOT PLACE TABLETS IN THE BOTTOM OF THE PLANTING HOLE. SEE DETAIL AND CHART FOR SUGGESTED APPLICATION RATES.
- 17.5. FINISH FILLING THE HOLE AROUND THE PLANT TO GRADE LEVEL
- 17.6. THOROUGHLY WATER PLANT, THEN COMPLETE BACKFILLING THE HOLE. FORM A WATERING BASIN AROUND THE PLANT AND THOROUGHLY WATER AGAIN.
- 18. MONITOR ALL PLANTS TO INSURE THAT NO SETTLING OCCURS.
- 19. THE LANDSCAPE CONTRACTOR SHALL LEAVE SITE IN A CLEAN CONDITION, REMOVING ALL
- UNUSED MATERIAL, TRASH AND TOOLS. 20. AT SUBSTANTIAL COMPLETION OF ALL WORK OUTLINED IN THESE PLANS, THE LANDSCAPE CONTRACTOR SHALL CONTACT OWNER AND ARRANGE FOR A WALK THROUGH. SUBSTANTIAL
- COMPLETION SHALL BE DEFINED AS COMPLETION OF ALL WORK OUTLINED IN THE PLANS AND SPECIFICATIONS WITH THE EXCEPTION OF FINAL CLEAN UP AND DEMOBILIZATION. WORK MUST BE FULLY COMPLETED ACCORDING TO ALL PLANS, NOTES, AND SPECIFICATIONS AND EXHIBIT PROFESSIONAL WORKMANSHIP. A MAINTENANCE PERIOD WILL BEGIN ON THE DATE OF ACCEPTANCE OF SUBSTANTIAL COMPLETION BY OWNER.
- 21. LANDSCAPE CONTRACTOR TO PROVIDE DETAILED AS BUILT DRAWINGS TO OWNERS REPRESENTATIVE UPON COMPLETION OF LANDSCAPE PLANTING. THE DRAWING TO SHOW LOCATION OF: BUILDING, HARDSCAPES, AND ALL PLANT MATERIAL (TREES, SHRUBS, GRASSES, PERENNIALS AND OTHERS). THE AS-BUILT DRAWINGS MUST USE THE BOTANIC NAMES OF SPECIES INSTALLED. THE CONTRACTOR MUST REVIEW THE AS-BUILT DRAWINGS WITH OWNERS REPRESENTATIVE PRIOR TO COMPLETION OF PROJECT.
- 22. LANDSCAPE CONTRACTOR SHALL MAINTAIN ALL PLANTINGS UNTIL PROJECT COMPLETION AS DETERMINED BY THE OWNER'S REP. TURF SHALL BE CONSIDERED FULLY ESTABLISHED WHEN GRASS STANDS COME IN UNIFORM AND THICK, WITH NO BARE OR THIN SPOTS, AND ROOTS HAVE BEGUN TO SPREAD AND KNIT TOGETHER. NO WEEDS SHALL BE ALLOWED IN THE GRASS. THE MAINTENANCE WORK REQUIRED SHALL INCLUDE BUT NOT BE LIMITED TO THE FOLLOWING: 22.1. DAILY WATERING OF ALL PLANT MATERIAL
- 22.2. WEEDING AND REMOVAL OF ALL WEEDS FROM GROUND COVER AND PLANTING AREAS. 22.3. REPLACEMENT OF ANY DEAD, DYING, OR DAMAGED TREES, SHRUBS OR GROUNDCOVER. 22.4. FILLING AND REPLANTING OF ANY LOW AREAS WHICH MAY CAUSE STANDING WATER. 22.5. ADJUSTING OF SPRINKLER HEAD HEIGHTS AND WATERING PATTERNS.
- 22.6. FILLING AND RE-COMPACTION OF ERODED AREAS. ALONG WITH ANY REQUIRED RE-SEEDING AND/OR RE-PLANTING. 22.7. GRASS SHALL BE MOWED WHEN BLADES REACH THREE (3) INCHES TALL. NO MORE THAN
- ONE THIRD (1/3) OF THE BLADE SHALL BE REMOVED PER CUTTING. CUTTING FREQUENCY SHALL BE ONCE EVERY FIVE (5) TO SEVEN (7) DAYS.
- 22.8. WEEKLY REMOVAL OF ALL TRASH, LITTER, CLIPPINGS AND ALL FOREIGN DEBRIS.

December 6, 2022 Bountiful City Planning Commission

- 23. CONTRACTOR TO FERTILIZE TREES, SHRUBS, PERENNIALS AND GRASSES WITH MILLERS A TO Z MIX ACCORDING TO MANUFACTURER'S RECOMMENDATIONS.
- 24. PLANT QUALITY AT OR BELOW THE SOIL LINE:

SIDE OF THE TRUNK (J ROOTS) SHALL BE REJECTED.

- 24.1. A MINIMUM OF THREE STRUCTURAL ROOTS REASONABLY DISTRIBUTED AROUND THE TRUNK SHALL BE FOUND IN EACH PLANT. PLANTS WITH STRUCTURAL ROOTS ON ONLY ONE
- 24.2. THE ROOT CROWN MUST NOT BE MORE THAN TWO INCHES BELOW THE SOIL LINE. THE TOP TWO STRUCTURAL ROOTS SHALL BE NO MORE THAN TREE INCHES BELOW THE SOIL LINE WHEN MEASURED FOUR INCHES RADIAL TO THE TRUNK. THE TOP OF THE OTHER STRUCTURAL ROOT SHALL BE NO GREATER THAN FIVE INCHES BELOW THE SOIL LINE WHEN MEASURED FOUR INCHES RADIAL TO THE TRUNK. THE GROWER MAY REQUEST A MODIFICATION TO THIS REQUIREMENT FOR SPECIES WITH ROOTS THAT RAPIDLY DESCEND, PROVIDED THAT THE GROWER REMOVES ALL CIRCLING ROOTS ABOVE THE STRUCTURAL ROOTS ACROSS THE TOP OF THE STRUCTURAL ROOTS.
- 24.3. THE ROOT SYSTEM SHALL BE REASONABLY FREE OF ROOT DEFECTS INCLUDING POTENTIALLY STEM-GIRDLING ROOTS ABOVE THE ROOT COLLAR AND MAIN STRUCTURAL ROOTS, VERTICAL ROOTS, AND/OR KINKED ROOTS FROM NURSERY PRODUCTION PRACTICES, INCLUDING
- ROOTS ON THE INTERIOR OF THE ROOT BALL 24.3.1.REASONABLE AND REASONABLY - WHEN USED IN THIS SPECIFICATION RELATIVE TO PLANT QUALITY - ARE INTENDED TO MEAN THAT THE CONDITIONS CITED WILL NOT AFFECT THE ESTABLISHMENT OR LONG-TERM STABILITY, HEALTH, OR GROWTH OF THE PLANT. THIS SPECIFICATION RECOGNIZES THAT IT IS NOT POSSIBLE TO PRODUCE PLANTS FREE OF ALL DEFECTS AND THAT SOME DECISIONS CANNOT BE TOTALLY BASED ON MEASURED FINDINGS, SO PROFESSIONAL JUDGEMENT IS REQUIRED. IN CASES OF DIFFERING OPINION. THE LANDSCAPE ARCHITECT SHALL DETERMINE WHEN CONDITIONS WITHIN THE PLANT ARE JUDGED AS REASONABLE.
- 24.3.2.THE FINAL PLANT GROWER SHALL BE RESPONSIBLE FOR CERTIFYING THAT THE PLANTS HAVE BEEN ROOT PRUNED AT EACH STEP IN THE PLANT PRODUCTION PROCESS TO REMOVE STEM-GIRDLING ROOTS AND KINKED ROOTS, OR SHALL ENSURE THAT THE PREVIOUS LINER PRODUCTION SYSTEM USED OTHER PRACTICES THAT PRODUCE A ROOT SYSTEM THROUGHOUT THE ROOT BALL THAT MEETS THESE SPECIFICATIONS. REGARDLESS OF THE WORK OF PREVIOUS GROWERS, THE PLANT'S ROOT SYSTEM SHALL BE MODIFIED AT THE FINAL PRODUCTIONS STAGE TO PRODUCE THE REQUIRED PLANT ROOT QUALITY. THE FINAL GROWER SHALL CERTIFY IN WRITING THAT ALL PLANTS ARE REASONABLY FREE OF ROOT DEFECTS AS DEFINED IN THIS SPECIFICATION AND THAT THE TREE HAS BEEN GROWN AND HARVESTED TO PRODUCE A PLANT THAT MEETS THESE SPECIFICATIONS.
- 24.4. ALL PLANTS MAY BE INSPECTED AT THE SUPPLIER'S NURSERY. THE LANDSCAPE ARCHITECT MAY MAKE INVASIVE INSPECTION OF THE ROOT BALL AS NEEDED TO VERIFY THAT PLANTS MEET THE REQUIREMENTS. INSPECTIONS OF CONTAINER TREES MAY REQUIRE RANDOM CUTTING INTO THE INTERIOR ROOT BALL OF UP TO 2 PERCENT BUT NOT FEWER THAN TWO TREES OF EACH TYPE OF TREE IN A CONTAINER AT EACH SOURCE NURSERY. SUCH CUTTING AND INSPECTION MAY RENDER THE CONTAINER TREE UNSUITABLE FOR PLANTING. FINDINGS OF THE ROOT INSPECTIONS SHALL BE CONSIDERED AS REPRESENTATIVE OF ALL TREES OF THAT TYPE FROM THAT SOURCE.
- 24.5. CONTAINER-GROWN PLANTS, IN ADDITION TO THE ABOVE REQUIREMENTS, SHOULD COMPLY WITH THE FOLLOWING:
- 24.5.1.1.CONTAINER-GROWN PLANTS MAY BE PERMITTED ONLY WHEN INDICATED ON THE DRAWING OR THIS SPECIFICATION.
- 24.5.2.CONTAINER-GROWN STOCK SHALL HAVE BEEN GROWN IN A CONTAINER LONG ENOUGH FOR THE ROOT SYSTEM TO HAVE DEVELOPED
- 24.6. SUFFICIENTLY TO HOLD ITS POTTING MEDIUM TOGETHER BUT NOT SO LONG AS TO HAVE DEVELOPED ROOTS THAT ARE MATTED OR CIRCLING AROUND THE EDGE OR INTERIOR OF THE ROOT MASS. PLANTS SHALL HAVE BEEN ROOT PRUNED AT EACH CHANGE IN CONTAINER
- 24.6.1.PLANTS THAT FAIL TO MEET ANY OF THE ABOVE REQUIREMENTS SHALL BE MODIFIED TO CORRECT DEFICIENCIES IF APPROVED BY THE LANDSCAPE ARCHITECT. MODIFICATION SHALL INCLUDE THE FOLLOWING:
- 24.6.1.1.SHAVING ALL CIRCLING ROOTS ON THE EXTERIOR OF THE ROOT MASS DEEP ENOUGH SO THAT ALL CUT ROOTS ENDS ARE ROUGHLY RADIAL TO THE TRUNK.
- 24.6.1.2.REMOVAL OF ALL ROOTS ABOVE THE TOP OF THE MAIN STRUCTURAL ROOTS AND TRUNK FLARE INCLUDE ANY ROOTS THAT ARE IMPRINTS FROM PREVIOUS SMALLER
  - (THE ABOVE MODIFICATIONS SHALL NOT BE CAUSE TO ALTER THE WARRANTY PROVISIONS OF THIS SPECIFICATION.)

- 31. LANDSCAPE CONTRACTOR TO PROVIDE BID TO STAKE UP TO 50% OF TREES.
- 32. THE OWNER/OWNERS REPRESENTATIVE SHALL HAVE THE AUTHORITY TO REQUIRE THAT TREES ARE STAKED OR TO REJECT STAKING AS AN ALTERNATIVE WAY TO STABILIZE THE TREE. 33. TREES THAT REQUIRE HEAVILY MODIFIED ROOT BALLS TO MEET THE ROOT QUALITY STANDARDS MAY BECOME UNSTABLE. THE OWNER/OWNERS REP MAY CHOOSE TO REJECT THESE TREES
- RATHER THAN UTILIZE STAKING TO TEMPORARILY SUPPORT THE TREE. 34. STAKES SHALL BE LODGE POLE STAKES FREE OF KNOTS AND OF DIAMETERS AND LENGTHS APPROPRIATE TO THE SIZE OF PLANT AS REQUIRED TO ADEQUATELY SUPPORT THE PLANT.
- 35. PLANTS SHALL STAND PLUMB AFTER STAKING REMOVE TREE STAKING AFTER THE FIRST FULL GROWING SEASON UNLESS DIRECTED BY THE OWNER/OWNERS REP.

# MULCH:

- 36. ALL PLANTER BEDS ARE TO RECEIVE ROCK MULCH AS SPECIFIED ON PLANS OR APPROVED
- EQUAL BY OWNER'S REP.
- 37. PRIOR TO PLACEMENT OF WEED FABRIC, TREAT AREAS WITH PRE-EMERGENT 38. HERBICIDE ACCORDING TO MANUFACTURERS RECOMMENDATIONS.

# WEED FABRIC:

39. AREAS TO RECEIVE WEED BARRIER FABRIC INCLUDE PLANTER BEDS WITH ROCK MULCH. CONTRACTOR TO INSTALL DEWITT PRO 5 WEED FABRIC. CONTRACTOR TO INSTALL WEED BARRIER PER MANUFACTURERS RECOMMENDATIONS INCLUDING THE USE OF STAPLES AS OFTEN AS RECOMMENDED.

# MAINTENANCE & WARRANTIES:

- 40. THE CONTRACTOR IS RESPONSIBLE FOR MAINTENANCE OF THE TREES, PLANTER BEDS (INCLUDING WEEDING), SHRUB PRUNING, WATERING THE PLANTS AND IRRIGATION SYSTEM FOR THE DURATION OF THE CONSTRUCTION PERIOD.
- 41. THE LANDSCAPE CONTRACTOR IS RESPONSIBLE FOR MAINTENANCE OF LANDSCAPE FOR 90 DAYS PAST THE FINAL INSPECTION. THE MAINTENANCE IS TO INCLUDE: WEEDING PLANTER BED AREAS, SPRAYING THE SOD AREAS FOR WEEDS AND FERTILIZATION (1 APPLICATION AFTER INITIAL APPLICATION), MOWING, TRIMMING, AND IRRIGATION REPAIRS.
- 42. ALL SHRUBS AND GROUND COVERS SHALL BE GUARANTEED BY THE CONTRACTOR AS TO GROWTH AND HEALTH FOR A PERIOD OF ONE (1) YEAR AFTER COMPLETION OF THE MAINTENANCE PERIOD AND FINAL ACCEPTANCE. ALL TREES SHALL BE GUARANTEED BY THE CONTRACTOR TO LIVE AND GROW IN AN ACCEPTABLE UPRIGHT POSITION FOR A PERIOD OF ONE (1) YEAR AFTER COMPLETION OF THE SPECIFIED MAINTENANCE PERIOD AND FINAL
- 43. THE ONLY CONDITIONS WHICH RELIEVE THE CONTRACTOR FROM THE GUARANTEE OF PLANT MATERIALS AS DESCRIBED ABOVE ARE THOSE WHICH CAN BE SHOWN ARE A DIRECT RESULT OF IMPROPER CARE OR WATERING BY THE OWNER AFTER THE MAINTENANCE PERIOD AND DURING THE GUARANTEE PERIOD.
- 44. THE CONTRACTOR, WITHIN FIFTEEN (15) DAYS AFTER RECEIVING WRITTEN NOTIFICATION BY THE OWNERS REP., SHALL REMOVE AND REPLACE ALL GUARANTEED PLANT MATERIALS WHICH FAIL TO MEET THE REQUIREMENTS OF THE GUARANTEE. REPLACEMENT SHALL BE MADE WITH PLANT MATERIALS AS INDICATED OR SPECIFIED ON THE ORIGINAL PLANS, AND ALL SUCH REPLACEMENT MATERIALS SHALL BE GUARANTEED AS SPECIFIED FOR THE ORIGINAL MATERIALS.

# AGRIFORM® 20-10-5 PLANTING TABLETS PLUS MINORS

	SUGGE	STED APP	LICATION	RATES		
Agrif	orm <b>e</b> 21-g (*availat	m Tablets ole in Can	(SKU# E9 ada SKU#	002 <i>6</i> *, G9 E98355)	00 26)	
		Tree / 9	hrub Cont	ainer Size		
1 gal	2 gal	3 gal	S gal	7 gal	15 gal	24" box
1	1 to 2	2 to 3	2 to 3	3 to 5	7 to 10	15 to 24
	Main	tenance R (Plant	ates for Est . Height or	ablished P Spread)	lantings	
18" or less	18-36"	36-54"	4.5-6 ft.	6-7.5 ft.	7.5-9 ft.	Each additional 18"
ា	1 to 2	2 to 3	3 to 4	4 to 5	5 to 6	add 1
2	2 to 4	4 to 6	6 to 8	8 to 10	10 to 12	add 1
Agrif Applica	orm <sup>e</sup> 10-g tion Rate fo	m Tablets r Well-Root	: (SKU# E9 ed Liners (Q	0805, G91 want togal	0805) on size)	
	1 to	2 tablets	for each pl	ant		
						ler)
	1	tablet for	each plan	t		
	1 gal  18" or less 1 2 Agrif Applica	Agriform® 21-g (*availab  1 gal	Agriform® 21-gm Tablets (*available in Can Tree / 5  1 gal	Agriform® 21-gm Tablets (SKU# E9 (*available in Canada SKU# Tree / Shrub Cont 1 gal 2 gal 3 gal 5 gal 1 1 to 2 2 to 3 2 to 3	(*available in Canada SKU# E98355)  Tree / Shrub Container Size  1 gal	Agriform® 21-gm Tablets (SKU# E90026*, G900 26)

Always refer to label instructions before application:

BID SPECIFICATIONS:

# TYPICAL TREE B&B PLANTING DETAIL

ROOT FLARE SHALL

BE 1-2" ABOVE FINISH

INCHES WAY FROM

SOIL SAUCER > 3 INCHES -

ARTER ROOT BALL I

PLACED IN

**PLANTING PIT** 

**BURLAP & WIRE** 

BASKET DOWN TO

THE BOTTOM OF THE

REMOVE ALL

**KEEP MULCH 4** 

GRADE

329343-03

ABOVE SOIL LINE

— SOIL LINE OF THE

EXCESS SOIL

TOP OF ROOT BAL

AFTER REMOVING

TO 2 INCHES

EXCAVATED HOLE

TO HAVE SIDES


SLOPED AT 45

DEGREE ANGLES

PLACE ROOT BALL

ON UNDISTURBED

PLANTING TABLET SHALL BE TIGHTLY COMPRESSED, LONG LASTING AND SLOW RELEASE. WEIGHTS OF 5, 10, AND 21 GRAMS WITH A NITROGEN (N), PHOSPHORUS (P), AND POTASSIUM (K) ANALYSIS OF 20-10-5 AND TRACE ELEMENTS DERIVED FROM THE SOURCES LISTED IN THE GUARANTEED ANALYSIS.

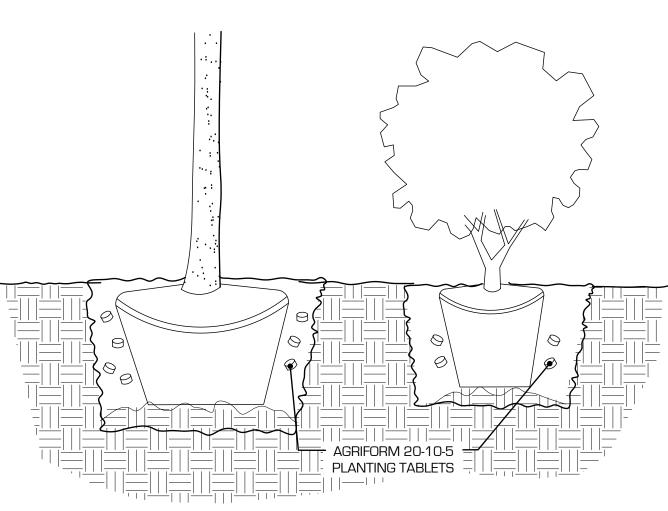


central leader needs to be stakes. straightened or held erect, it is acceptable to attach a 🙎 x 8' bamboo pole to the central leader and trunk. -- 32" long non - abrasıve rubber tıes. Two (2) three inch lodge pole pine stakes. Install approximately 2" away from the edge of the root ball. Stake location shall not interfere with permanent branches. SECTION VIEW

# AGRIFORM 20-10-5 PLANTING TABLETS

TREE DOUBLE STAKING

329343-06

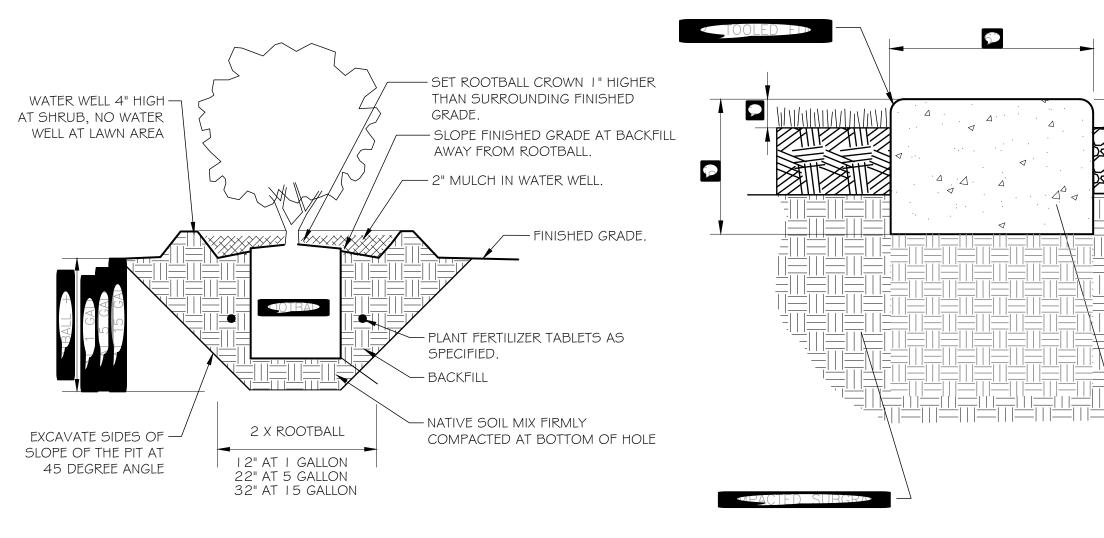

3293-01



329333.13-01

6"X6" CONCRETE MOW STRIP AT PLANTER EDGE


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329413.19-21


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22-009 DRAWN BY: REVIEWED BY: ISSUED: 11.01.2022




**DETAILS** 

DESIGNING OUR FUTURE
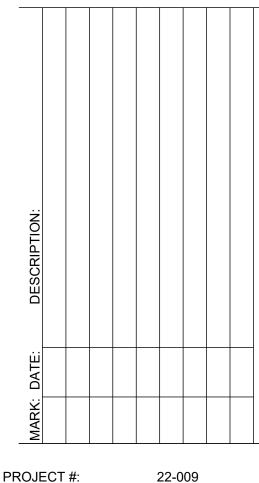
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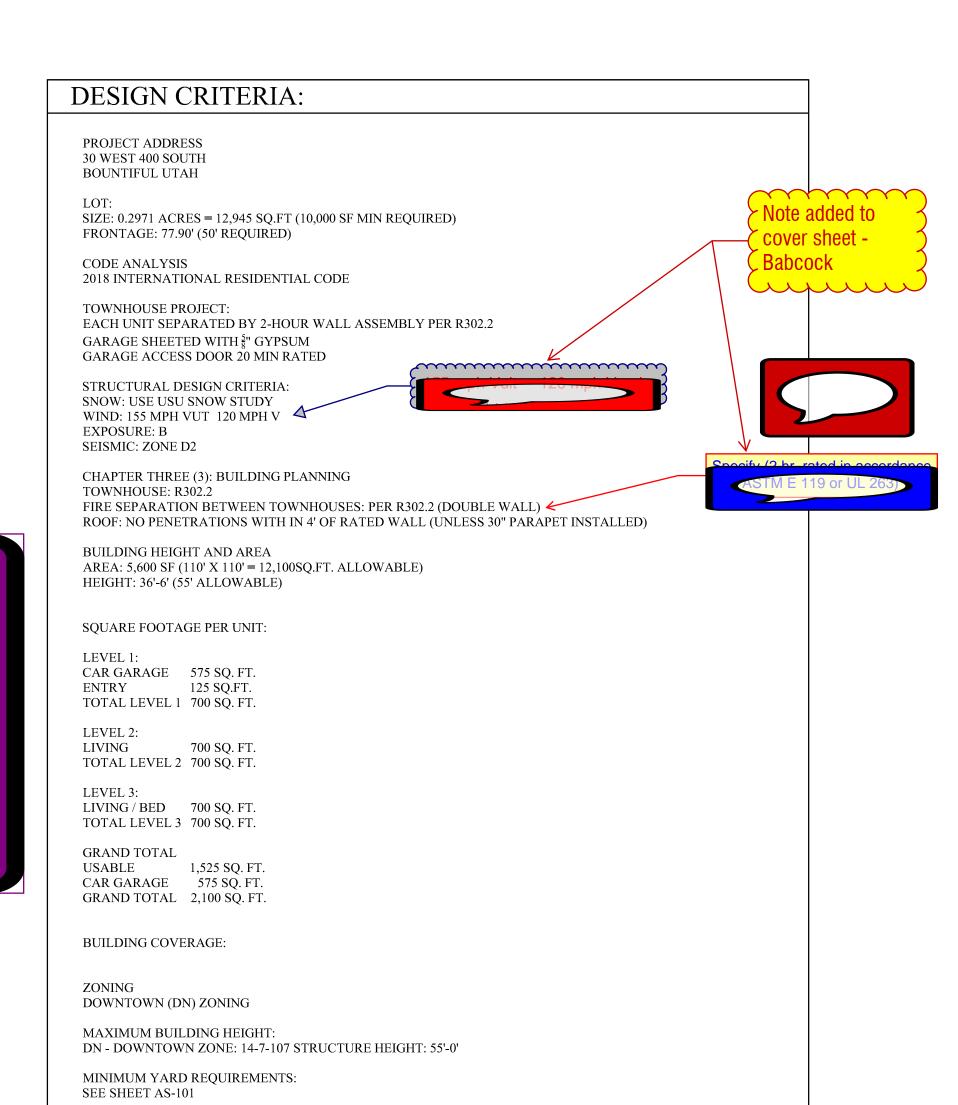


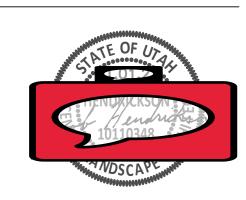

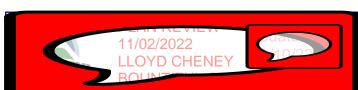

ccess is not maintained, SDMF reserves the right uired roads are placed back in service.





10-0	
INTERIOR SIDE YARD: 10'-0"	
REAR YARD 10'-0"	
DRAWING INDEX:	SQUARE FOOTAGE:
GENERAL:  G100 SITE PLAN / DRAWING INDEX	UNIT "A-H":
SURVEY SHEET 1 OF 1	
CIVIL:  C001 COVER AND LEGEND  C101 DEMOLITION PLAN	125 SF
C102 SITE & DIMENSION PLAN	575 SF LEVEL 1 GARAGE (FINISHED)  2,100 SF (GRAND TOTAL)

C201 ..... GRADING PLAN ..... STORM DRAIN & UTILITY PLAN C501 ..... DETAILS C502 ..... DETAILS C503 ..... DETAILS LANDSCAPE: L101 ..... LANDSCAPE PLAN L201 ..... DETAILS ARCHITECTURAL: AS100 ..... ARCHITECTURAL SITE PLAN AS101 ..... ARCHITECTURAL DUMPSTER DETAILS A101 ..... LEVEL 1 & 2 FLOOR PLANS A102 ..... LEVEL 3 & ROOF PLANS A103 ..... UNIT "A" ENLARGED PLAN ......UNIT "B-H" ENLARGED PLAN ..... EXTERIOR ELEVATIONS A202 ..... EXTERIOR ELEVATIONS A203 ..... BUILDING SECTIONS A204 ..... SECTIONS & DETAILS (FUTURE PKG) STRUCTURAL (FUTURE PACKAGE): S101 ..... FOOTING AND FOUNDATION PLAN

FRONT YARD SET BACK:

ELECTRICAL (FUTURE PACKAGE): E101 ...... LOWER LEVEL POWER / LIGHTING PLAN E102 ...... MAIN LEVEL POWER / LIGHTING PLAN


..... UPPER LEVEL FRAMING PLAN

S102 ..... MAIN LEVEL FRAMING PLAN

S104 ..... ROOF FRAMING PLAN S105 ..... STRUCTURAL DETAILS

E103 ..... UPPER LEVEL POWER / LIGHTING PLAN

ENLARGED VICINITY MAP

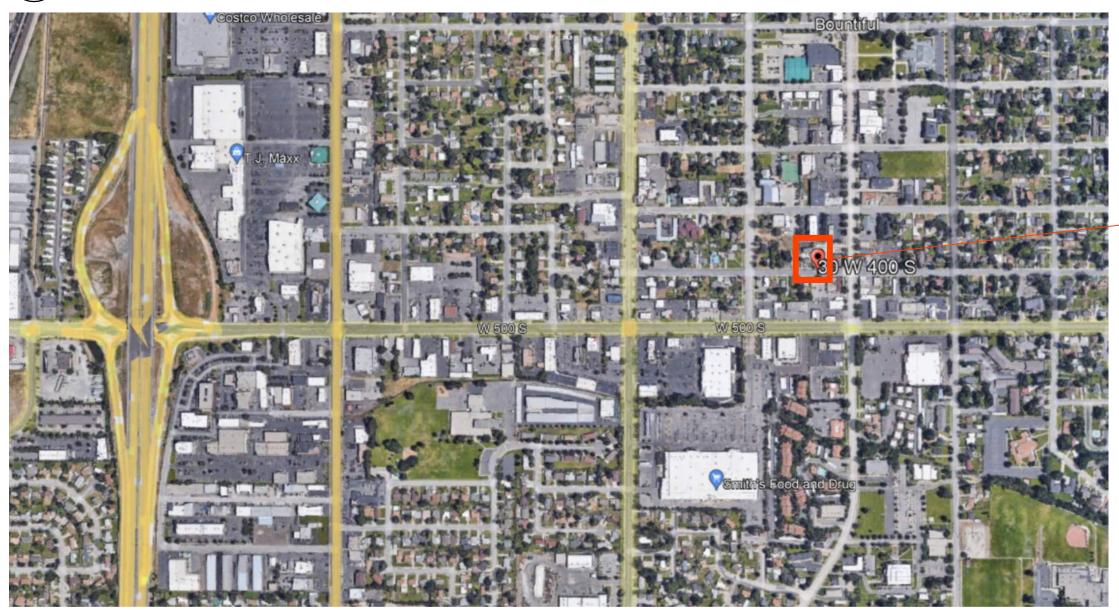

VICINITY MAP




**PERSPECTIVE** 




- SITE


G100

COVER date: 10.27.2022

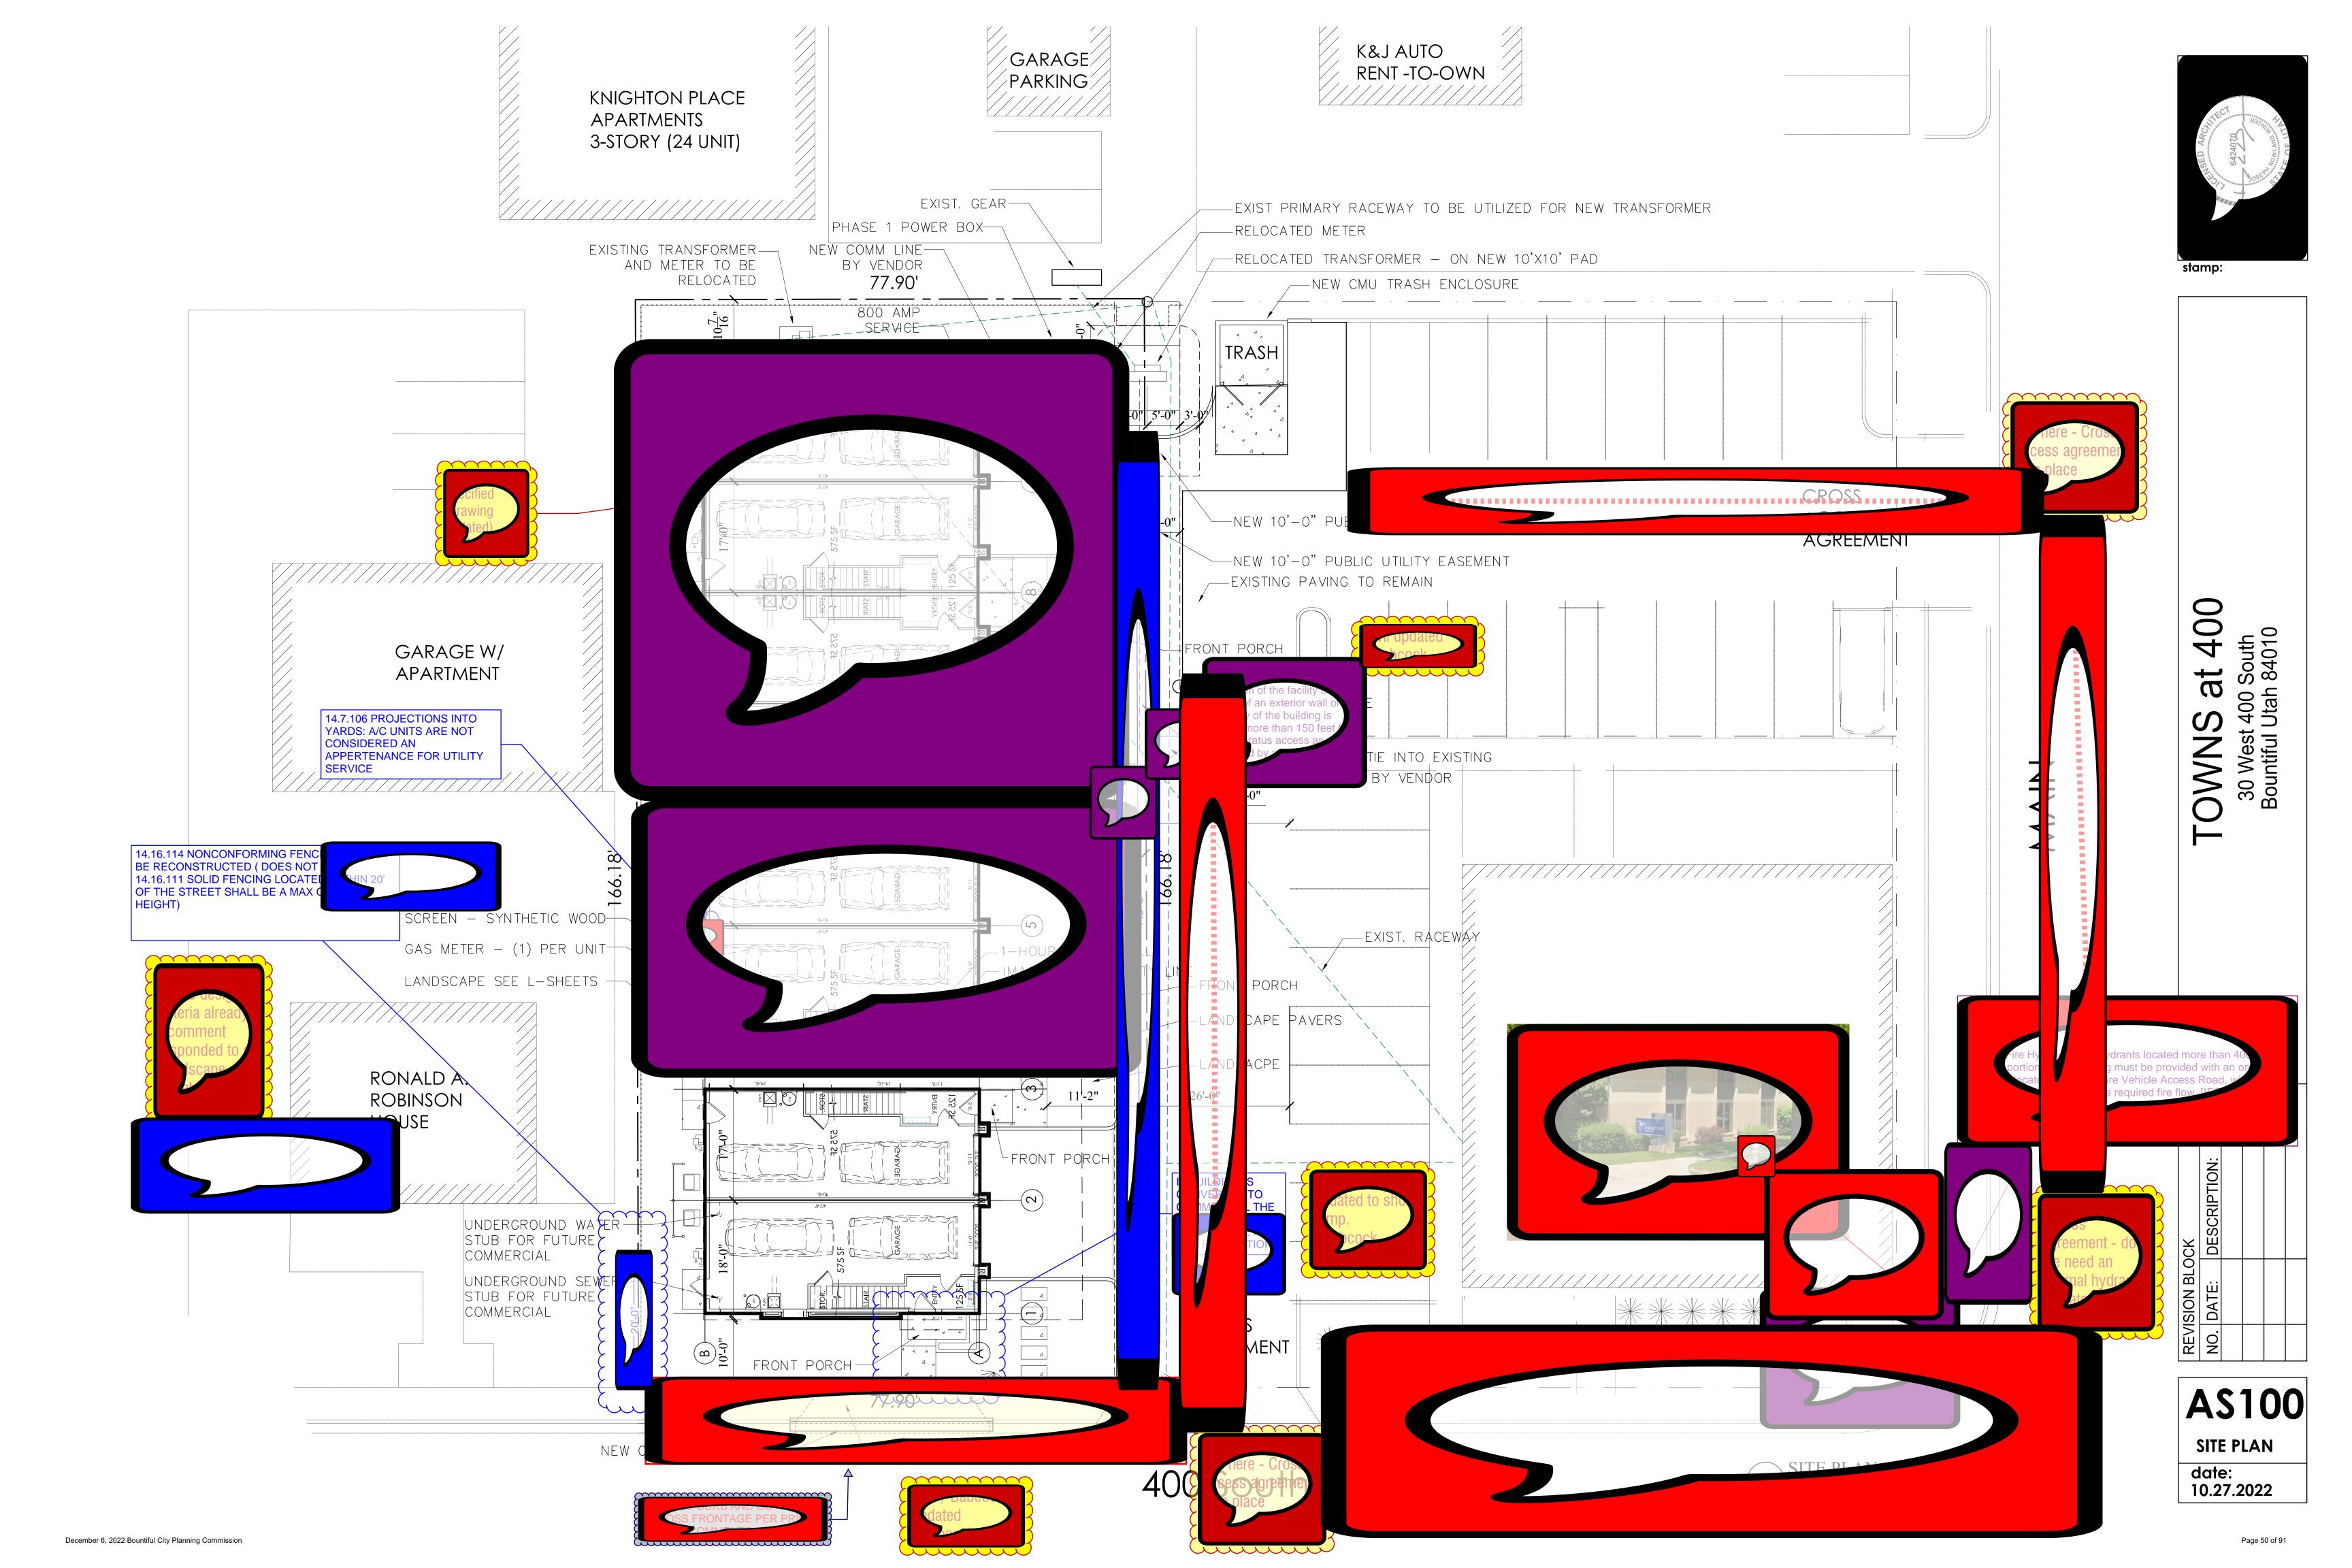

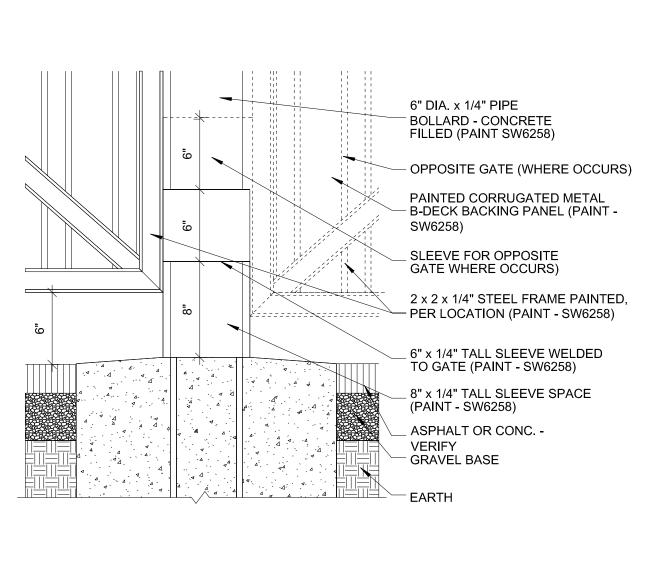



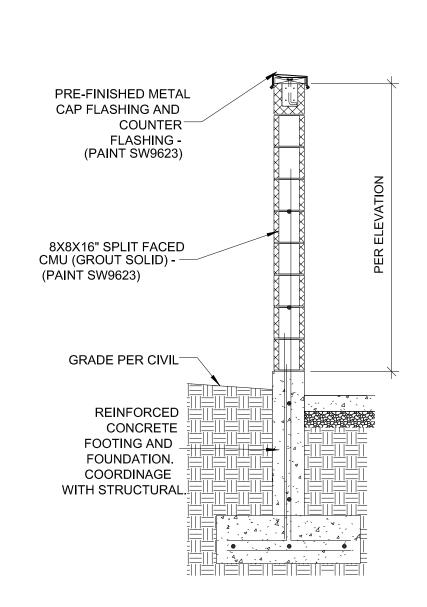

9 TRASH ENCLOSURE WALL SECTION	
1/2" = 1' 0"	

PRE-FINISHED METAL CAP \_ FLASHING AND COUNTER

SPLIT FACED CMU WALL

6" X 1/4" TALL SLEEVE — WELDED TO GATE (PAINT

PAINTED CORRUGATED

METAL B-DECK BACKING

PANEL (PAINT SW6258)

6" DIA. x 1/4" PIPE BOLLARD - CONCRETE FILLED (PAINT SW6258)

\_ 6" X 1/4" TALL SLEEVE WELDED TO GATE (PAINT SW6258)

\_ 8" x 1/4" TALL SLEEVE SPACER

1" DIA. STEEL PIN

\_ TACK WELD SO PIN CANNOT BE REMOVED

\_ METAL PIP/SLEEVE WELDED TO FRAME

PIPE SLEEVE (FULL DEPTH OF CONCRETE)

- SEE PLAN FOR

LOCATIONS

(PAINT SW6258)

CONCRETE PER

ASPHALT OR

GRAVEL BASE

- CONCRETE


EARTH


CIVIL


FLASHING (WHITE)

(PAINT SW9623)

SW6258)

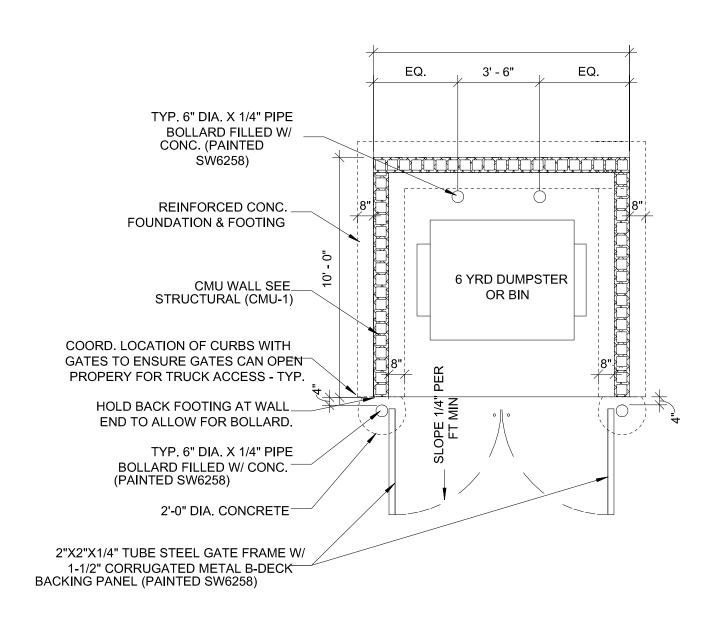


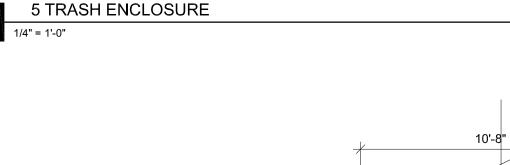

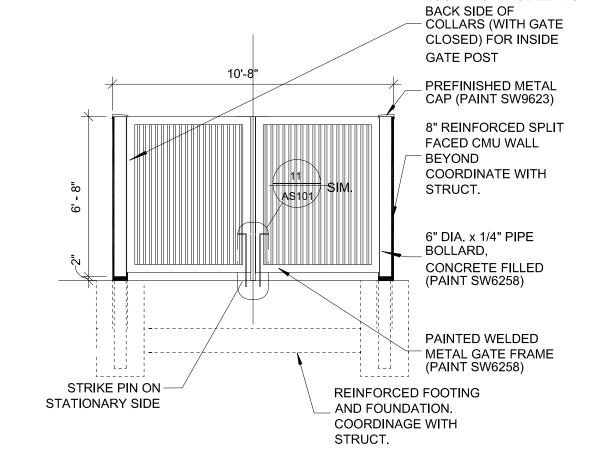



LOCATE GREASE ZERKS AT


6 TRASH ENCLOSURE - FRONT ELEVATION

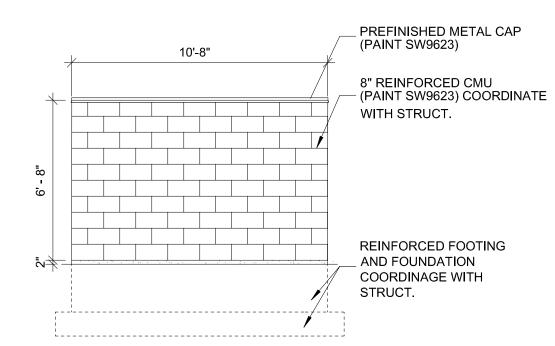

7 TRASH ENCLOSURE - BACK ELEVATION

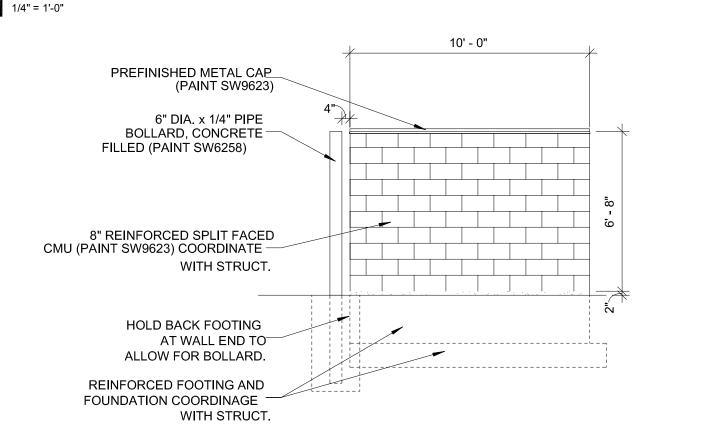

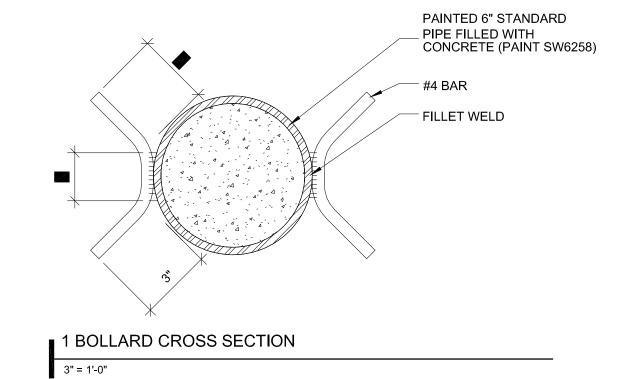

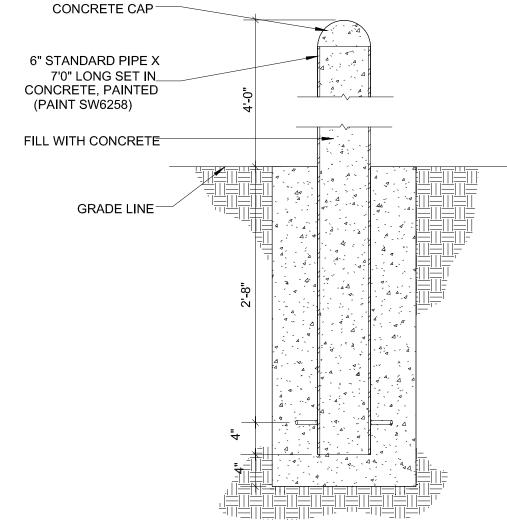

2 BOLLARD SECTION 1/2" = 1'-0"

4 NOT USED

3 NOT USED 1 1/2" = 1'-0"

South 84010

stamp:

**DUMPSTER DETAILS** date: 10.27.2022

FLAT BAR GUIDE ROD TYPE\_ 1-1/2" B-DECK WELDED TO TS GATE FRAME (PAINT SW6258) **ESPAGNOLETTE** TS4X2X3/16 DOOR STILES & RAILS (PAINT SW6258)

14 GATE ESPAGOLETTE

11 DUMPSTER GATE PIN 1 1/2" = 1'-0"

WEEP HOLES



₄ ₃2' -₃0".

J. DIĄ.


■ 10 DUMPSTER GATE - END POST DETAIL



December 6, 2022 Bountiful City Planning Commission


13 NOT USED

1/2" = 1'-0"

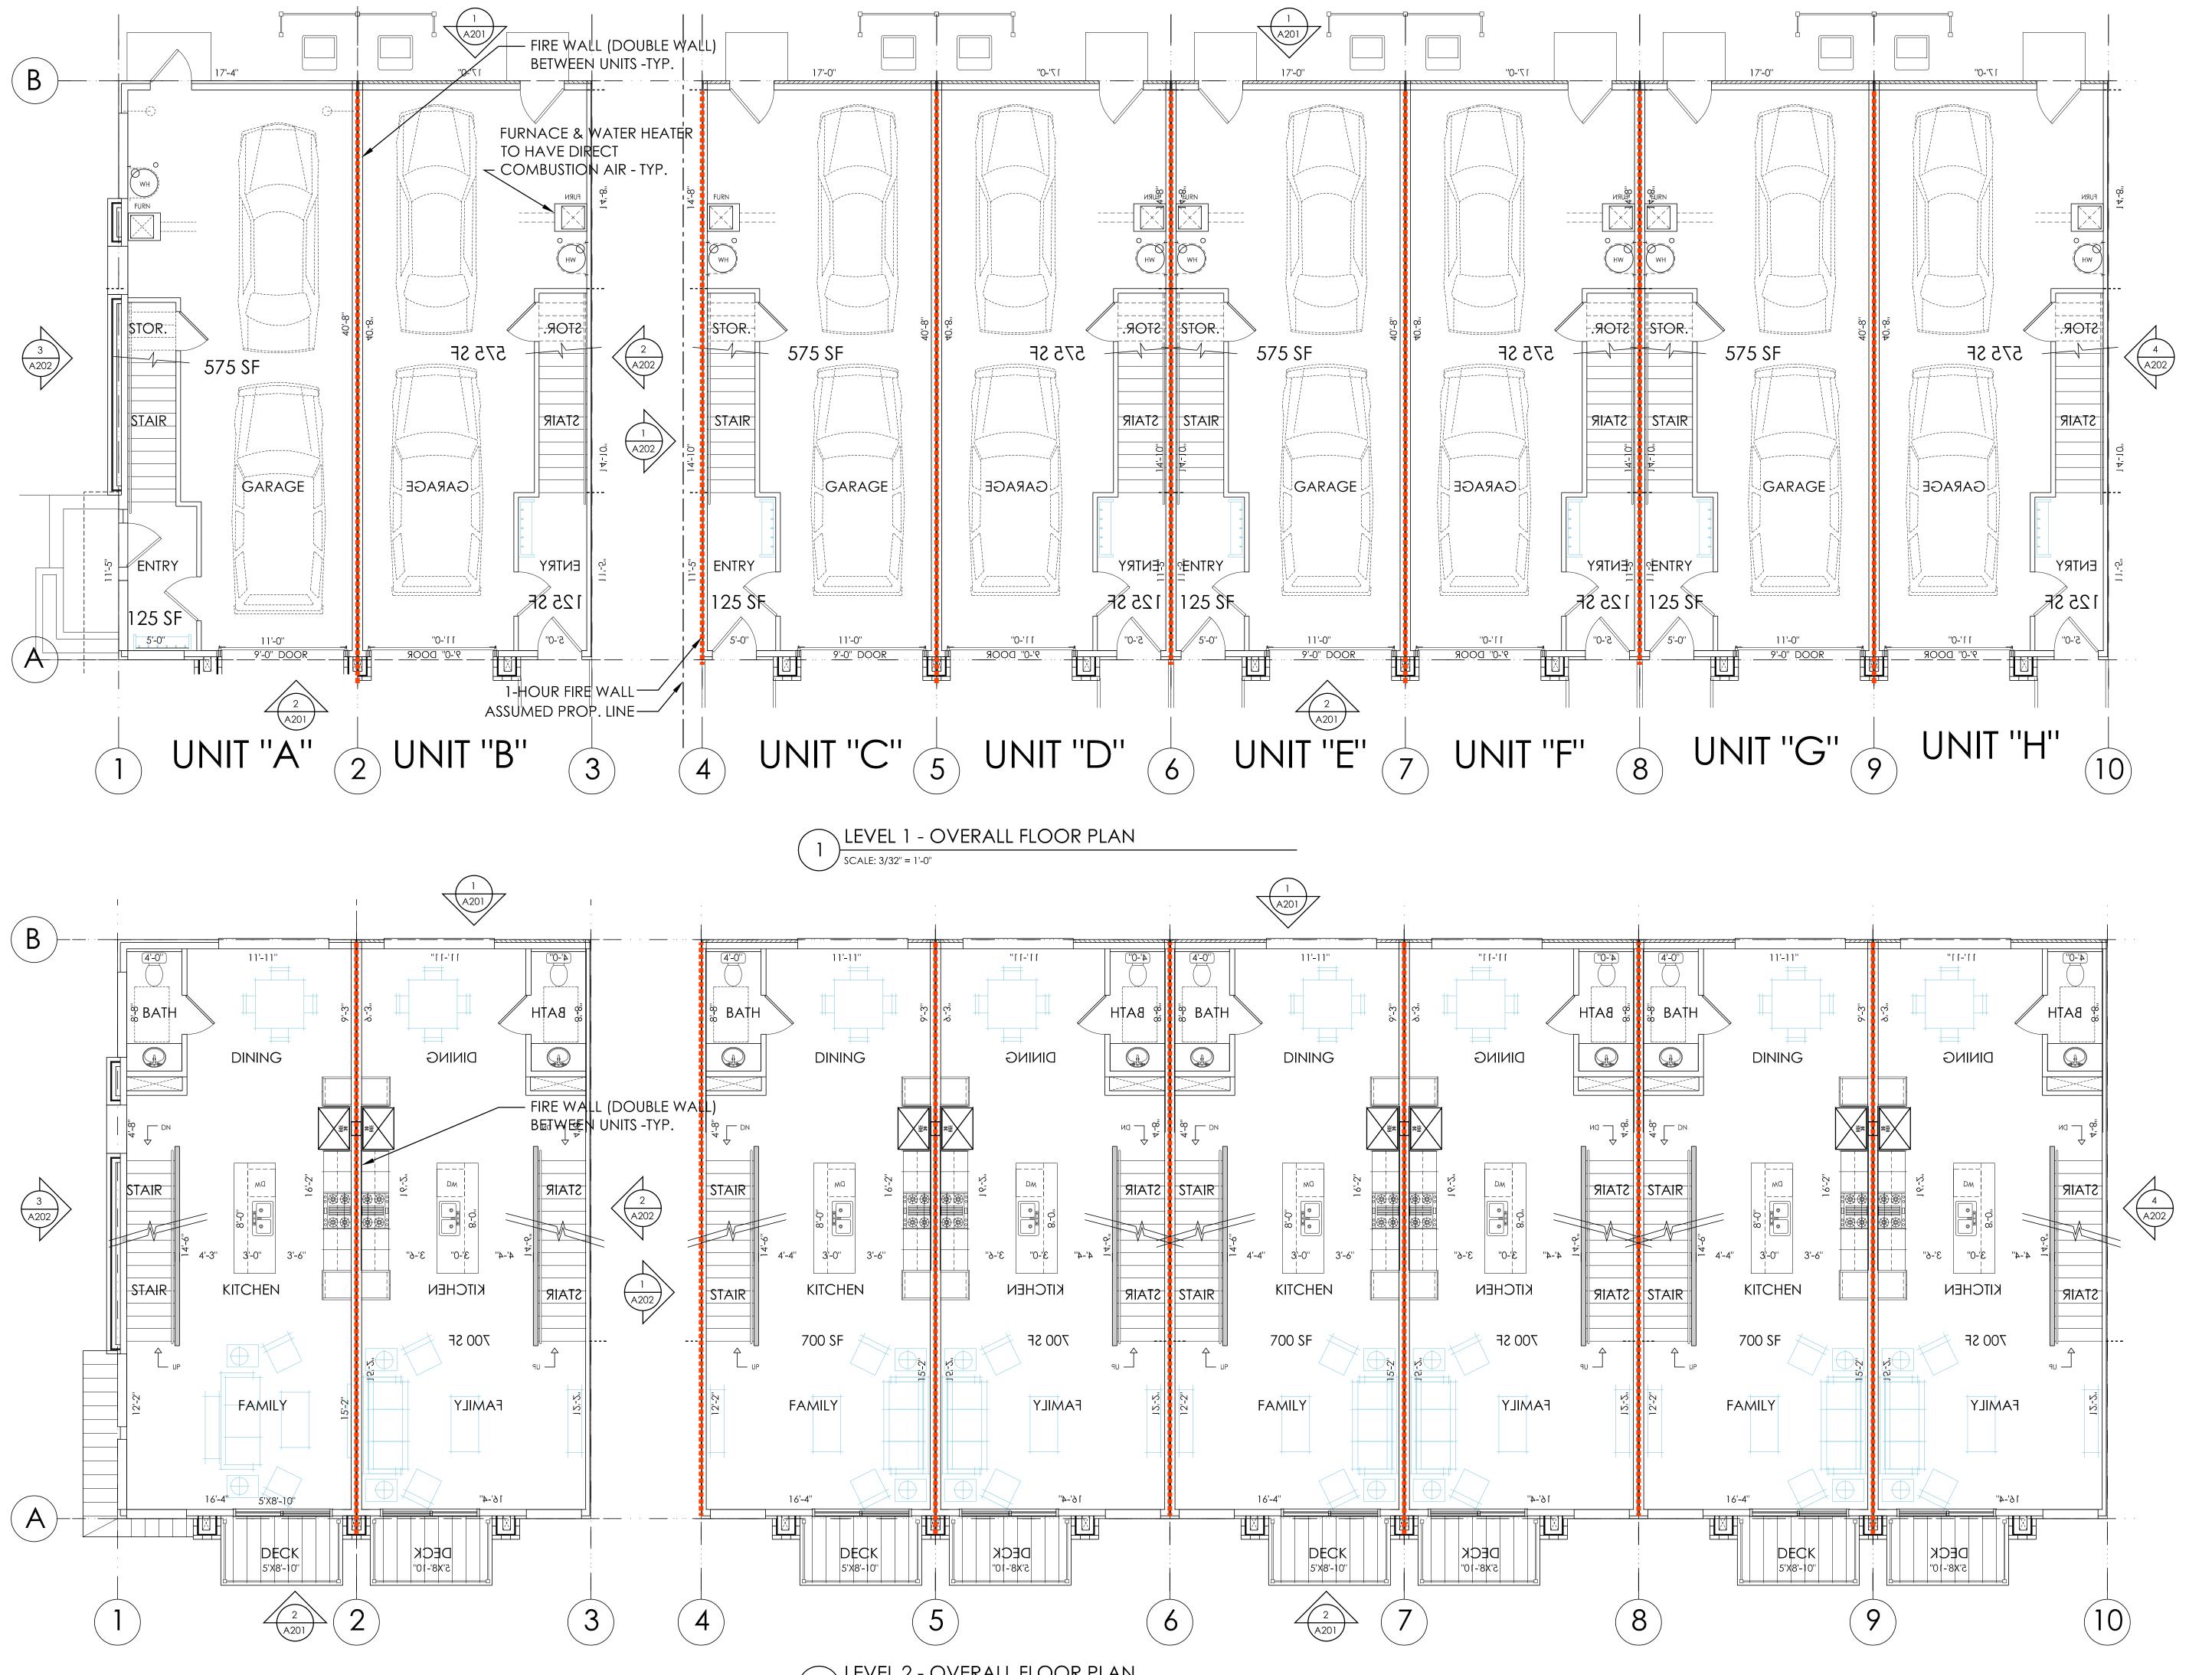




at 400 30 West 400 South Bountiful Utah 84010

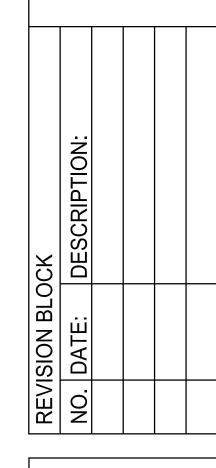



LEVEL 1&2 date: 10.27.2022

SCALE: 3/32" = 1'-0"

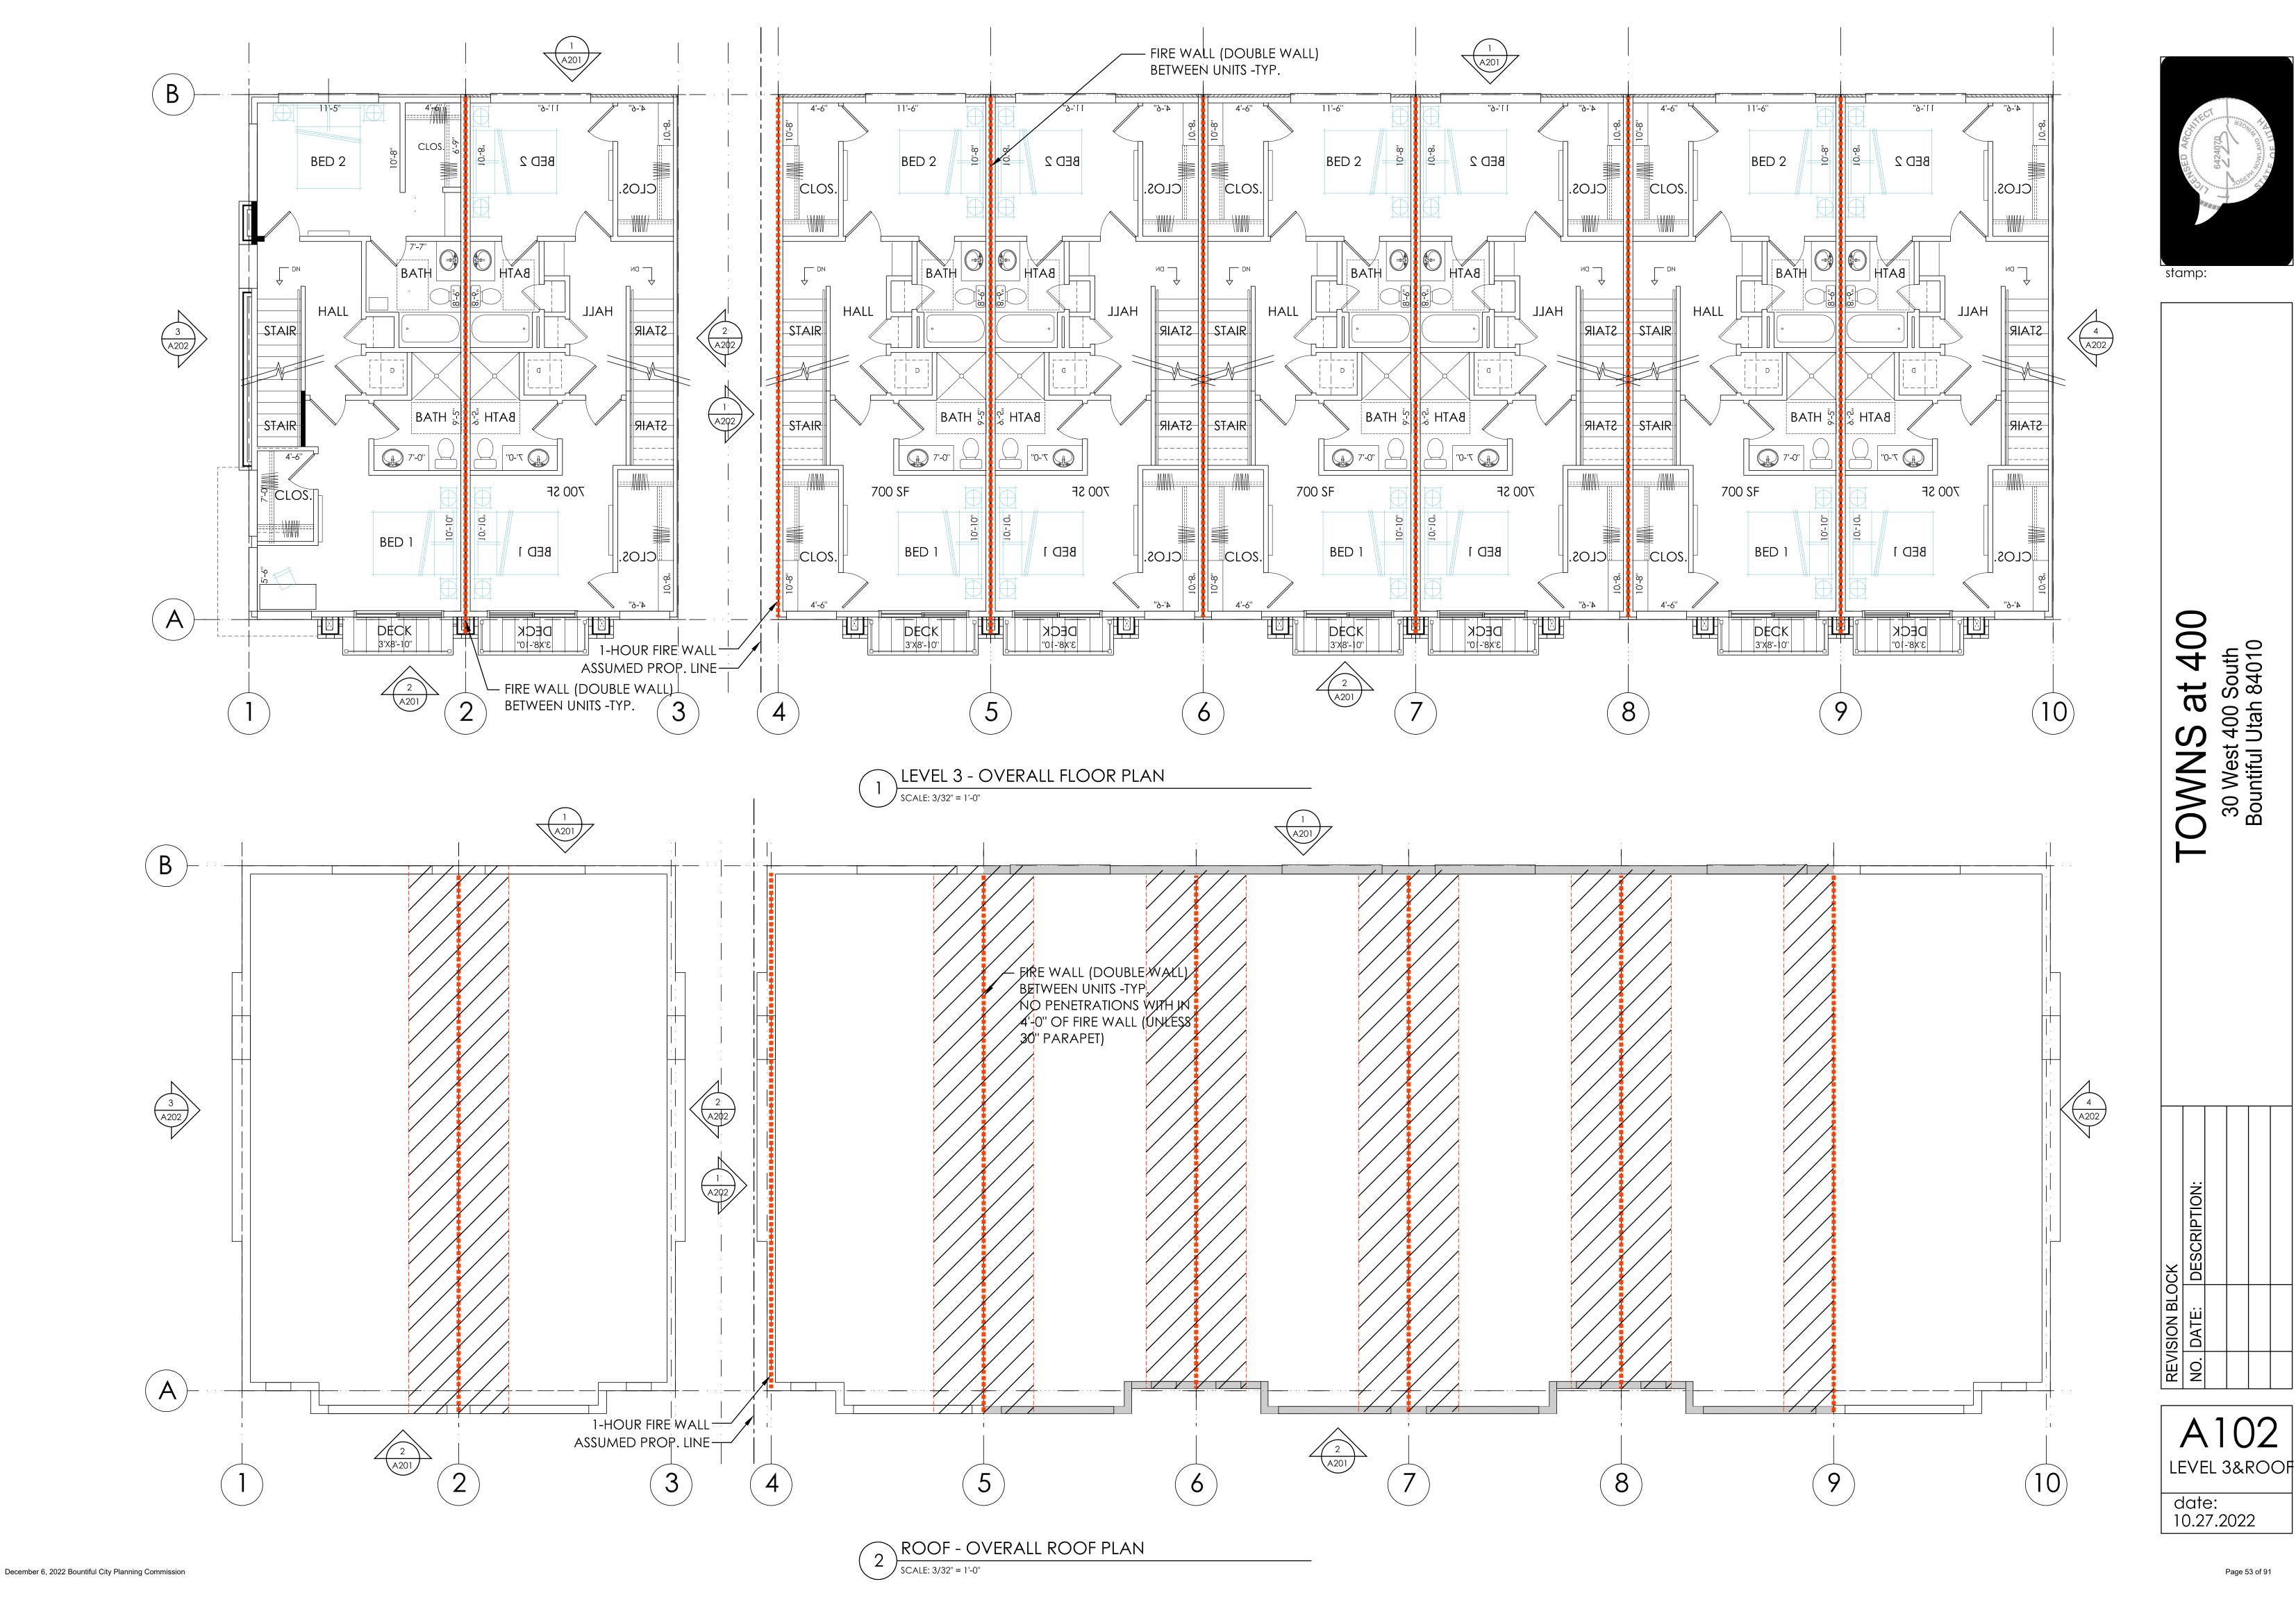

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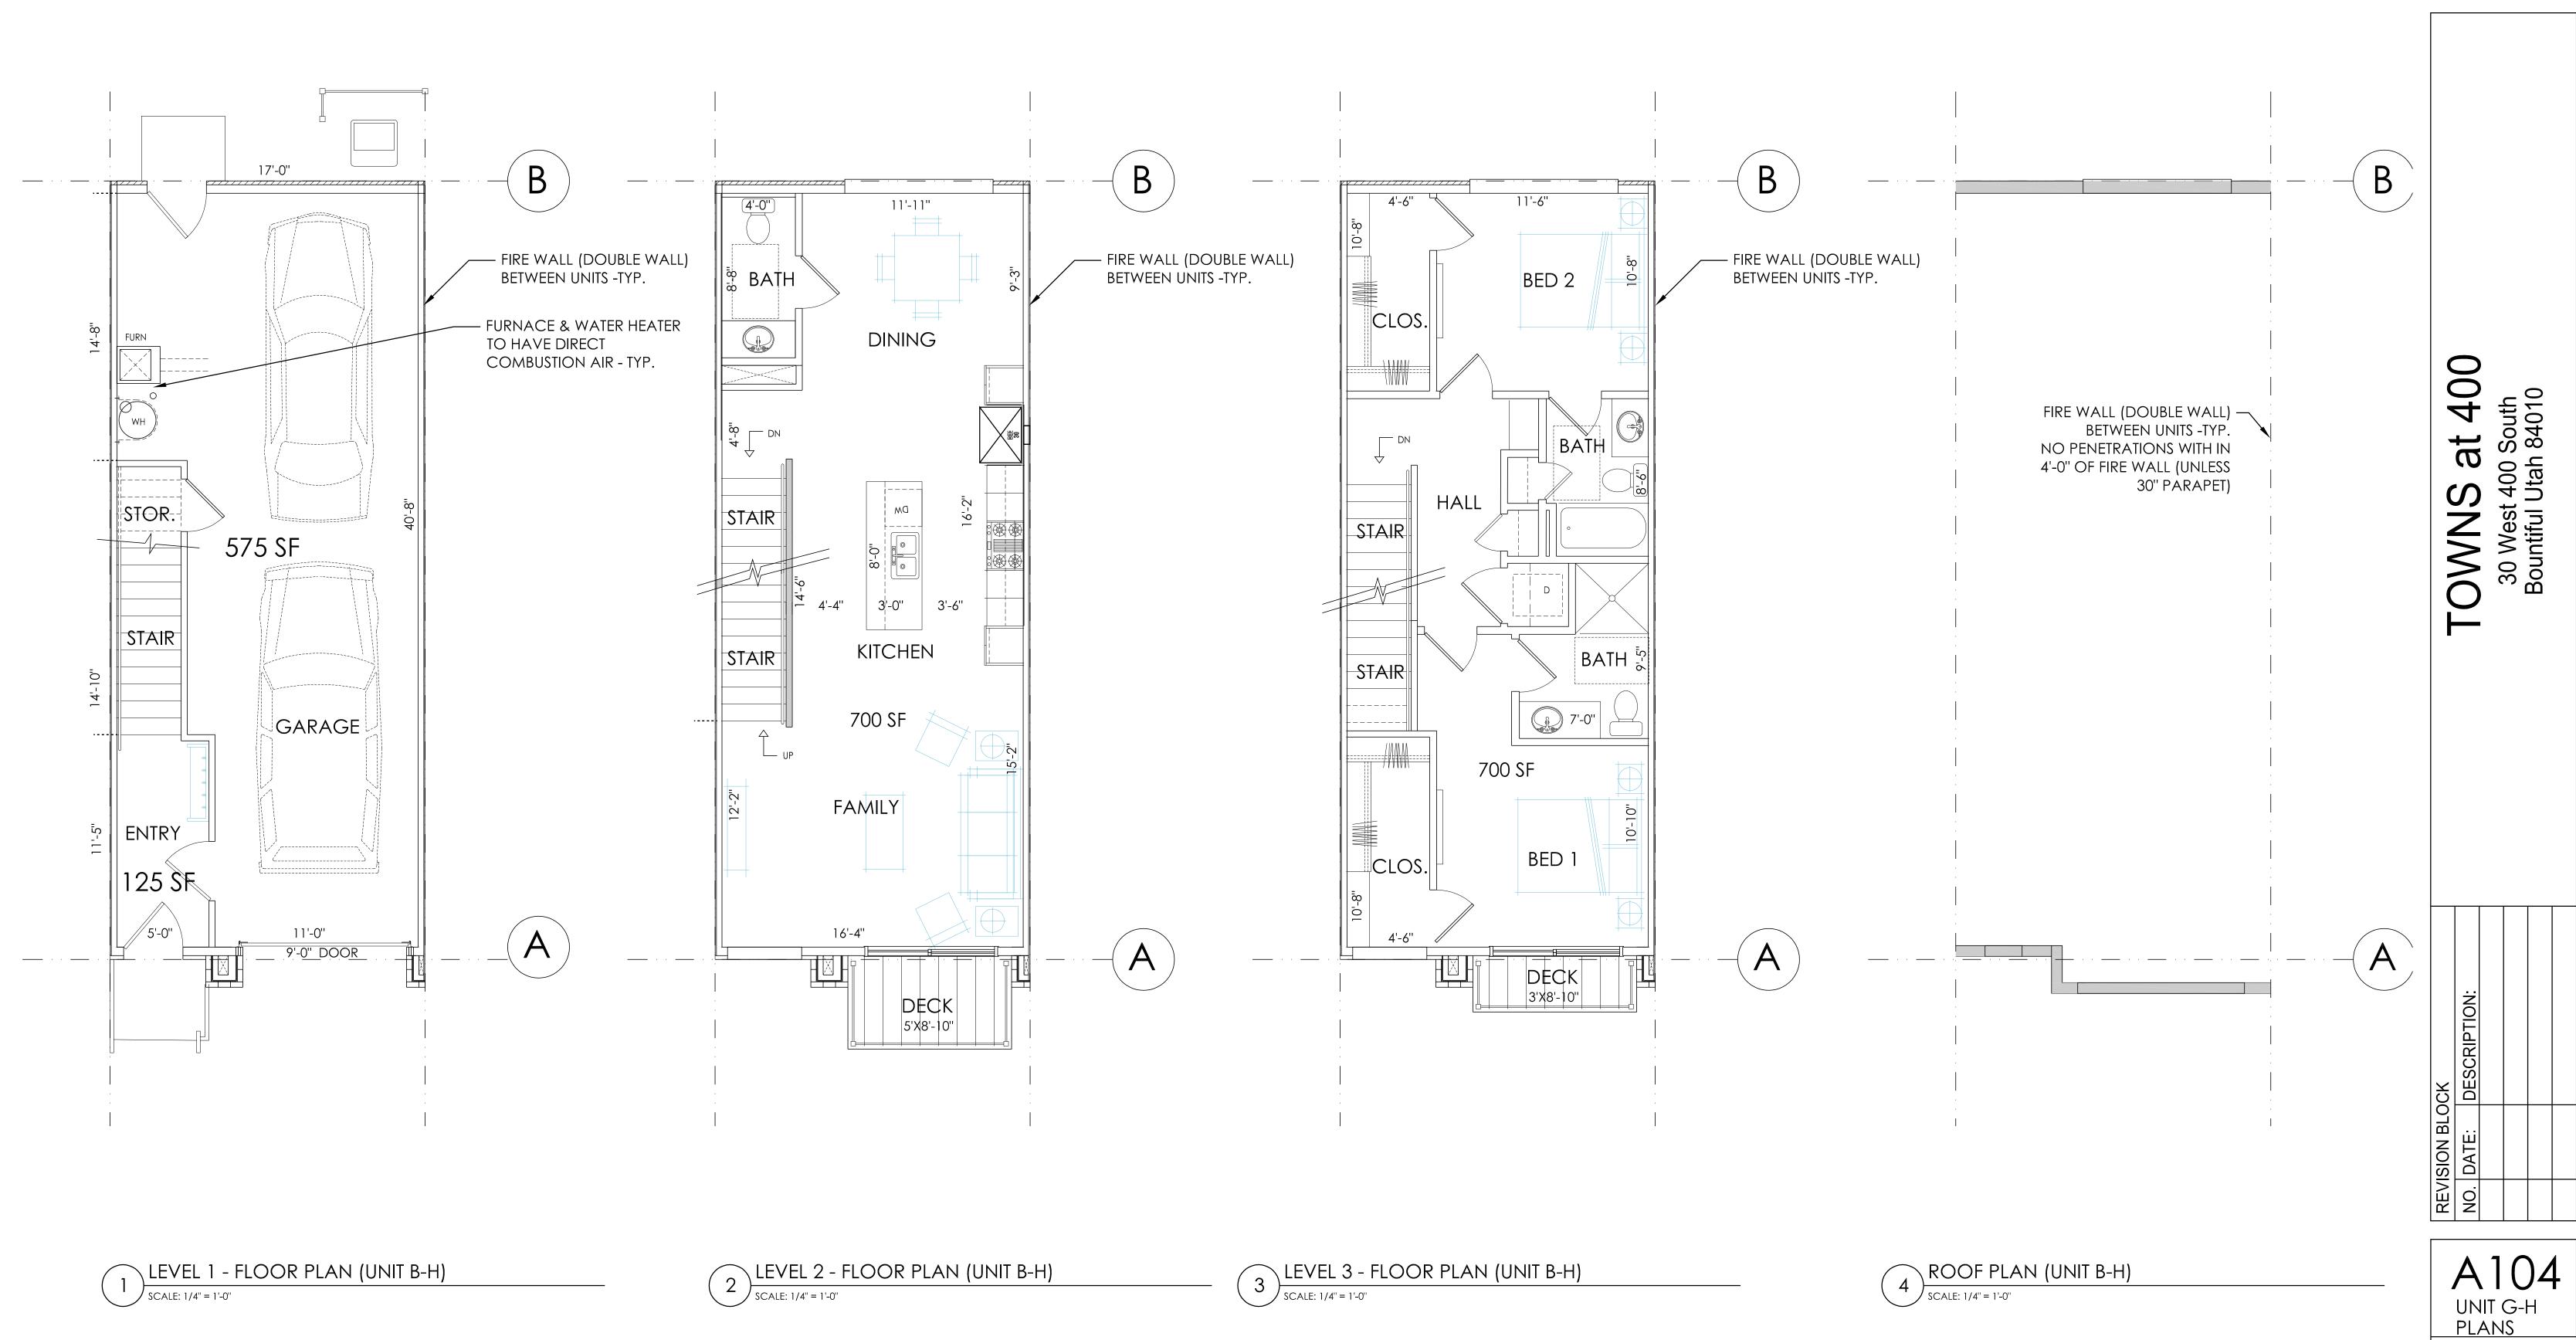


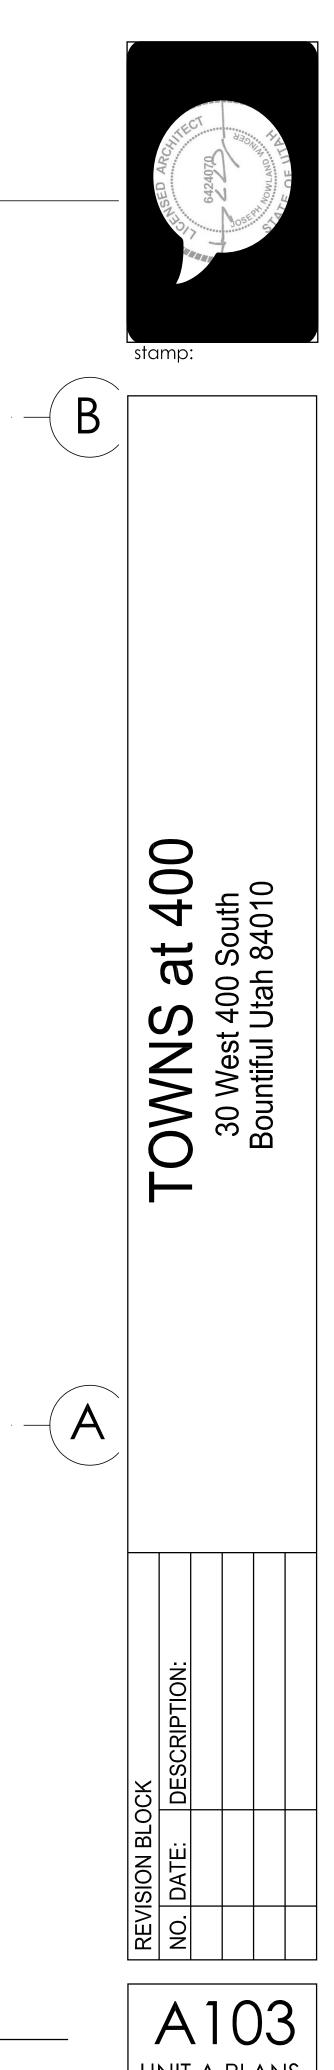

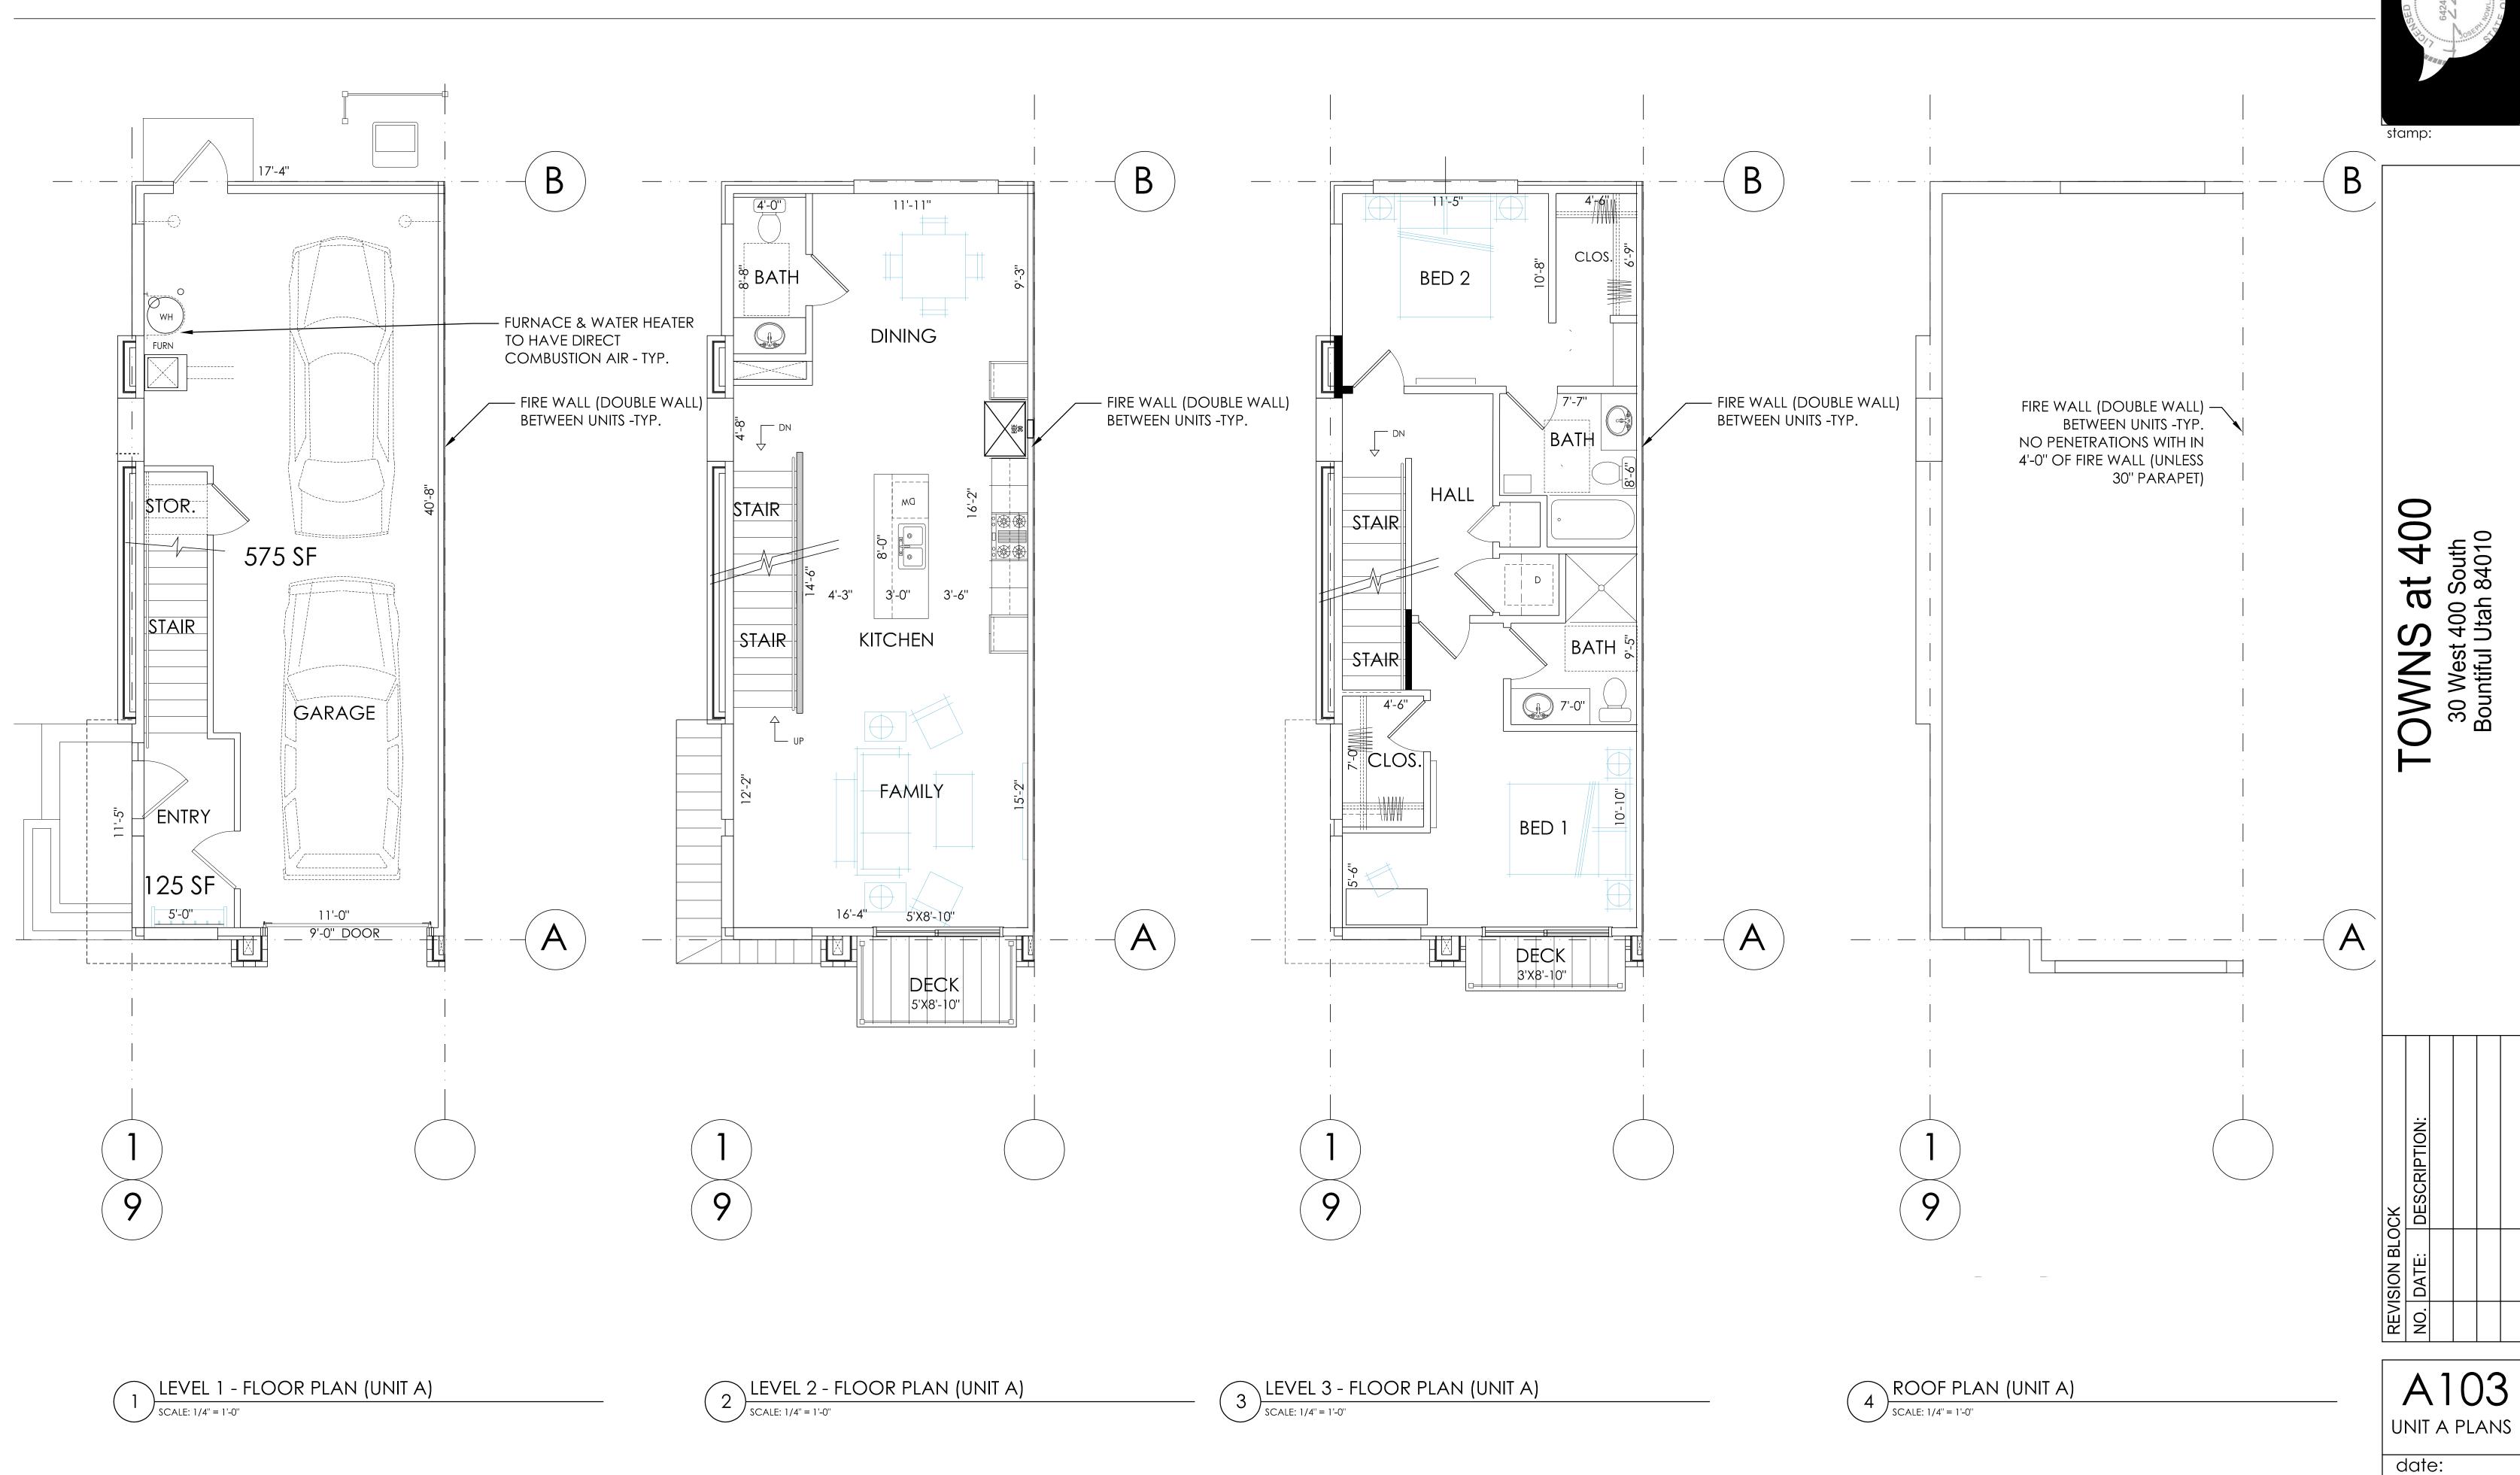December 6, 2022 Bountiful City Planning Commission

10.27.2022







December 6, 2022 Bountiful City Planning Commission

date:

10.27.2022

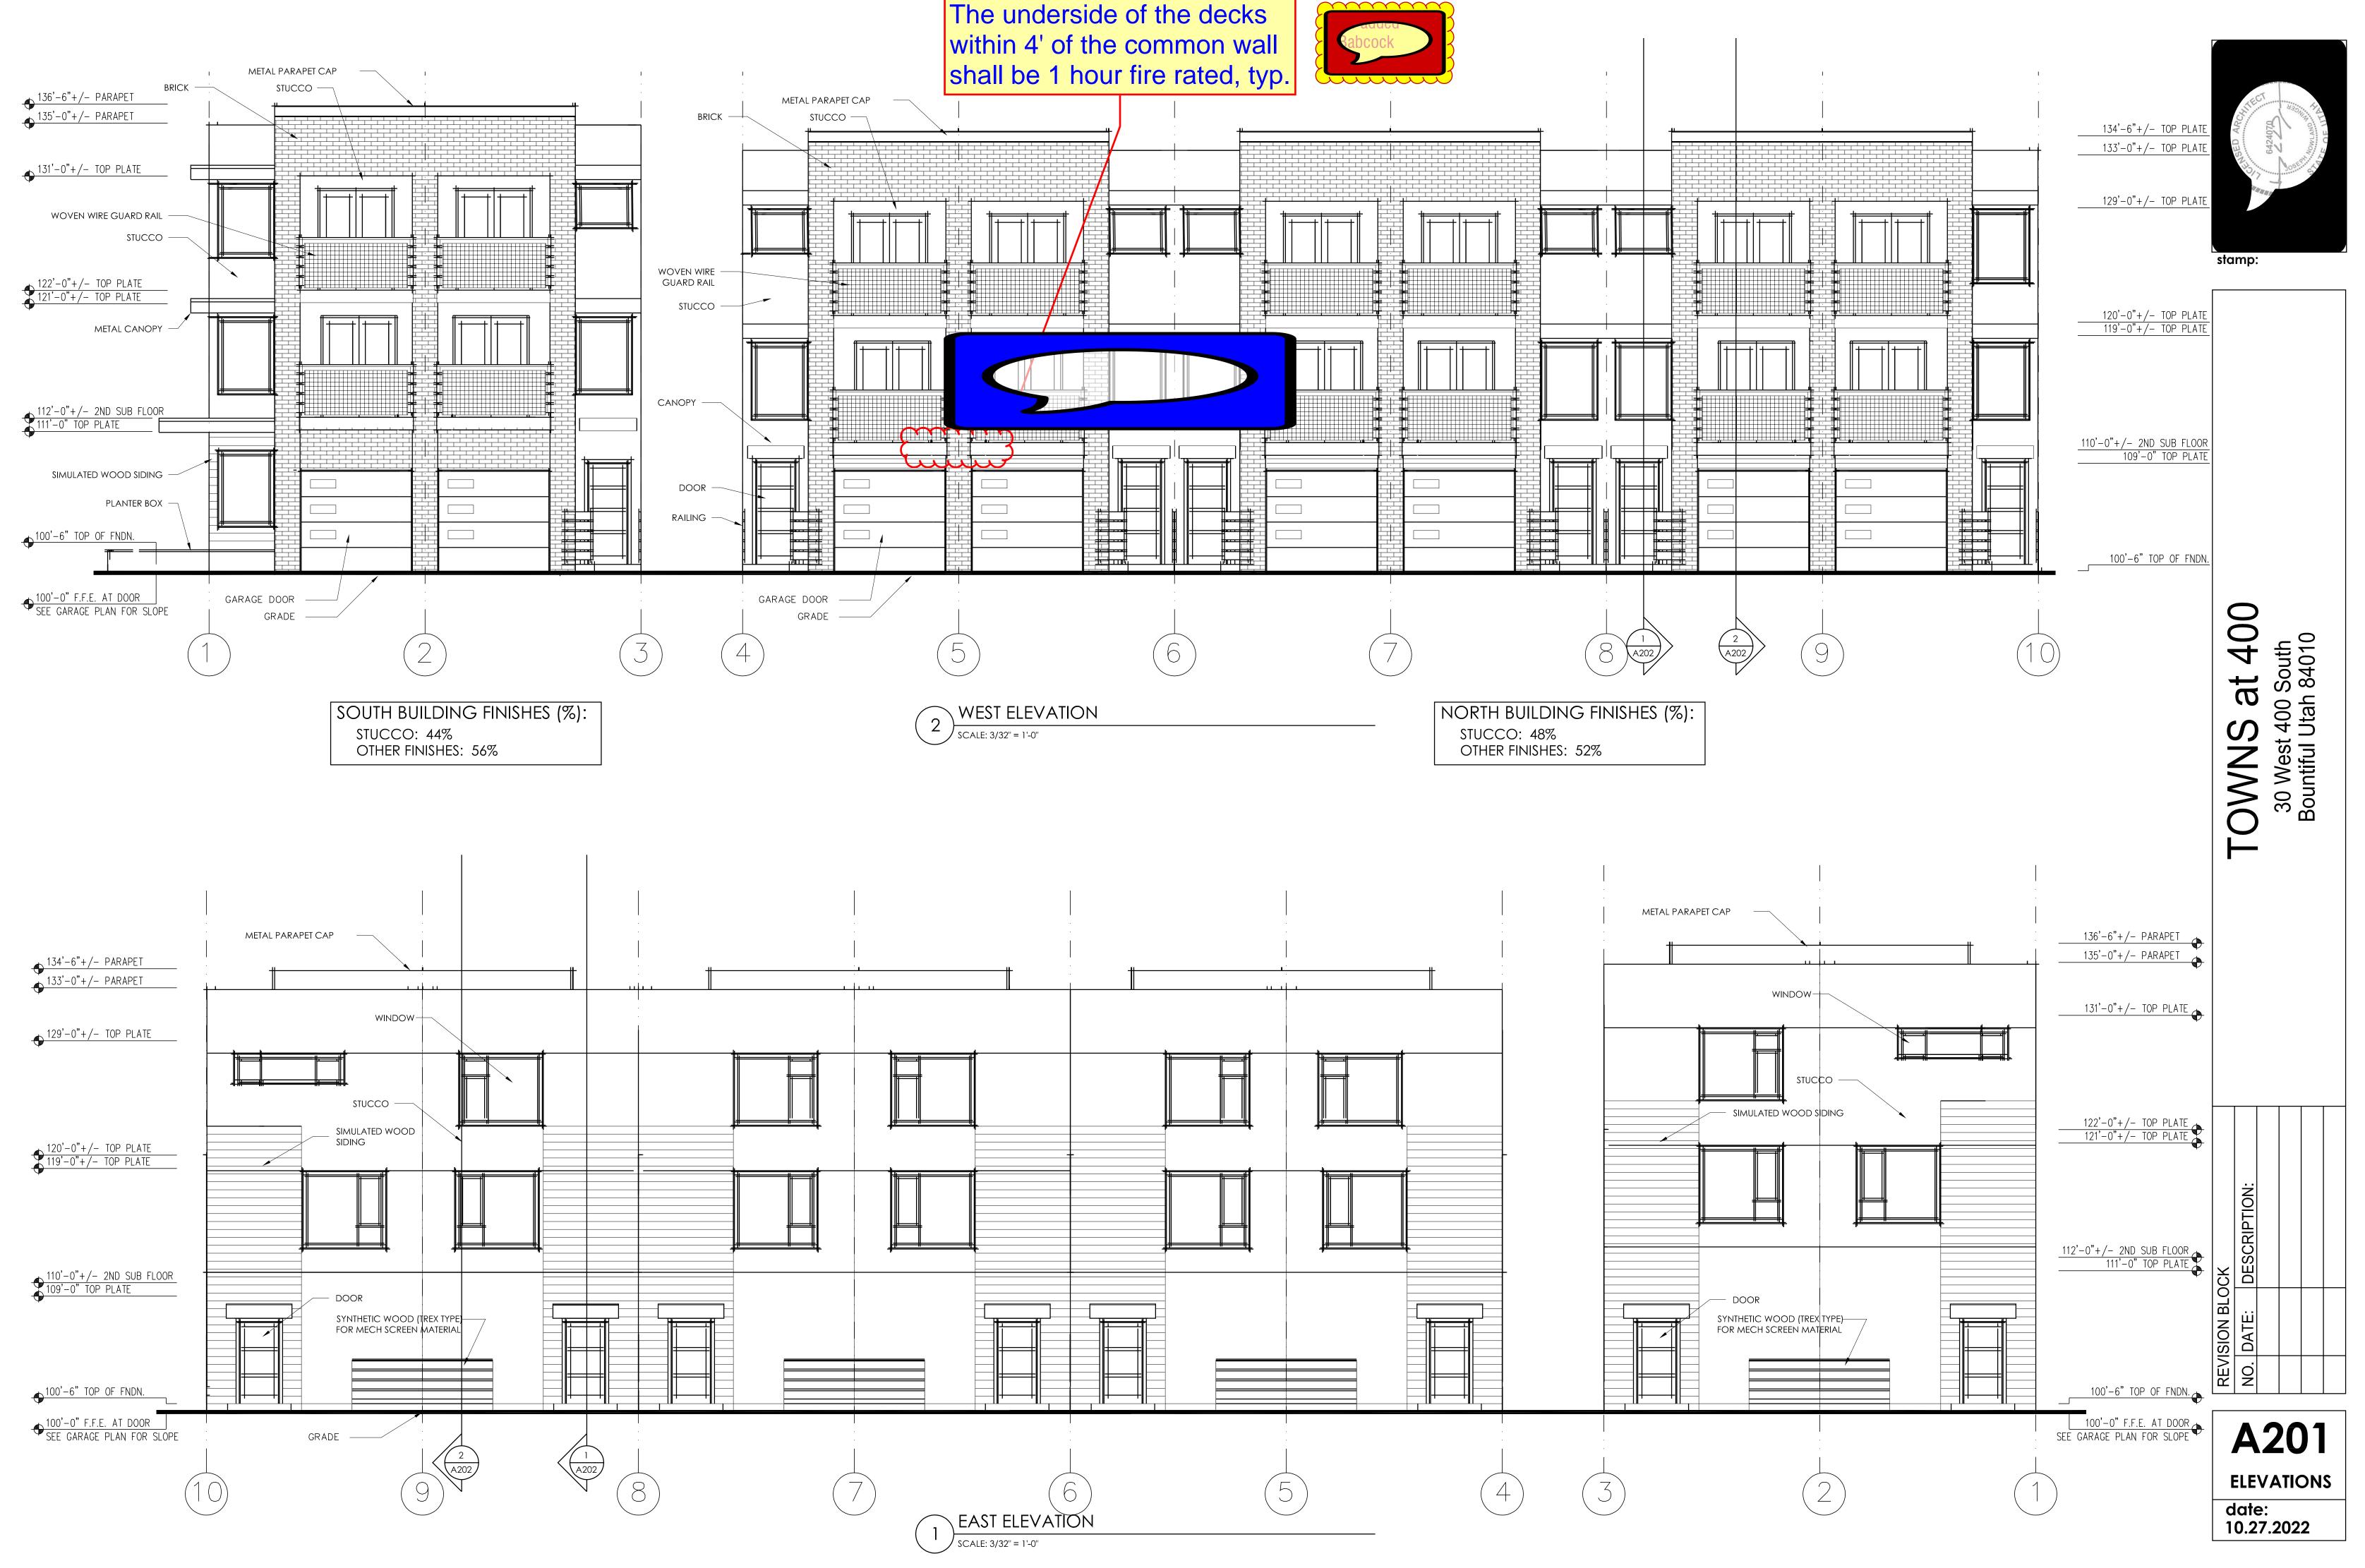

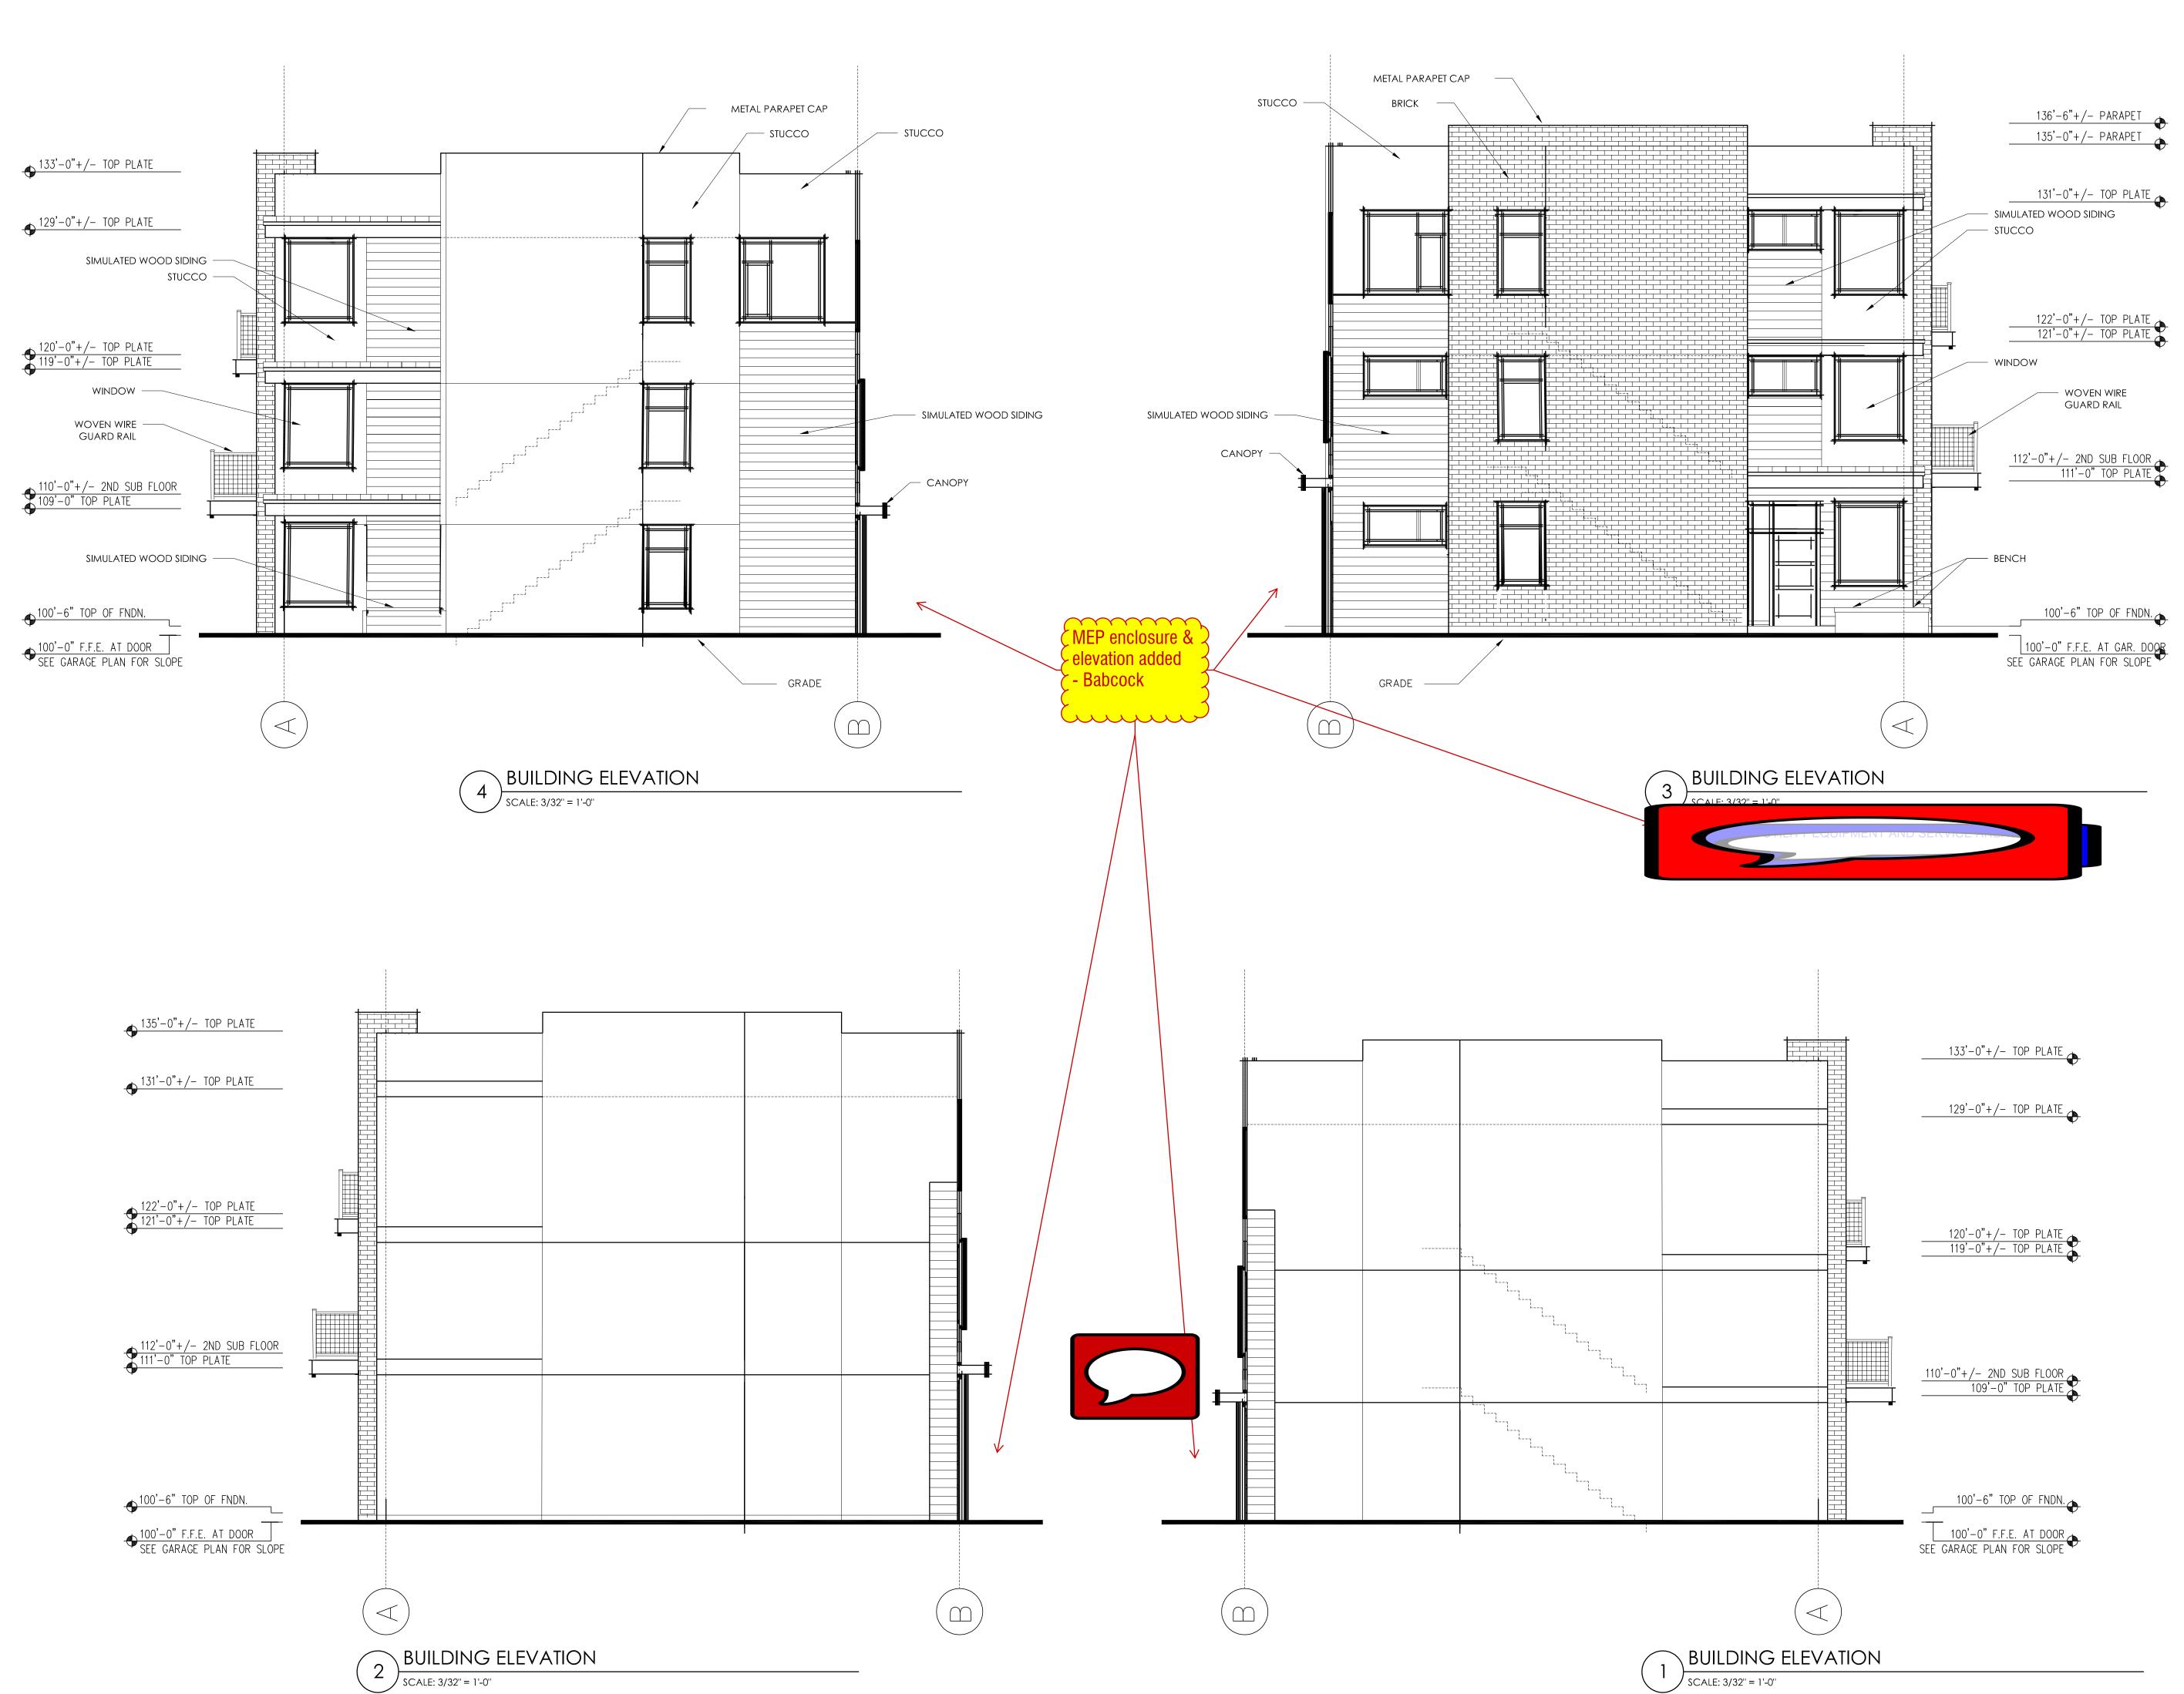



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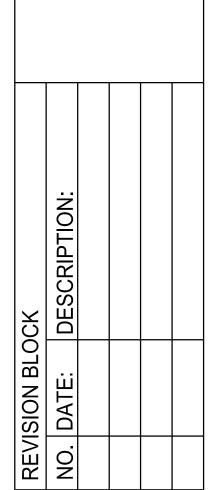
TOWNS at 400 30 West 400 South Bountiful Utah 84010

\\	DESCRIPTION:		
CK			
REVISION BLOCK	NO. DATE:		
REVI	NO.		

A202 ELEV & SECT


date: 10.27.2022


30 West 400 South Bountiful Utah 84010





date: 10.27.2022

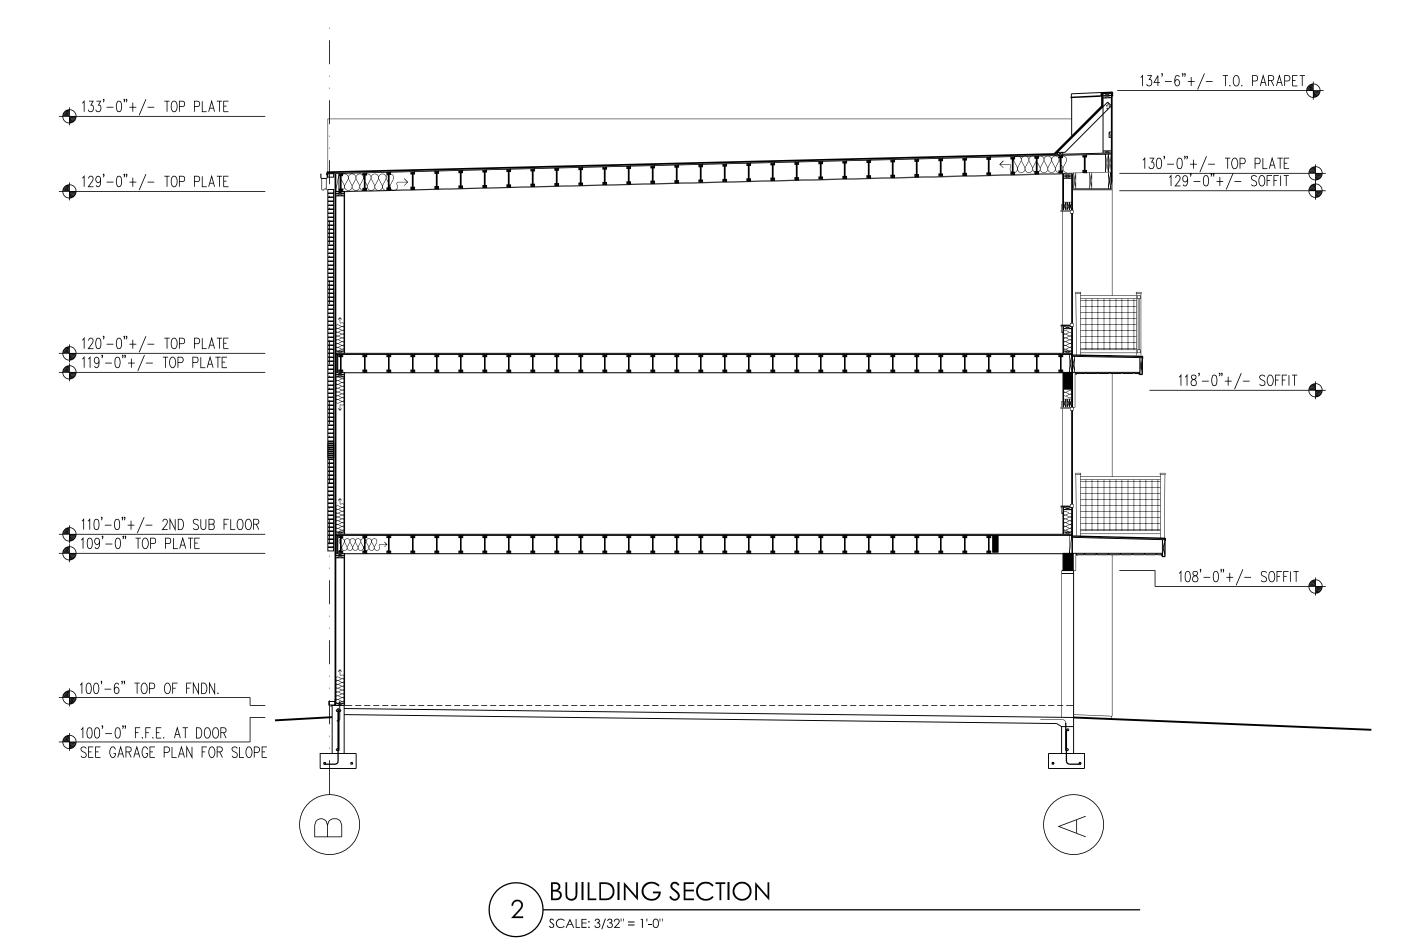

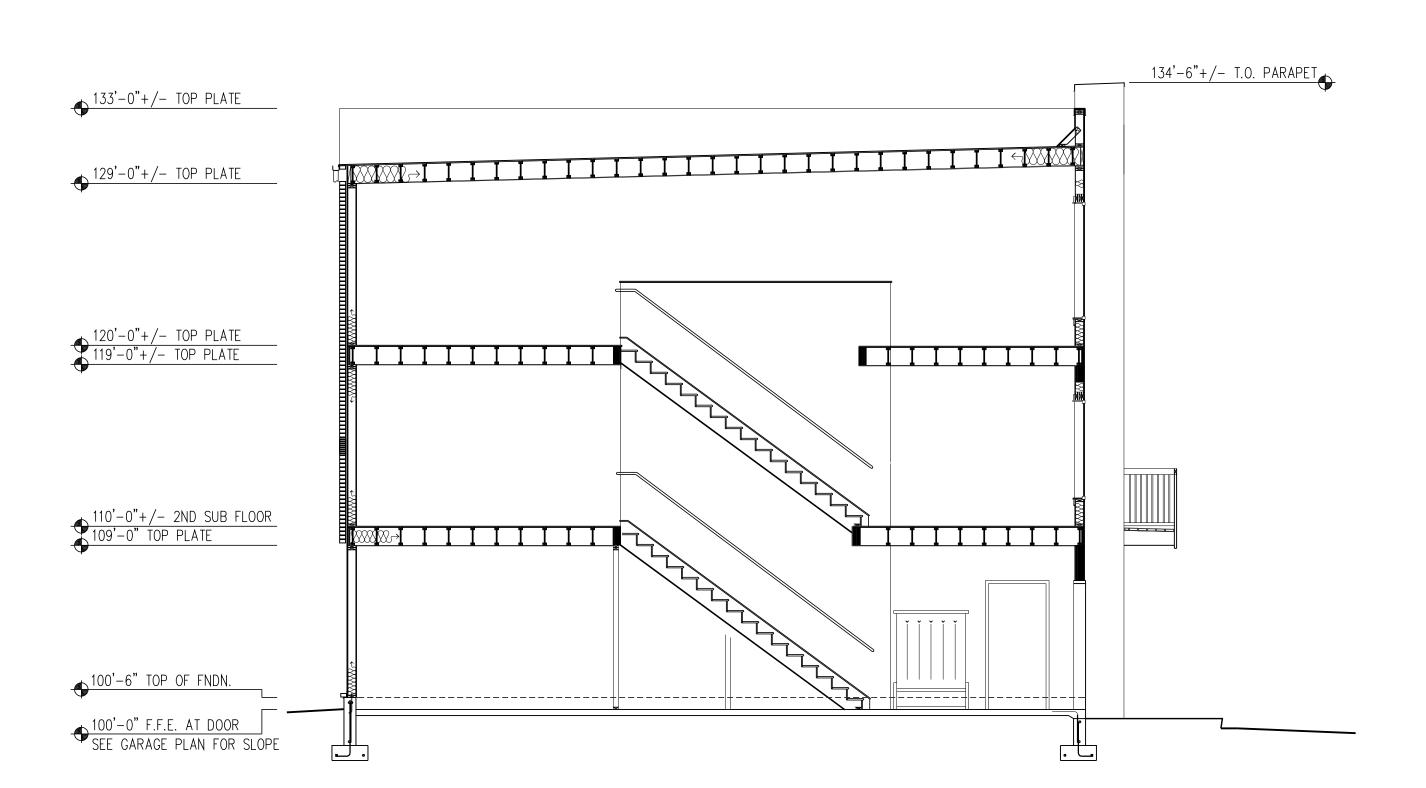

# **Planning Commission Staff Report**



Item: Variance Request
Address: 406 South Main Street

**Author:** Francisco Astorga, AICP, Planning Director

Date: December 6, 2022

### **Authority**

Land Use Code § 14-2-103 and 14-2-111 delegates Variances to be reviewed by the Planning Commission.


### Background

On October 18, 2022, Randy Beyer with Knowlton General LC, representing John Hepworth Investment Group LLC (property owner), submitted a Variance Application desiring a waiver or modification from the Land Use Code which requires a 5-foot landscaping buffer along a portion of the southern property line. The subject site is located at 406 South Main Street, which is in the Downtown Mixed Use Zone. The subject site consists of five (5) parcels located on the southwest corner of Main Street and 400 South. The site, formerly known as the Marie Callender's, includes additional properties to the west, including an existing single-family dwelling that would be demolished prior to the desired redevelopment of the parcels.


Under separate applications, the Applicant desires to redevelop the site into a mixed-use development consisting of approximately 2,200 square feet of office space and twenty-eight (28) residential units (apartments), approximately 31,000 square feet. These applications are on hold until this Variance Application is resolved. The Applicant submitted the following text (attachment 1) copied verbatim, and graphics (attachment 2) explaining the requested Variance, additional information provided by the Applicant is also included in the Analysis Section of this staff report.

Variance Application explanation for Bountiful property (address: 400 S Main Street)
The proposed Variance Application is to allow the owner of 400 S Main Street a variance from installing a 5' landscape buffer per ordinance 14-7-109 of Bountiful City. As noted in the above illustration the landscape buffer would prevent the adjacent owner from using their parking stalls.

# Proposed site plan:

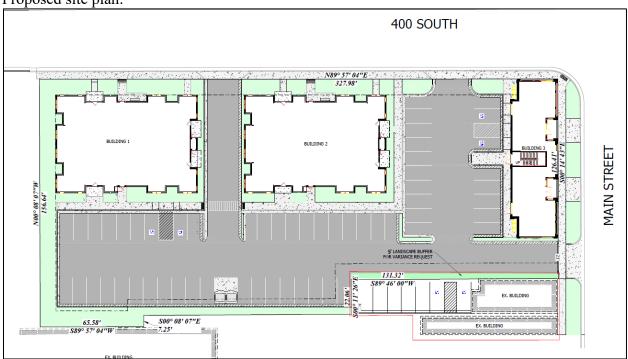

Proposed site plan, zoomed in over affected area:

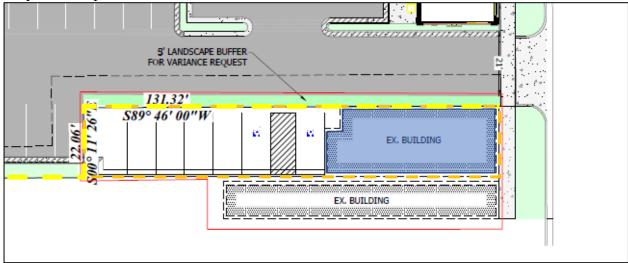

The added dashed yellow line is the property line between the subject site and the neighboring properties to the south. The added dashed orange line is the property line of the property to the south (458 South Main Street, hair salon site, building showin in blue). The DN Zone requires 5-foot landscaping buffer along a side property line within a drive area. If the required 5 foot landscaping buffer is installed, as shown in this exhibit above in green, it would block the access to the parking spaces behind the hair salon building (shown in blue) and it would also affect the width of the proposed driveway, that would in turn affect the width of the proposed building fronting on Main Street. Below is the affected section of the code:

### 14-7-109 LANDSCAPING AND PERMISSIBLE LOT COVERAGE

- A. A lot or parcel with a single family or two family dwelling shall follow the lot coverage requirements of the R-4 subzone. All others, including multi-family and mixed-use developments, shall conform to the following criteria, in addition to any other requirements of this Title:
  - 1. All landscaping shall be sprinkled and planted with substantial live plant material for the purpose of buffering, screening and beautifying the site. At plant maturity, the landscaping should represent, as a minimum standard, compatibility with surrounding developed properties and uses and must be permanently maintained by the owner or occupants.
  - 2. With the exception of properties fronting on Main Street a minimum ten (10) feet wide landscape buffer shall be required along all frontage areas not occupied by drive accesses.
  - 3. A minimum ten (10) feet wide landscape buffer shall be established adjacent to a residential property.
  - 4. Parking, loading, and drive areas shall have a minimum five (5) feet wide landscape buffer when located adjacent to a side or rear property line, except for landscape buffering required between residential uses.
  - 5. Parking areas shall be landscaped as set forth in this Code.
  - 6. Approved landscaping must cover a minimum of ten (10) percent of the development site exclusive of any parkstrips in a public right-of-way. In addition to the minimum 10 percent required for all development, mixed-use and multifamily uses shall provide an additional 50 square feet of landscaping per residential unit.
  - 7. Landscaping shall also be installed in all parkstrips to the same standards as other on-site landscaping. Asphalt, concrete, bricks, pavers, railroad ties, rocks, gravel, and other non-vegetative material is not allowed in the parkstrip area between the curb and sidewalk.
- B. During the site plan approval process, the City may require more or less landscaping consistent with the provisions of the adopted Historic Downtown Plan

### **Analysis**

### Variance not required

It is Staff's opinion and recommendation that the Application does not qualify for a Variance and should be denied. In addition to the Application not meeting the legally required criteria for a variance, it is also important to note that the Applicant's project and goals can still be met without the need for a variance by complying with the following:

### 14-15-106 OFF-STREET PARKING – LAYOUT

 $[\ldots]$ 

B. Overall Design Concepts.

- 1. Parking lot design shall consider development on adjacent sites. The City may require cross access connections/easements to improve traffic circulation and to enhance public safety.
- 2. Traffic circulation patterns should direct commercial traffic onto arterial streets and not local/neighborhood streets. Multiple-family residential traffic should be directed onto collector streets. The City may deny access onto a local/residential street if access to a collector or arterial street is available.
- 3. A site plan should include landscaped buffers that separate pedestrian and vehicular traffic.

Staff recognizes that based on the location of the former/current/proposed access from Main Street leading to the parking spaces behind the neighboring property owner's building (458 South Main Street, hair salon site, building showin in blue) there is an area in conflict with the required landscape buffer as represented by the Applicant. This required 5-foot buffer also affects the proposed width of the driveway and building fronting Main Street. Due to the provision of the Code regarding cross access connection/easement, Staff finds that in this specific case, a Variance from the 5' landscape buffer requirement is not necessary as the only access to those parking spaces takes place over this area of conflict. If a cross access connection/easement is granted as required in the Code, the 5-foot landscape buffer, in conflict with the cross-access easement, would not be required. Staff finds that this scenario is a perfect example as to why the Code requires parking lot design to consider development on adjacent sites, and if appropriate, a cross access connections/easements would be required. Staff recognizes that not all sites qualify for this provision, but in this specific case, it is appropriate to do so, especially as the Applicant has recognized an unwritten prescriptive easement (verbally represented to staff) and mentioned on their narrative over the subject property for the benefit of the adjacent site.

Staff has communicated with the applicant how it finds that the Variance is not required by holding meetings with the applicant and in communication via e-mail.

### Variance Findings

Utah Code 10-9a-702 establishes the criteria for review of Variances as it indicates that: "Any person or entity desiring a waiver or modification of the requirements of a land use ordinance as applied to a parcel of property that he owns, leases, or in which he holds some other beneficial interest may apply to the applicable appeal authority for a variance from the terms of the ordinance". Furthermore, it also states that: "The applicant shall bear the burden of proving that all of the conditions justifying a variance have been met".

In order for the Planning Commission, as the designated body, to grant a Variance, all of the following criteria outlined in Utah Code 10-9-102(2)(a) outlined below as items *i-v* must be met:

(i) Literal enforcement of the ordinance would cause an <u>unreasonable hardship</u> for the applicant that is not necessary to carry out the general purpose of the land use ordinances;

Furthermore § 10-9a-702(2)(b) indicates:

- (i) In determining whether or not enforcement of the land use ordinance would cause <u>unreasonable hardship</u> under Subsection (2)(a), the appeal authority may not find an unreasonable hardship unless the alleged hardship:
  - (A) is located on or associated with the property for which the variance is sought; and
  - (B) comes from circumstances peculiar to the property, not from conditions that are general to the neighborhood.
- (ii) In determining whether or not enforcement of the land use ordinance would cause <u>unreasonable hardship</u> under Subsection (2)(a), the appeal authority may not find an unreasonable hardship if the hardship is self-imposed or economic.

**Applicant comment:** The literal enforcement of this ordinance is unreasonable for this property because it prevents the neighbor from the use of their required parking area to operate their business.

**Staff Response:** Staff recognizes that requiring the 5-foot landscape buffer keeps the adjacent property owner form accessing their property; however, the Applicant fails to acknowledge Land Use Code § 14-15-106(B)(1) which requires a cross connection/easement which would not require this same area to be landscaped. If the Applicant were to accept this provision, and provide such easement, there is no need for a Variance as the proposal would comply with the Code. The Applicant has not indicated that a Variance is sought for the required a cross access connections/easements. The alleged hardship in this case is self-imposed as there are other requirements of the Code that remove the required provision which the Applicant seeks a modification for. The Applicant has not demonstrated that the literal enforcement would cause an unreasonable hardship for the Applicant.

(ii) There are <u>special circumstances</u> attached to the property that do not generally apply to other properties in the same zone;

Furthermore § 10-9a-702(2)(c) indicates:

In determining whether or not there are <u>special circumstances</u> attached to the property under Subsection (2)(a), the appeal authority may find that special circumstances exist only if the special circumstances:

- (i) relate to the hardship complained of; and
- (ii) deprive the property of privileges granted to other properties in the same zone.

**Applicant Comment:** The special circumstance attached to the property is the neighboring building that is allowed access to park behind their building as shown in the exhibit above and on page C401 of the civil packet from the property owner of 400 S Main. Normally buildings would have their own access to their parking.

**Staff Response:** The Applicant acknowledges that the neighboring building/site is allowed access to park behind their building per their site plan. The Land Use Code indicates that parking lot design <u>shall</u> consider development on adjacent site. In specific cases, the City may require cross access connections/easements. Due to the current language of the Code, the specific situation at this site and the neighboring property, there is no special circumstance specially when the applicant acknowledges that the neighboring building is already allowed access to park behind their building through the Applicant's property. The applicant has not demonstrated that there are special circumstances attached to the property that do not generally apply to other properties in the same zone.

(iii) Granting the variance is essential to the enjoyment of a substantial property right possessed by other property in the same zone;

**Applicant Comment:** Therefore the granting of the variance is essential to the enjoyment of the neighboring property to allow business parking for their building.

**Staff Response:** Granting the variance is not essential to the enjoyment of a substantial property right as the Variance is not necessary. The Applicant has not demonstrated how granting the variance is essential to the enjoyment of a substantial property right possessed by other property in the same zone.

(iv) The variance will not substantially affect the general plan and will not be contrary to the public interest;

**Applicant Comment:** This in no way affects the general plan negatively, however it positively contributes to the general plan which is to achieve its goals and provide ample parking for the businesses.

**Staff Response:** Granting the Variance would not substantially affect the general plan nor will it be contrary to the public interest; however, the reason demonstrated ignores other provisions of the Code which does not require a Variance at all. As cited by the Applicant herein: "*Providing ample parking for the businesses*" can clearly be accomplished by following the Code and providing the cross access connection/easement.

(v) The spirit of the land use ordinance is observed and substantial justice done

**Applicant Comment:** [None provided by applicant].

**Staff Response:** The spirit of the land use ordinance (Code) is not observed, and substantive justice is not done/followed as the applicant chooses to follow an unnecessary Variance. The desired outcome, exact same proposal, can be accomplished by complying with the Code by providing the required cross access connection/easement.

<u>Additional.</u> The Applicant included the following in their submitted narrative:

How does the proposed variance request meet all of these criteria?

• In our study of the ordinance section 14-7-109 part B states "The City may require more or less landscaping." Within this statement it allows the process of the site plan to make a change to this ordinance. We feel that our project meets the criteria set forth in Utah Code 10-9a-702 and should be allowed to go to site plan and have the planning commission and city council govern what will be required.

**Staff Response:** Staff does not dispute that more or less landscaping needs to be provided. Staff acknowledges that another section of the Land Use code is required to be considered which then qualifies for the required cross access connection/easement. The same argument is made herein that Staff does find necessary to require this area to be landscaped as this same subject area would serve as an official access easement for the benefit of the neighboring property owner to the south.

### **Department Review**

This staff report was written by the Planning Director and reviewed by the City Attorney.

### **Significant Impacts**

Formalizing the cross-access connection/easement instead of having "a handshake agreement between property owners of some sort" eliminates any possible future conflict and complies with the Land Use Code.

If the Planning Commission grants this Variance to modify (not require) the 5-foot landscaping buffer, it does not remove provision of the Code. The City would be required to follow the Code in the administrative applications (Conditional Use Permit and Architectural Site Plan Review) by requiring the cross access connection/easement. Issuing a Variance for the 5-foot landscaping buffer does not alleviate required cross access connection/easement outlined in 14-15-106 Off-Street Parking – Layout.

### Recommendation

Staff recommends that the Planning Commission hold a public hearing, review the requested Variance Request, and deny the Variance Request based on the analysis provided herein of the required review criteria from State Law.

### **Attachments**

- 1. 4<sup>th</sup> & Main Variance Questions/Narrative
- 2. Sheet C401 Variance Sheet
- 3. Update Plans (Submitted October 18, 2022)
- **4.** Utah State Code § 10-9a-702



# Variance Application explanation for Bountiful property (address: 400 S Main Street)

The proposed Variance Application is to allow the owner of 400 S Main Street a variance from installing a 5' landscape buffer per ordinance 14-7-109 of Bountiful City. As noted in the above illustration the landscape buffer would prevent the adjacent owner from using their parking stalls.

What City Ordinance(s) do you want a variance from? Chapter 7 in the Downtown Zone.

### 14-7-109 LANDSCAPING AND PERMISSIBLE LOT COVERAGE

- A. A lot or parcel with a single family or two-family dwelling shall follow the lot coverage requirements of the R-4 subzone. All others, including multi-family and mixed-use developments, shall conform to the following criteria, in addition to any other requirements of this Title:
  - Parking, loading, and drive areas shall have a minimum five (5) feet wide landscape buffer when located adjacent to a side or rear property line, except for landscape buffering required between residential uses.
- B. During the site plan approval process, <u>the City may require more or less landscaping</u> consistent with the provisions of the adopted Historic Downtown Plan.

By Law, any government body granting a variance must find that the proposal meets ALL of the requirements of Utah Code 10-9a-702 (below).

How does the proposed variance request meet all of these criteria?

- In our study of the ordinance section 14-7-109 part B states "The City may require more or less landscaping." Within this statement it allows the process of the site plan to make a change to this ordinance. We feel that our project meets the criteria set forth in Utah Code 10-9a-702 and should be allowed to go to site plan and have the planning commission and city council govern what will be required.
- i. The literal enforcement of this ordinance is unreasonable for this property because it prevents the neighbor from the use of their required parking area to operate their business.

- ii. The special circumstance attached to the property is the neighboring building that is allowed access to park behind their building as shown in the exhibit above and on page C401 of the civil packet from the property owner of 400 S Main. Normally buildings would have their own access to their parking.
- iii. Therefore the granting of the variance is essential to the enjoyment of the neighboring property to allow business parking for their building.
- iv. This in no way affects the general plan negatively, however it positively contributes to the general plan which is to achieve its goals and provide ample parking for the businesses.

### MAIN STREET GOALS AND POLICIES


**Economic Development** 

### 1. Goal:

### Help establish an identity for the Historic Fort.

Provide diverse economic and employment opportunities and encourage multiple scales of commercial development to serve the needs of the region, the community, and individual neighborhoods.

• v. The spirit of the land use ordinance is observed with this variance as the neighboring property has existed for over 50 years has never had a landscape buffer. We will be adding a landscape buffer on 400 S Main in all locations except the property we don't have controlling interest.

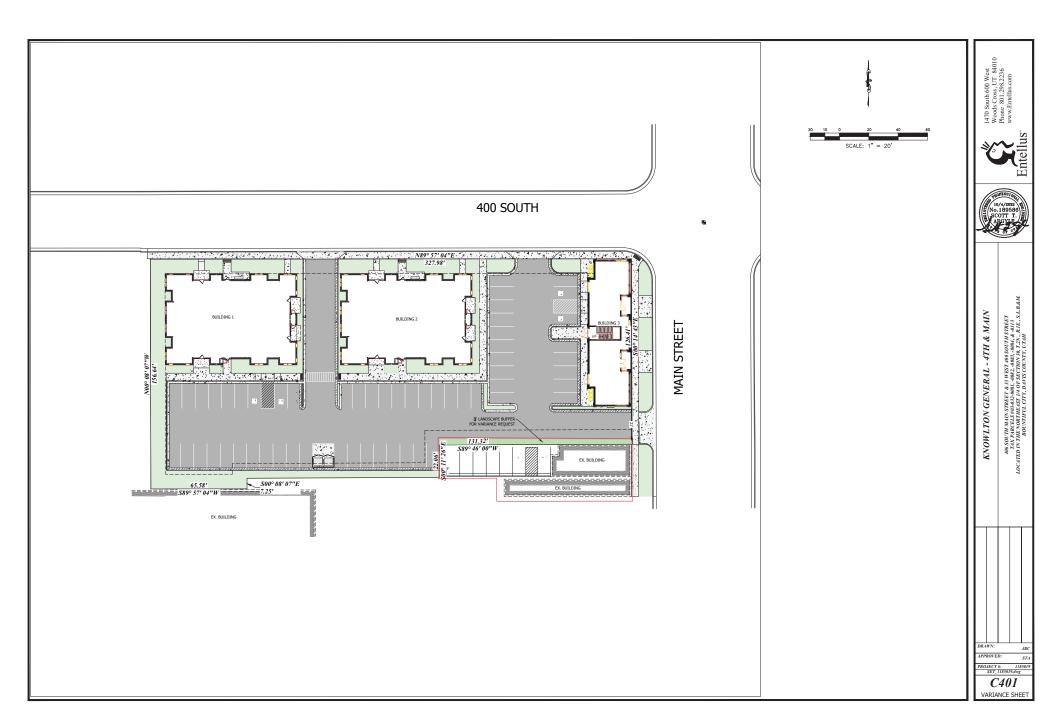



# KNOWLTON GENERAL - 4TH AND MAIN



406 SOUTH MAIN STREET & 33 WEST 400 SOUTH STREET TAX PARCELS #03-032-0081, -0082, -0083, -0084, & -0113 LOCATED IN THE NE 1/4 OF SECTION 30, T. 2 N., R. 1 E., S.L.B.&M. BOUNTIFUL CITY, DAVIS COUNTY, UTAH

### **VICINITY MAP**



### **DRAWING INDEX**

C100	COVER
C101	NOTES & LEGEND
C200	TOPOGRAPHIC SURVEY
C201	<b>BOUNDARY SURVEY</b>
C300	DEMOLITION PLAN
C400	SITE PLAN
C401	VARIANCE SHEET
C500	GRADING PLAN
C600	UTILITY PLAN
C700	PLAN & PROFILE
C900	SITE DETAILS
C910	UTILITY DETAILS
C920	CITY UTILITY DETAILS
C921	CITY DETAILS
C930	STORMTECH DETAILS
EC100	EROSION CONTROL
L1.1	LANDSCAPE PLAN
TOTAL SHEETS	17



### GENERAL NOTES

1) ALL WORK WITHIN A PUBLIC RIGHT-OF-WAY SHALL CONFORM TO THE RIGHT-OF-WAY OWNER'S STANDARDS & SPECIFICATIONS.

2) ALL UTILITY WORK SHALL CONFORM TO THE UTILITY OWNER'S STANDARDS & SPECIFICATIONS.

3) THESE PLANS DO NOT INCLUDE DESIGN OF DRY UTILITIES. THESE PLANS MAY CALL FOR RELOCATION, AND/OR REMOVAL AND/OR CONSTRUCTION OF DRY UTILITIES, BUT ARE NOT OFFICIAL DRAWNINGS FOR SUCH. DESIGN AND COORDINATION OF DRY UTILITIES IS BY OTHERS.

4) THE CONTRACTOR SHALL COORDINATE AND OBTAIN ANY PERMITS REQUIRED FOR THE WORK SHOWN HEREON.

5) THE LOCATION AND LEDATIONS OF IMPOSEDUED STILLTIES SHOWN ON THESE SANS 24 AREST ESTIMAN BOSED ON LITTLE COMMAN RECORDS, BLEEFINES, AND IN-MANUREPHOTE OF FAMILY ORGENWARE AND/F, GOUND FAILURES, AS SICH, THIS IMPOSIMATION MAY OTE COMMELTE, UP-TO-DATE, OR ACCURATE. IT IS THE CONTINGENOR RESPONSIBILITY TO STOP WORK AND NOTIFY THE ENGINEER IF CONFLICTING INFORMATION IS FOUND IN THE FIELD.

 THE CONTRACTOR IS TO FIELD VERIFY THE LOCATION AND ELEVATIONS OF EXISTING MANHOLES AND OTHER UTILITIES PRIOR TO STAKING AND CONSTRUCTION.

7) CALL BLUESTAKES AT LEAST 48 HOURS PRIOR TO DIGGING. DO NOT PROCEED UNTIL BLUESTAKES ARE MARKED.

8) IT SHALL BE THE CONTRACTOR'S AND SUBCONTRACTOR'S RESPONSIBILITY TO MEET ALL APPLICABLE HEALTH AND SAFETY REGLATIONS, AND SHALL ASSUME SOLE RESPONSIBILITY FOR JOB-SITE CONDITIONS DURING CONSTRUCTION OF THIS PROJECT, 50 THAT ALL EMPLOYEES ARE PROVIDED A SAFE PLACE TO WORK, AND THE PUBLIC IS PROTECTED...







BENCHMARK: NAIL IN SIDEWALK, NW CORNER ELEVATION: 4390.17








1470 South 600 West Woods Cross, UT 84010 Phone 801.298.2236 www.Entellus.com

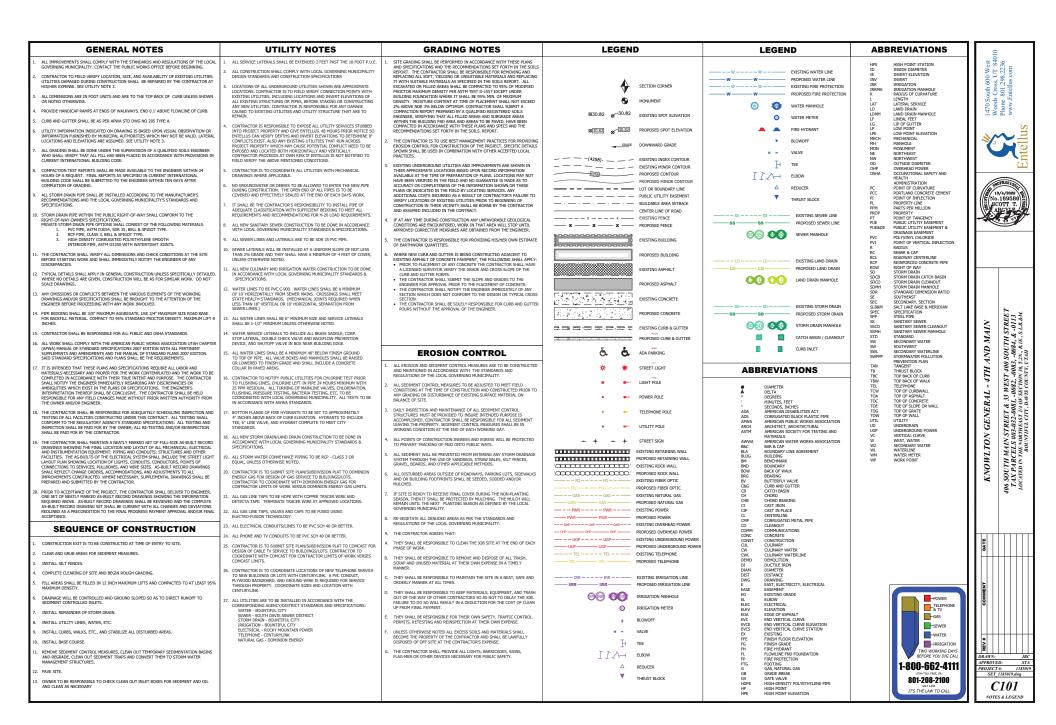


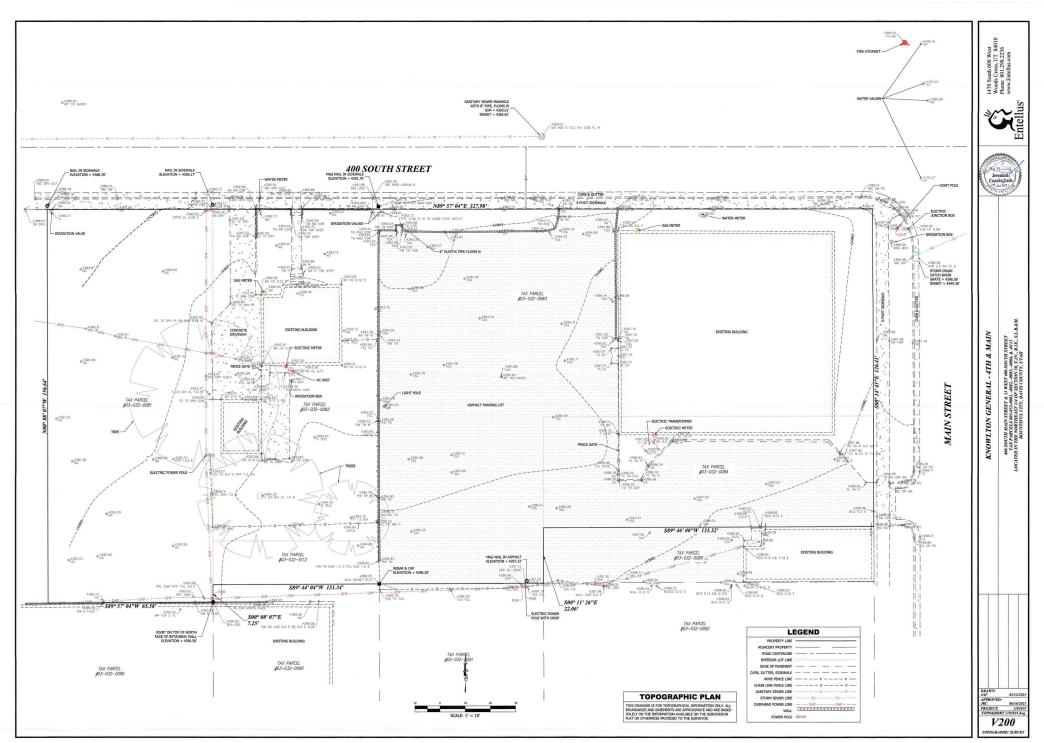


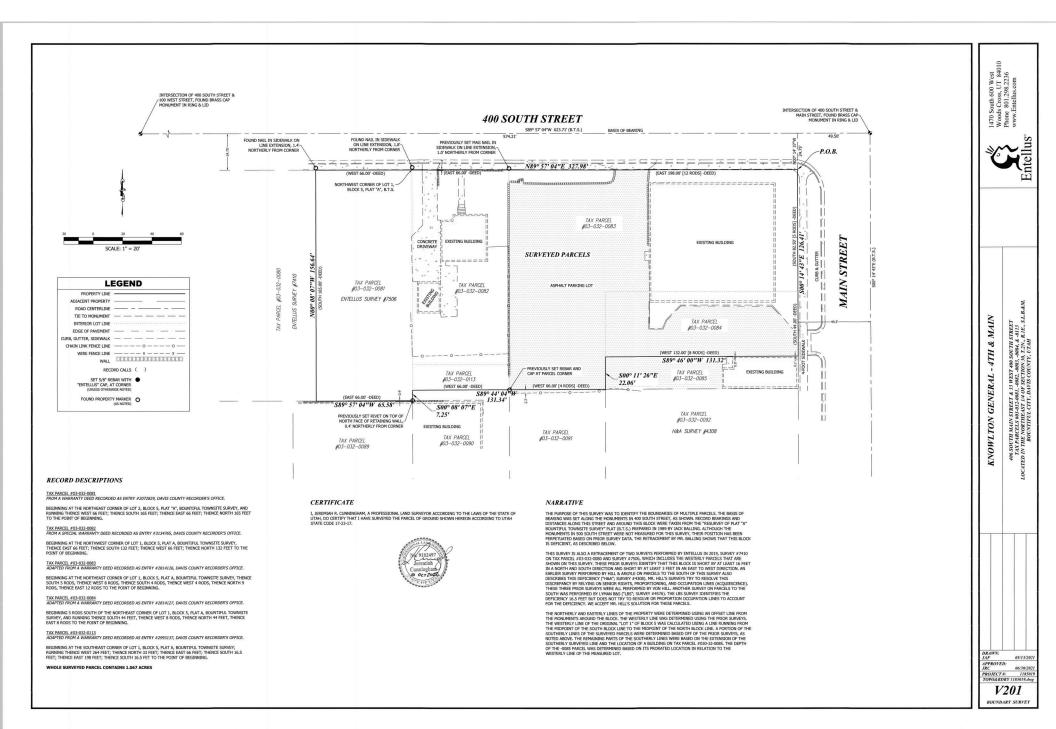


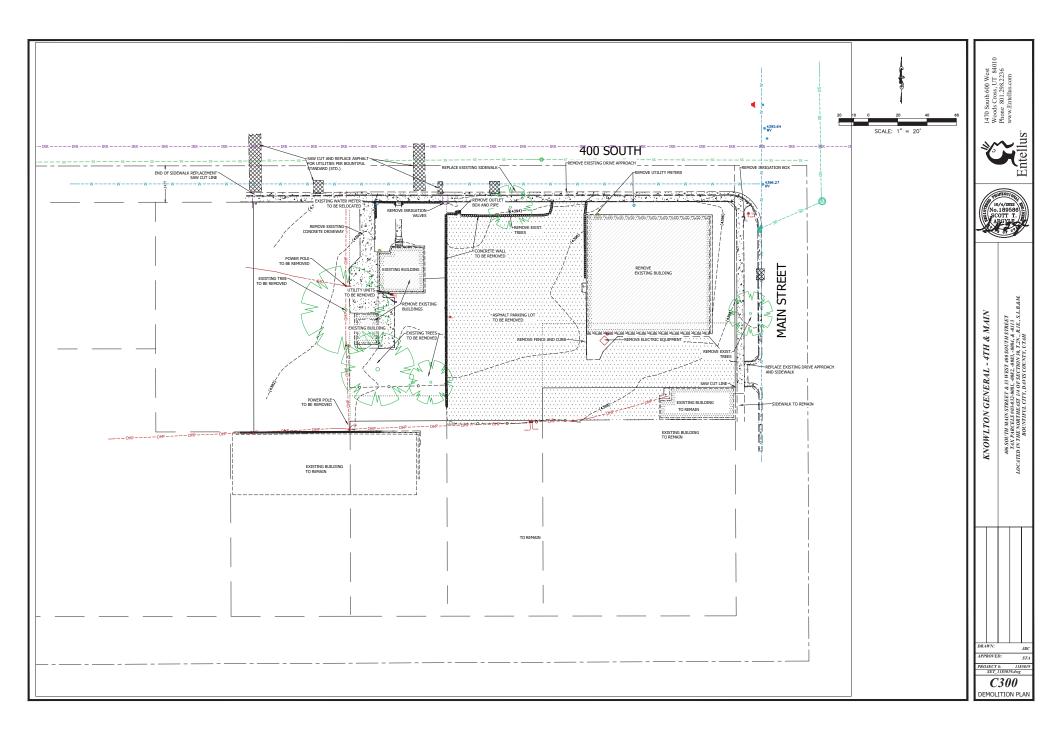


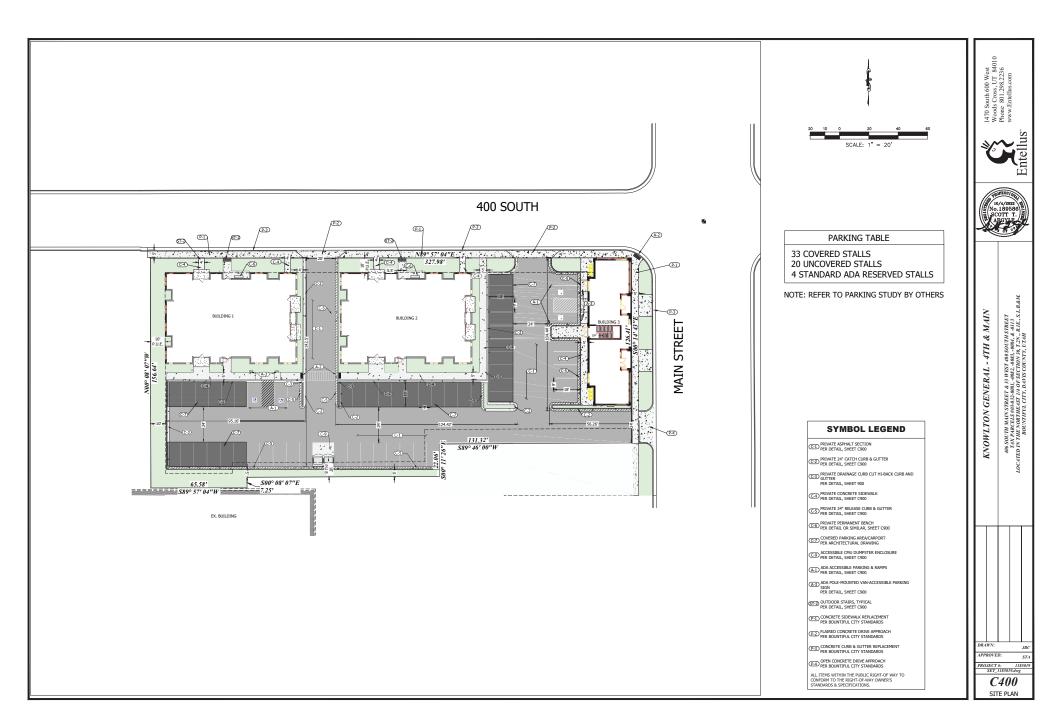


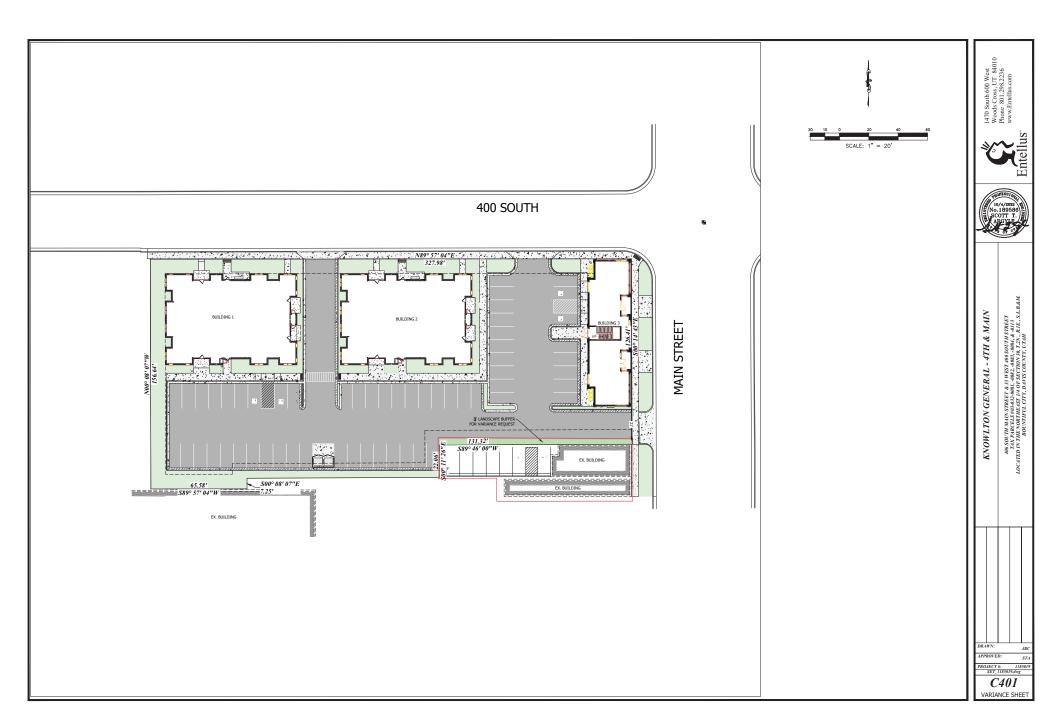


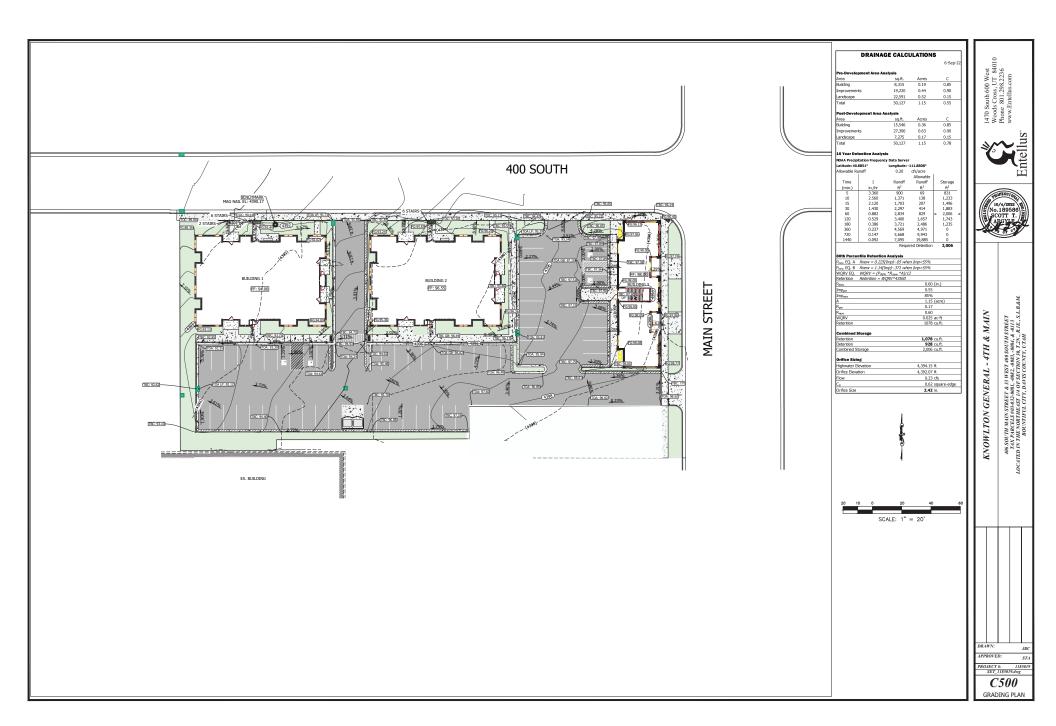


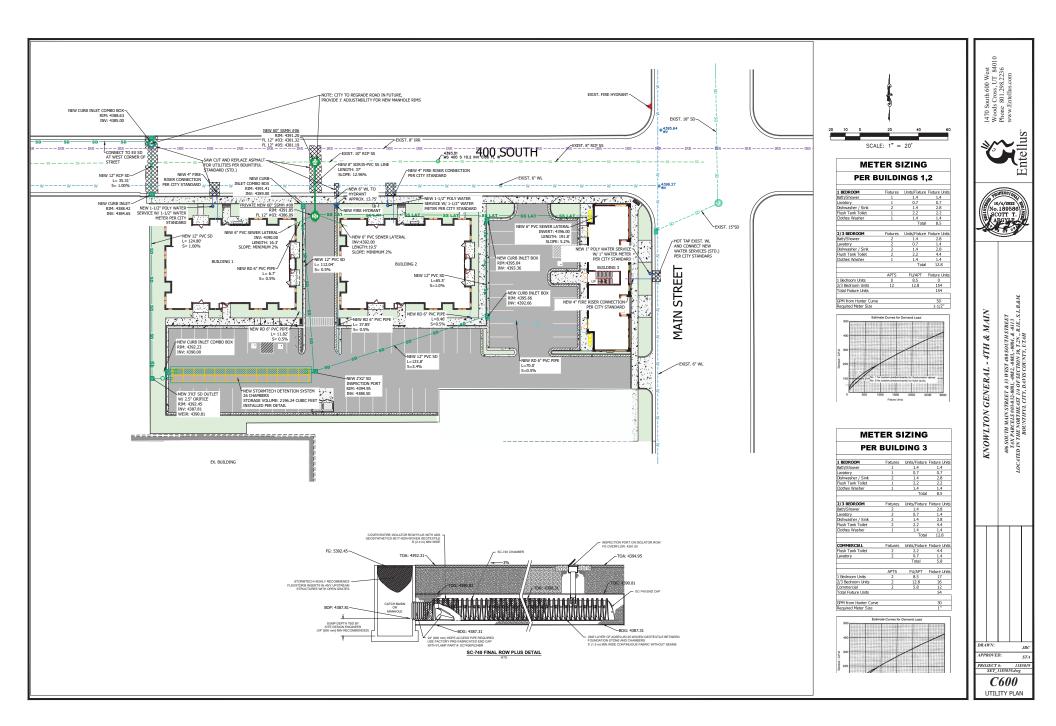


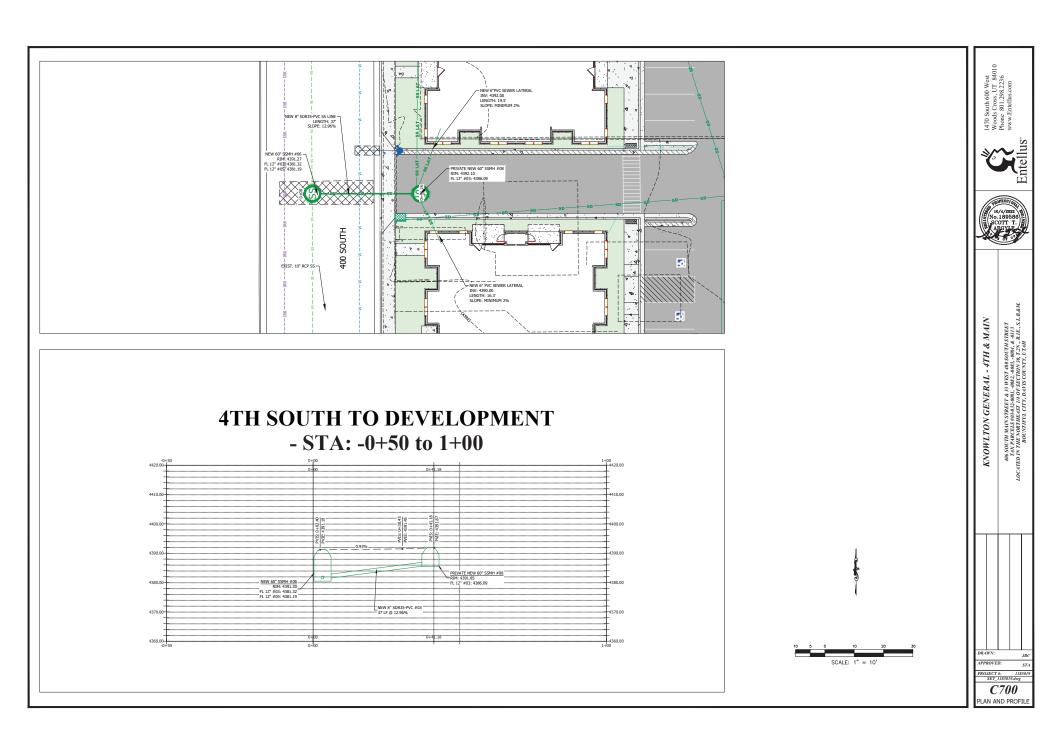


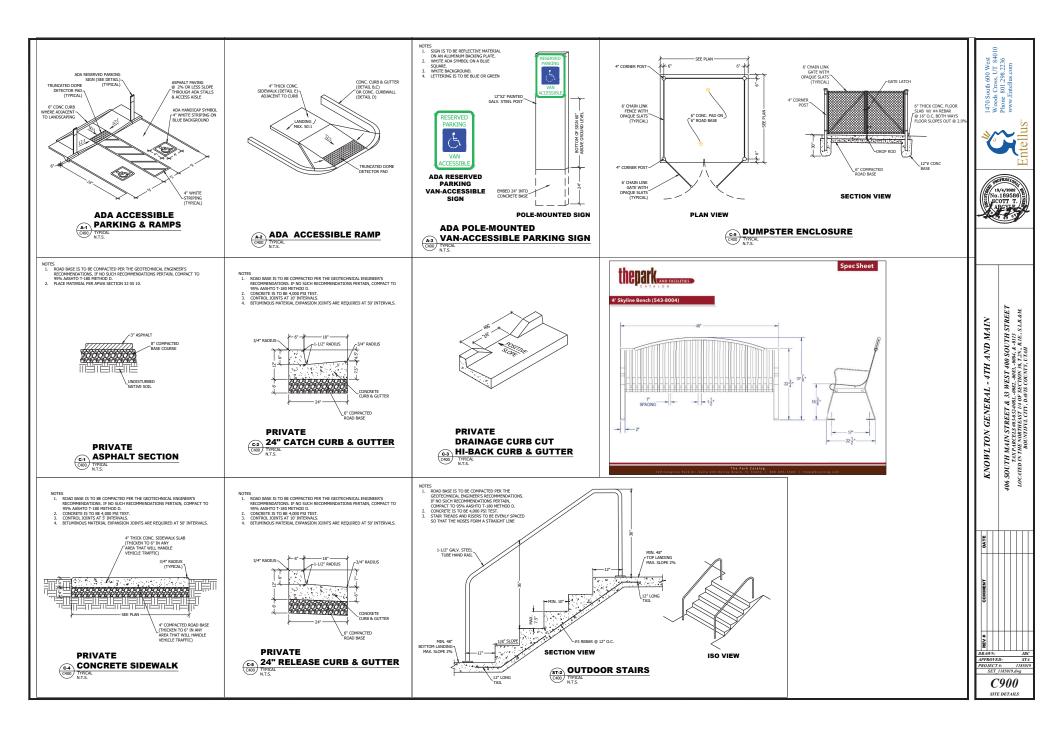


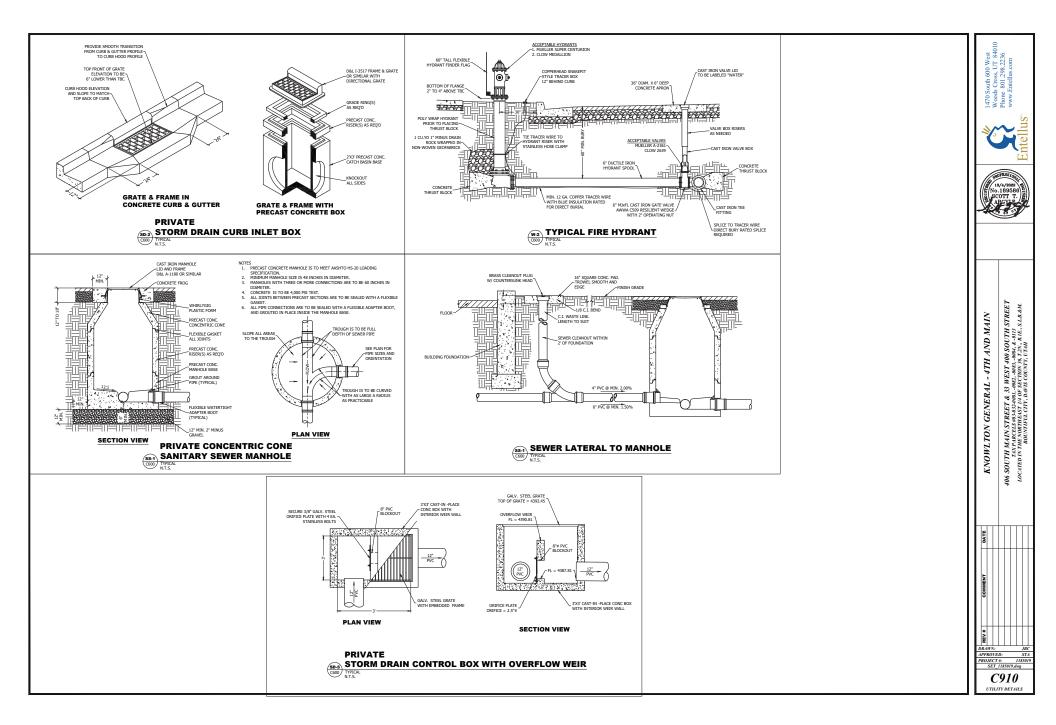

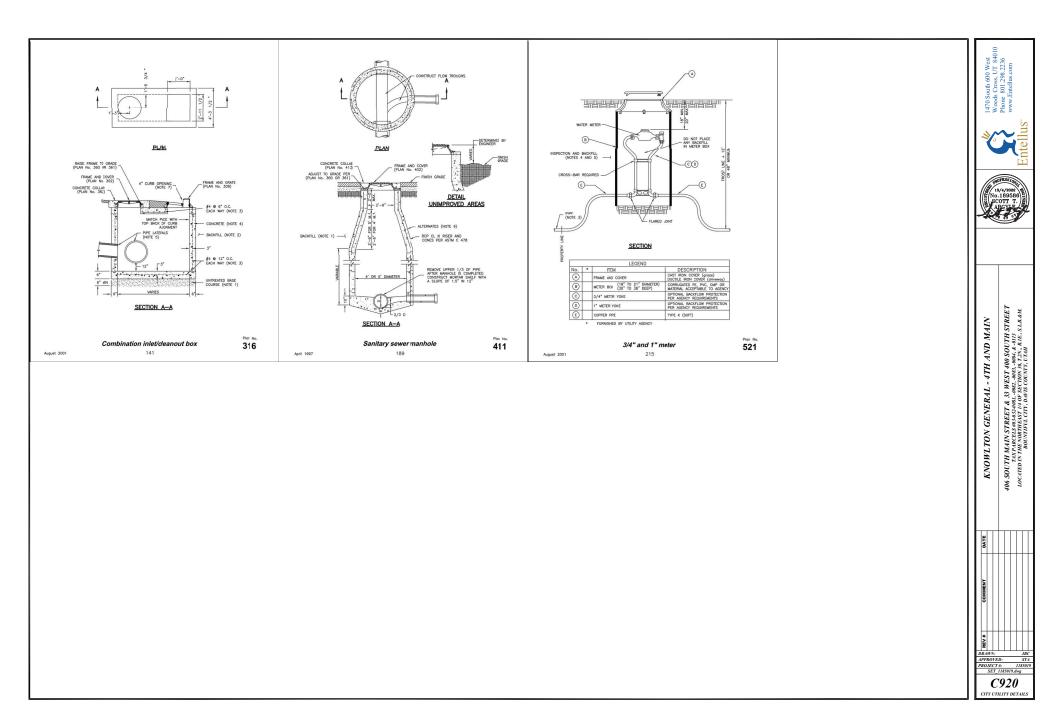

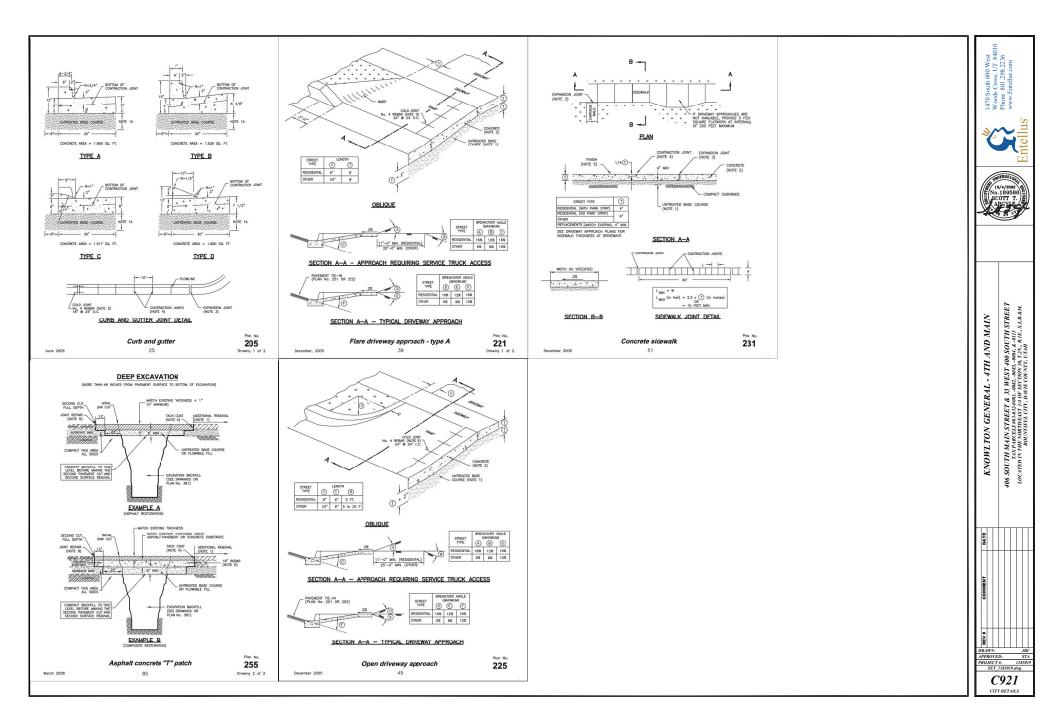

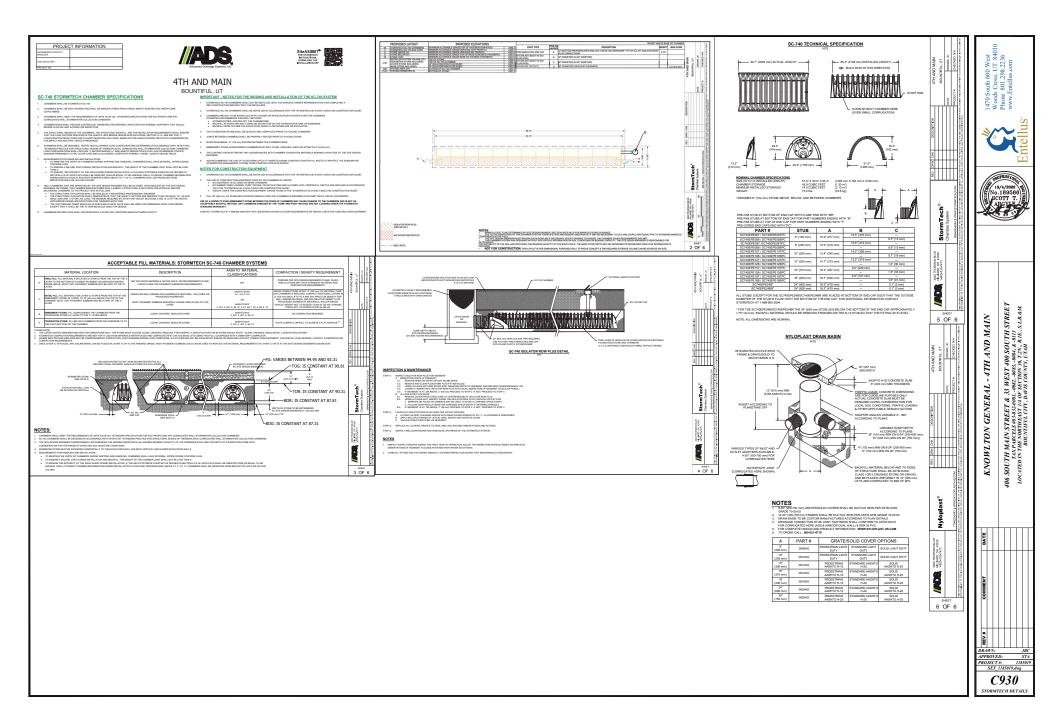

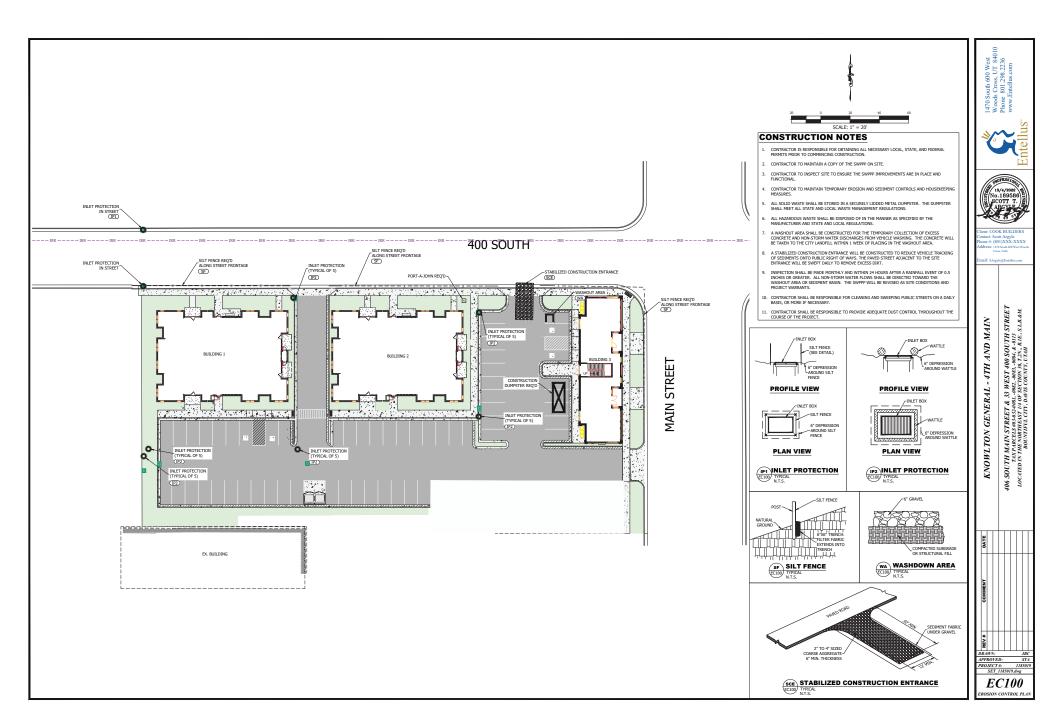

# 10-9a-702 Variances.

(1) Any person or entity desiring a waiver or modification of the requirements of a land use ordinance as applied to a parcel of property that he owns, leases, or in which he holds some other beneficial interest may apply to the applicable appeal authority for a variance from the terms of the ordinance.

(2)

- (a) The appeal authority may grant a variance only if:
  - (i) literal enforcement of the ordinance would cause an unreasonable hardship for the applicant that is not necessary to carry out the general purpose of the land use ordinances;
  - (ii) there are special circumstances attached to the property that do not generally apply to other properties in the same zone;
  - (iii) granting the variance is essential to the enjoyment of a substantial property right possessed by other property in the same zone;
  - (iv) the variance will not substantially affect the general plan and will not be contrary to the public interest; and
  - (v) the spirit of the land use ordinance is observed and substantial justice done.

(b)

- (i) In determining whether or not enforcement of the land use ordinance would cause unreasonable hardship under Subsection (2)(a), the appeal authority may not find an unreasonable hardship unless the alleged hardship:
  - (A) is located on or associated with the property for which the variance is sought; and
  - (B) comes from circumstances peculiar to the property, not from conditions that are general to the neighborhood.
- (ii) In determining whether or not enforcement of the land use ordinance would cause unreasonable hardship under Subsection (2)(a), the appeal authority may not find an unreasonable hardship if the hardship is self-imposed or economic.
- (c) In determining whether or not there are special circumstances attached to the property under Subsection (2)(a), the appeal authority may find that special circumstances exist only if the special circumstances:
  - (i) relate to the hardship complained of; and
  - (ii) deprive the property of privileges granted to other properties in the same zone.
- (3) The applicant shall bear the burden of proving that all of the conditions justifying a variance have been met.
- (4) Variances run with the land.
- (5) The appeal authority may not grant a use variance.
- (6) In granting a variance, the appeal authority may impose additional requirements on the applicant that will:
  - (a) mitigate any harmful affects of the variance; or
  - (b) serve the purpose of the standard or requirement that is waived or modified.

Renumbered and Amended by Chapter 254, 2005 General Session

# **Planning Commission Staff Report**



**Subject:** Election of Planning Commission Chairperson and Vice-Chair

**Authors:** Francisco Astorga, AICP, Planning Director

Date: December 6, 2022

# **Background**

Under Bountiful City Land Use Code Section 14-2-102(C)(1) below, the Planning Commission elects a chairperson and vice-chair that serves for one (1) year.

C. Organization and Procedure. The Planning Commission shall be organized and exercise its powers and duties as follows:

- 1. Members of the Planning Commission shall select one (1) of its members as chair to oversee the proceedings and activities of the Planning Commission.
  - a. The chairperson shall serve for a term of one (1) year.
  - b. Members of the Planning Commission shall select one (1) of its members as vice-chair to act in the absence of the chair. The chair and vice-chair may be re-elected for successive terms.

# **Analysis**

It is now time to select the 2023 Planning Commission chairperson and vice-chair as their appointment expired in 2022.

# **Significant Impacts**

There are no significant impacts from this procedural action.

#### Recommendation

It is recommended that the Planning Commission select a chairperson and vice-chair via motion, second, and vote.

#### Attachment

1. None

# **Planning Commission Staff Report**



**Subject:** Public Notice of Planning Commission's 2023 Meeting Schedule

**Authors:** Francisco Astorga, AICP, Planning Director

Date: December 6, 2022

# **Background**

Under Utah Code <u>Section 52-4-202</u> (Chapter 4 Open and Public Meetings Act), "a public body which holds regular meetings that are scheduled in advance over the course of a year shall give public notice at least once each year of its annual meeting schedule as provided in this section." This section applies to Planning commission meetings.

# **Analysis**

The Planning Commission is to meet on a regular basis, as determined by a vote of the members, and at such other times as Commission members may determine. Staff recommends maintaining the current schedule of meeting on the first  $(1^{st})$  and third  $(3^{rd})$  Tuesday of every month reflected on the drafted notice.

The Planning Department is unsure if a meeting will take place on December 19, 2023, which would be the last meeting of the year, where this public notice is reviewed by the Commission as required by Utah Code.

# **Department Review**

This staff report and the Public Notice were written by the Planning Director and reviewed by the City Attorney.

# **Significant Impacts**

There are no significant impacts from this procedural action.

# Recommendation

Staff recommends that the Planning Commission approve the Public Notice of Bountiful City Planning Commission 2023 meetings schedule to meet on the first (1st) and third (3<sup>rd</sup>) Tuesdays of month.

#### Attachment

1. Public Notice of Bountiful City Planning Commission 2023 Meetings

#### PUBLIC NOTICE

Pursuant to UCA 52-4-202(2), the City of Bountiful Planning Commission hereby gives public notice of its annual meeting schedule for 2023. Regular meetings of the Planning Commission shall take place the first (1<sup>st</sup>) and third (3<sup>rd</sup>) Tuesdays of each month, unless otherwise advertised by legal notice. All Planning Commission meetings shall be held at the Bountiful City Hall located at 795 South Main Street, Bountiful, Utah 84010 until further notice or unless otherwise advertised. The meetings will begin promptly at 6:30 p.m.

All meetings of the Planning Commission shall be open to the public.

In addition to the above scheduled regular meetings, the Planning Commission may, from time to time, meet in special sessions as needed, and such meetings will be advertised by legal notice to the public in accordance with UCA 52-4-202.

Dated this 30th day of December 2022.

Francisco Astorga
Bountiful City Planning Director